
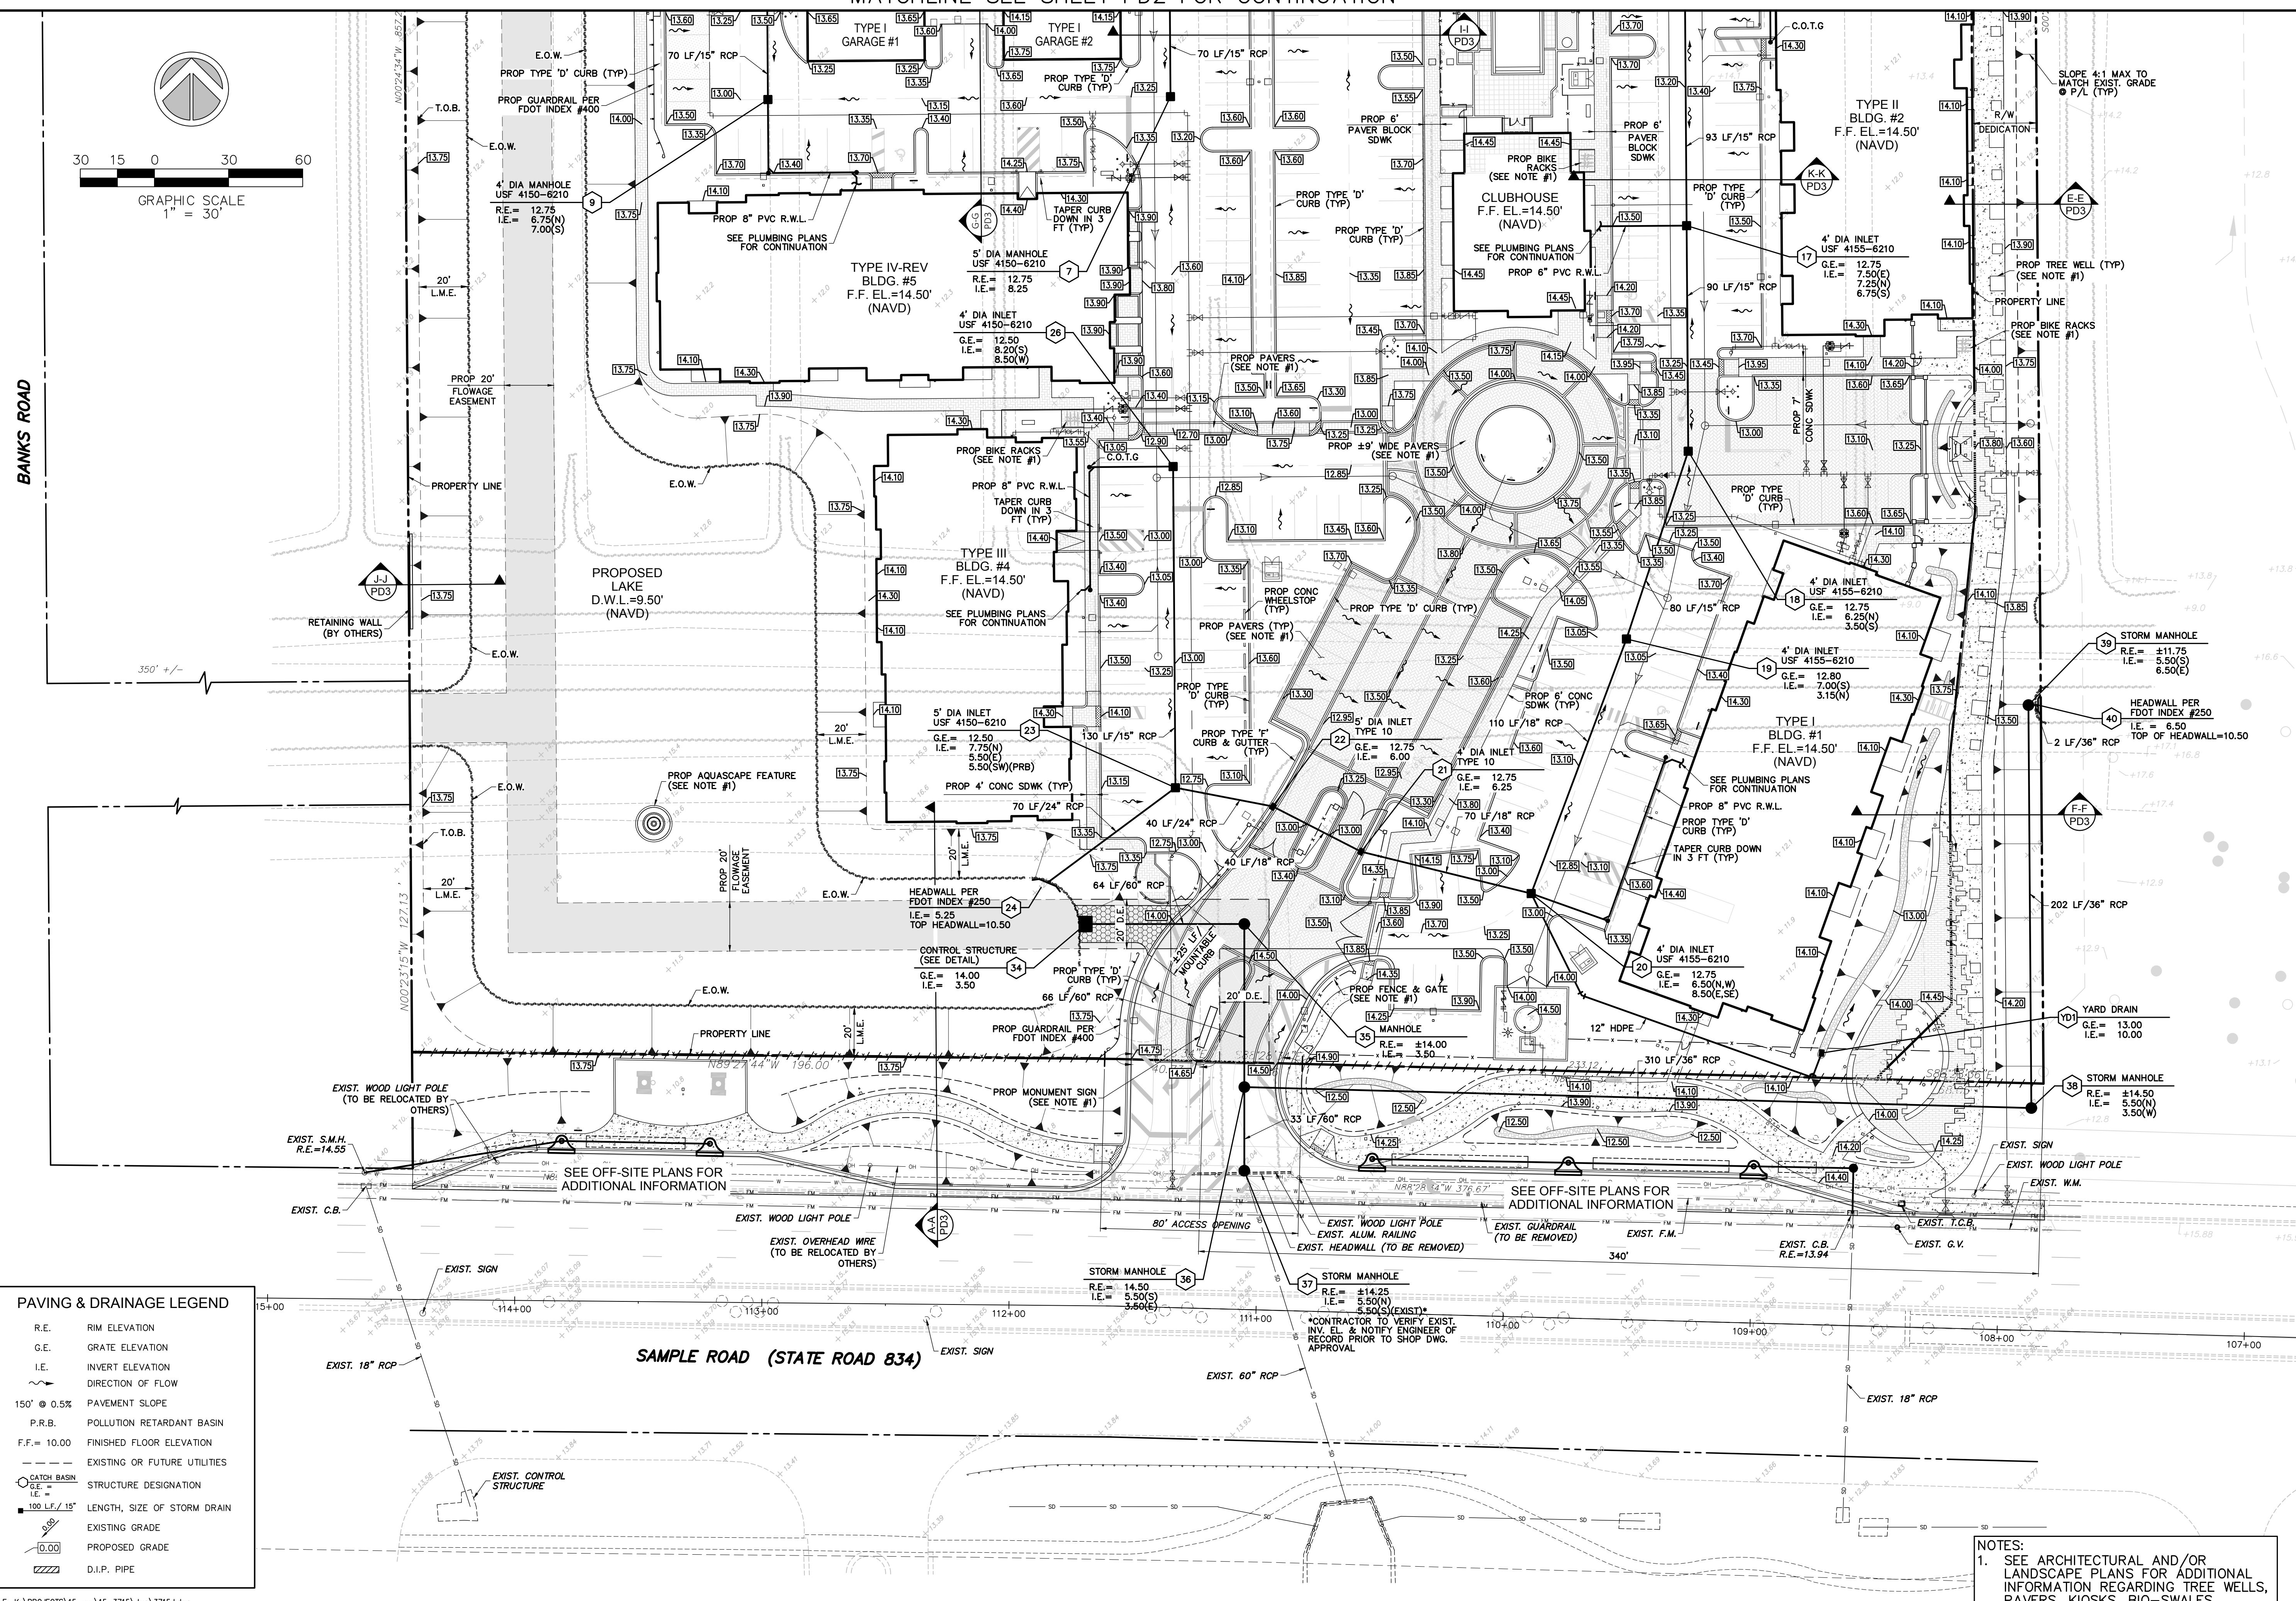


MATCHLINE SEE SHEET PD2 FOR CONTINUATION

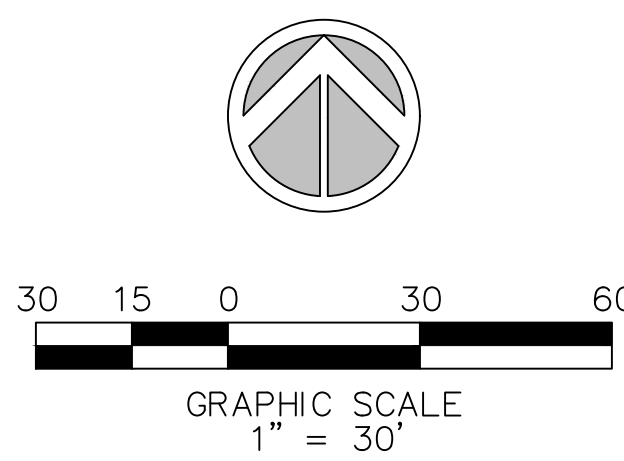

PAVING & DRAINAGE LEGEND

R.E.	RIM ELEVATION
G.E.	GRATE ELEVATION
I.E.	INVERT ELEVATION
→	DIRECTION OF FLOW
150' @ 0.5%	PAVEMENT SLOPE
P.R.B.	POLLUTION RETARDANT BASIN
F.F. = 10.00	FINISHED FLOOR ELEVATION
---	EXISTING OR FUTURE UTILITIES
○	CATCH BASIN
○	STRUCTURE DESIGNATION
○	LENGTH, SIZE OF STORM DRAIN
○	EXISTING GRADE
○	PROPOSED GRADE
○	D.I.P. PIPE

NOTES:
 1. SEE ARCHITECTURAL AND/OR LANDSCAPE PLANS FOR ADDITIONAL INFORMATION REGARDING TREE WELLS, PAVERS, KIOSKS, BIO-SWALES, BENCHES, BIKE RACKS, ETC.

FILE: K:\PROJECTS\15-xxx\15-3715\dwg\3715d.dwg
 PLOT DATE: 1/20/2016 4:17 PM BY: Andy Venneman
 LAYOUT: [C-2.1]

Sun-Tech Engineering, Inc.
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REVISIONS

NO.	DATE	DESCRIPTION

MIDTOWN RESIDENCES @ COCONUT CREEK
 COCONUT CREEK FLORIDA
PAVING, GRADING & DRAINAGE PLAN

DATE:
Oct. 2015

SCALE:
1" = 30'

DESIGNED BY:
C.R.L.

DRAWN BY:
A.E.V.

JOB NUMBER
15-3715

SHEET No.
C-2.1

SEAL
Jan 20 2016
CLIFFORD R. LOUTAN, P.E.
FL. REG. NO. 56890