



BUILDING DATA	
WIND VELOCITY (mph)	140
IMPORTANCE FACTOR	1.00
BUILDING CATEGORY	II
EXPOSURE CATEGORY	C
INTERNAL PRESSURE COEFFICIENT +/- (ENCLOSED BUILDING)	0.18
MEAN ROOF HEIGHT (ft)	17.92'
BUILDING WIDTH (ft)	60.11'
BUILDING LENGTH (ft)	84.83'
ROOF SLOPE (X : 12)	0

FLORIDA BUILDING CODE - 2007 -
DESIGN PRESSURES FOR OPENINGS

OPENING MARK	OPENING DESCRIPTION	LOCATION ZONE	OPENING ELEVATION	OPENING WIDTH	OPENING HEIGHT	MAX POSITIVE PRESSURE psf	MAX NEGATIVE PRESSURE psf
A	GLASS DOOR	4	3.5	3	7	38.7	-42.1
B	FIXED GLASS	4	8	3	2	40.6	-44.0
C	FIXED GLASS	4	9.25	3	7.5	38.5	-41.9
D	FIXED GLASS	5	6	2	6	40.1	-53.2
E	FIXED GLASS	5	6	1.34	6	40.1	-53.2
F	FIXED GLASS	4	8	6	2	40.1	-43.5
G	FIXED GLASS	5	7.23	4	2	40.6	-54.1
H	SERVICE WINDOW	5	4.67	2	3	40.6	-54.1

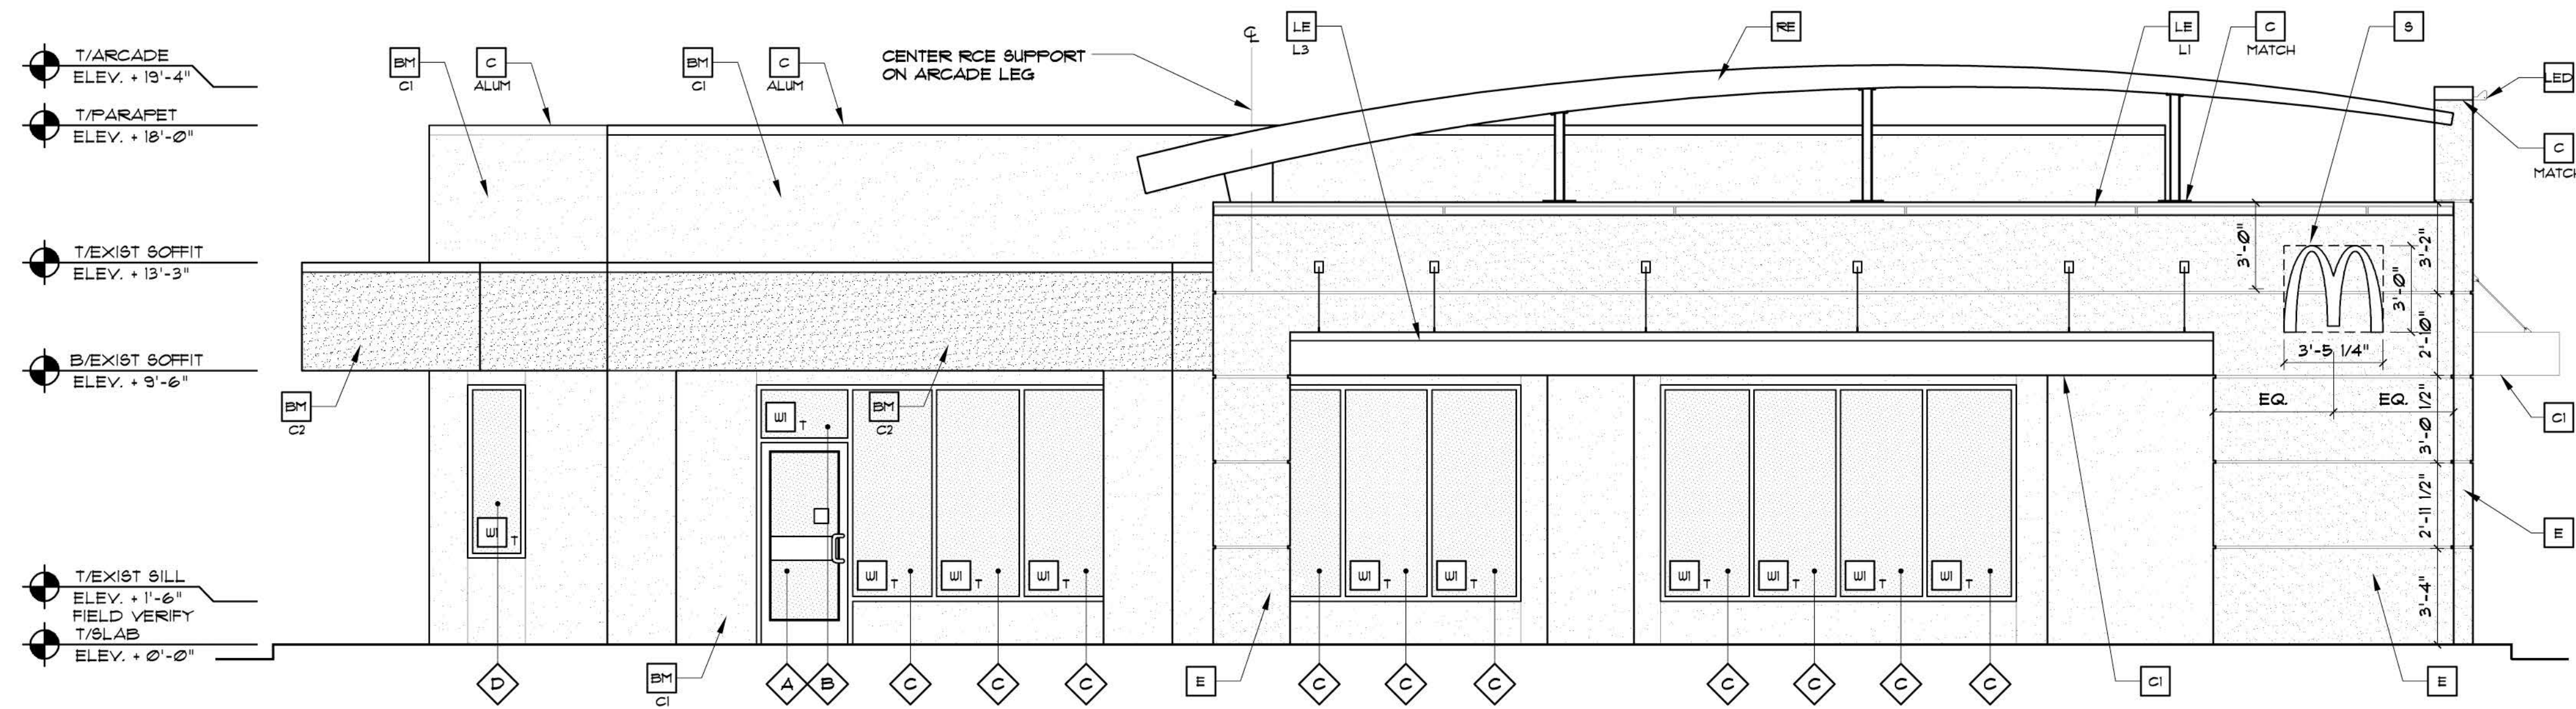

1 FRONT / NORTH ELEVATION
1/4" = 1'-0"

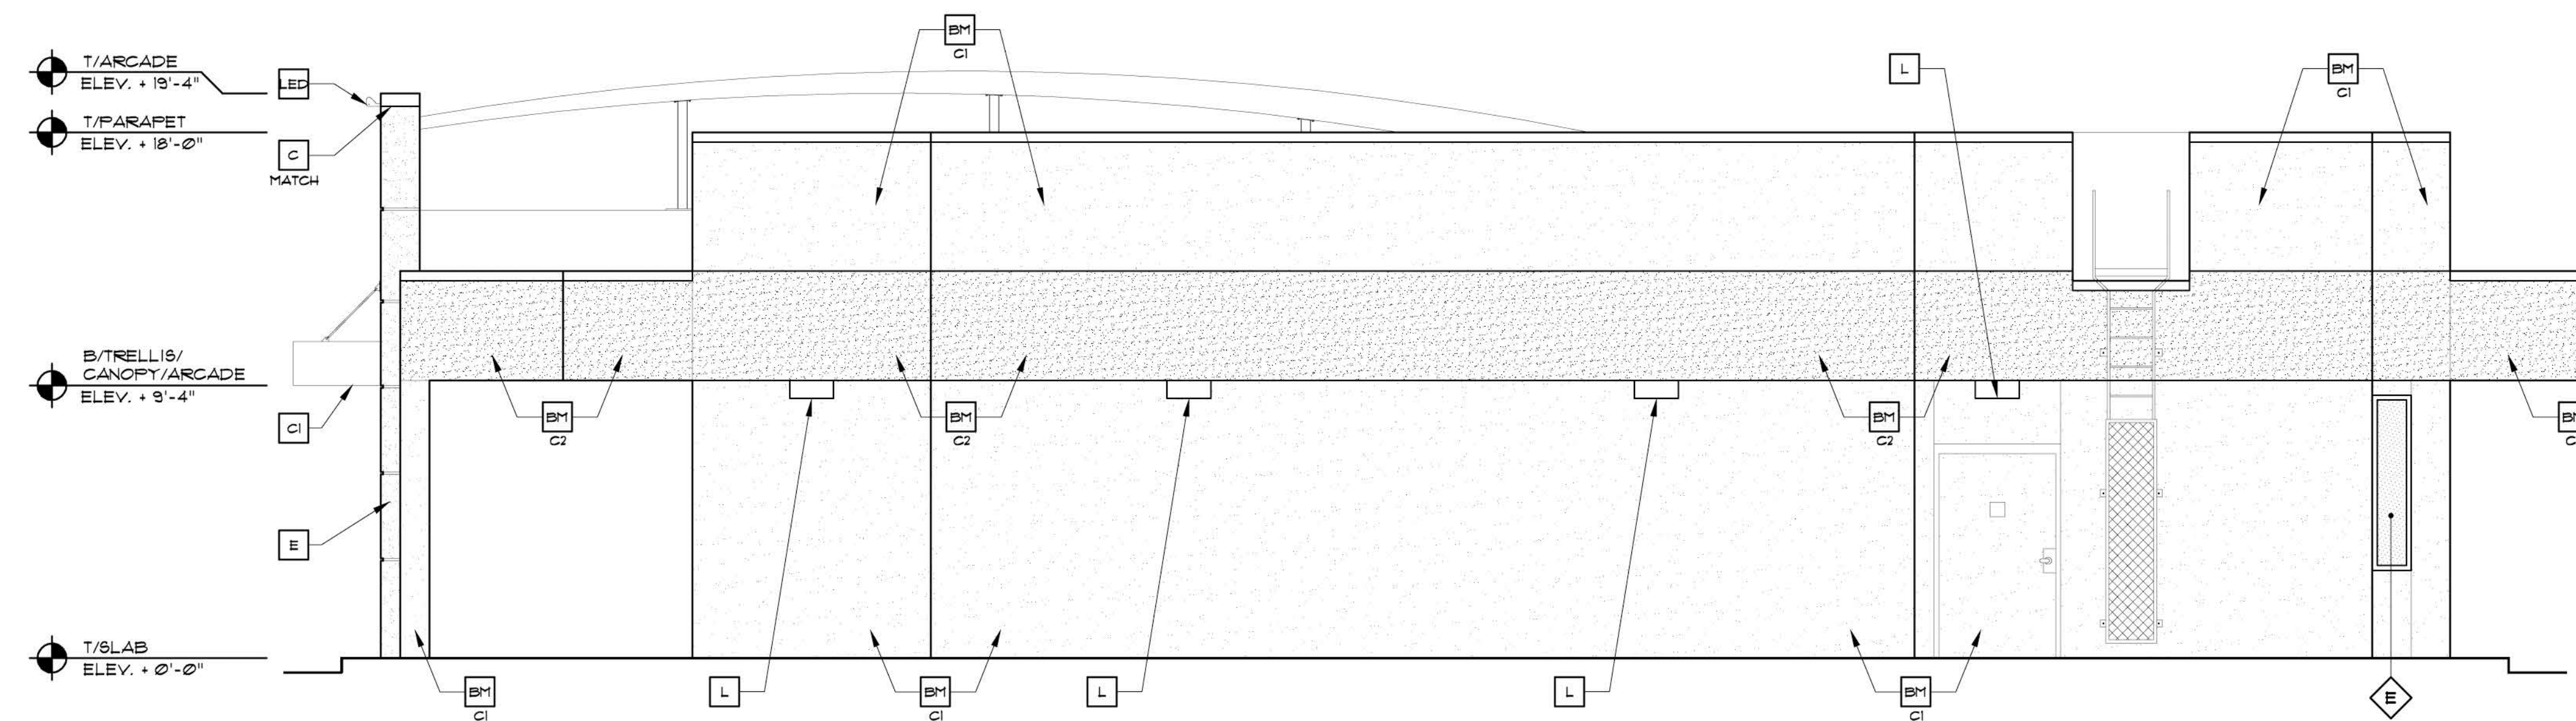


2 REAR / SOUTH ELEVATION
1/4" = 1'-0"

ENTIRE PAGE

- KEY NOTES:**
- A METAL FINISH - UNDER SEPARATE PERMIT, COLOR TO BE ALTERNATING STRIPES TO MATCH PANTONE 123C AND 109C
 - BM NEW CEMENTITIOUS FINISH
 - C1 COLOR: SHERWIN WILLIAMS SOCIABLE 6353
 - C2 COLOR: CHOICE CREAM 6351
 - C METAL COPING - COLOR: ALUMINUM
 - C1 METAL COPING - COLOR TO MATCH SURROUNDING MATERIAL
 - C2 NEW ALUMINUM CANOPY 36x16 BY OTHERS (COLOR: YELLOW)
 - C3 NEW ALUMINUM CANOPY TIE-BACK BY OTHERS
 - C4 NEW ALUMINUM CANOPY 18x16 BY OTHERS (COLOR: YELLOW)
 - C5 CEMENTITIOUS CONTROL JOINT
 - CP CORRUGATED METAL BAND BY METAL ERA - 800-558-2162 - ALUMINUM - 1/8" 18" PANEL 24 GAUGE (COLOR: CITYSCAPE)
 - E CEMENTITIOUS FINISH COLOR: BENJAMIN MOORE 2122-10 SNOW WHITE
 - EV EXPANSION JOINT
 - L LIGHT FIXTURE (WALL SCONCE) - SEE ELECTRICAL
 - LE LED LIGHT: L1 = UP AND DOWN FIXTURE L2 = DOWN ONLY FIXTURE L3 = INTEGRAL CANOPY FIXTURE L4 = UP ONLY FIXTURE
 - LP LIGHT FIXTURE (PARAPET LIGHT) - SEE ELECTRICAL
 - ML METAL LETTERING - BY OTHERS
 - PB PIPE BOLLARD - PAINTED YELLOW
 - RE 45 FT ROOF ELEMENT & SUPPORT BY OTHERS - SEE ROOF PLAN AND SECTIONS
 - S McDONALD'S NEXT-GEN SIGNAGE BY OTHERS - UNDER SEPARATE PERMIT.
 - T1 ALUMINUM TRELLIS
 - T2 2x8 WALL FASCIA
 - T3 EXTERIOR WINDOW ASSEMBLY - SEE A3.0
 - T4 TEMPERED GLASS
 - U2 DRIVE-THRU WINDOW BY READY ACCESS
 - U3 AMICO VINYL MID-WALL WEEP SCREED OR APPROVED EQUAL

Hartley + Purdy Architecture, Inc.
1711 North Himes Avenue, Tampa, Florida 33607, Ph: 813/533-0035 Fax: 813/533-4360 Web Site: www.hartleypurdy.com

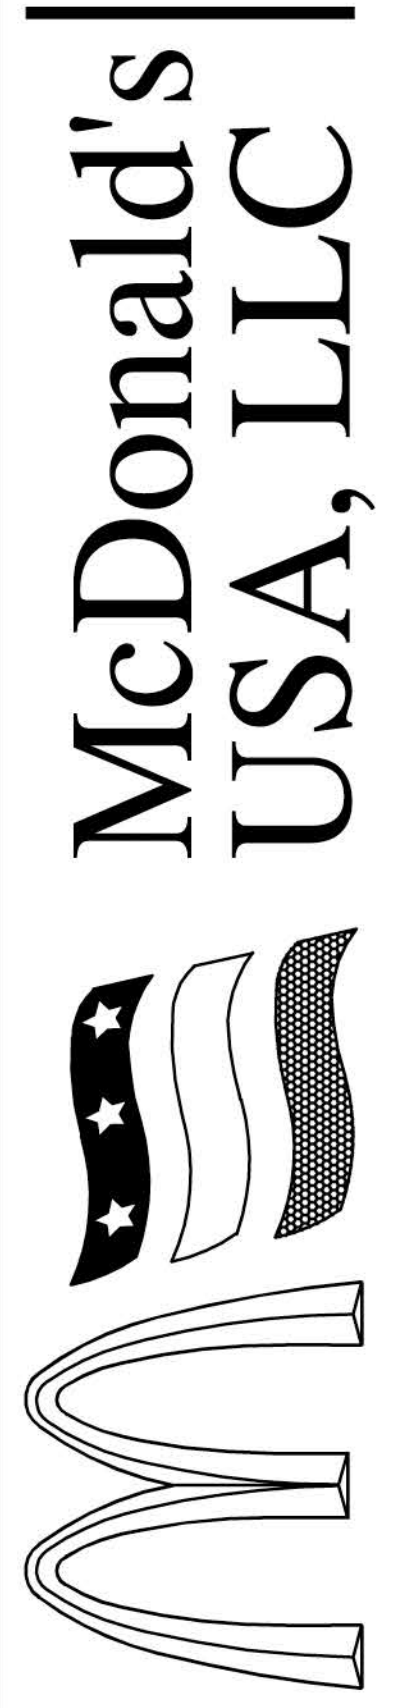

SCOTT J. PURDY
AR 91876

No. 1102.72

TITLE: MRP REMODEL
4200 W. SAMPLE ROAD
COCONUT CREEK, FL
ST/SITE# 009-1012
NAT# 10901
DATE

ISSUE 02.01.12
REV# 01.15.14

SHEET NO
A2.0
AA-0003276

ALL RIGHTS RESERVED 9/12