COMMUNICATIONS

FT. LAUDERDALE MARKET

WINSTON PARK

NEW 125 FOOT MONOPOLE WITH NEW ANTENNAS AND NEW GROUND LEVEL EQUIPMENT SHELTER.

SITE NUMBER FL 3672A

NEXTEL LEASE PARCEL LEGAL DESCRIPTION:

A PORTION OF PARCEL "D" OF BANYAN TRAILS, AS RECORDED IN PLAT BOOK 154, PAGE 3 OF THE PUBLIC RECORDS OF BROWARD COUNTY, FLORIDA, AND BEING MORE PARTICULARLY DESCRIBED AS FOLLOWS:


COMMENCE AT THE NORTHEAST CORNER OF PARCEL "E" OF SAID BANYAN TRAILS: THENCE SOUTH 00 50'12", ALONG THE EASTERLY LINE OF SAID PARCEL "E", SAID EASTERLY LINE ALSO BEING THE WESTERLY RICHT- OF WAY LINE OF N.W. 30TH AVENUE, A DISTANCE OF 422.99 TECT; THENCE SOUTH 89 00'48" WSST, A DISTANCE OF 259.92 FFET, TO THE POINT OF BEGINNING OF THE FOLLOWING DESCRIBED NEXTEL LEASE SITE:


THENCE SOUTH 29 15'11" WEST, A DISTANCE OF 20.00 FELT; THENCE NORTH 60 44'49" WEST, A DISTANCE OF 40.00 FEET, THENCE NORTH 29 15'11" EAST, A DISTANCE OF 20.00 FEET, THENCE SOUTH 60 44'49" EAST, A DISTANCE OF 50.00 FEET, THENCE SOUTH 60 64'49" EAST, A DISTANCE OF 40.00 FEET TO THE POINT OF REGINALING


CONTAINING 800 SQUARE FEET OR 0.0184 ACRES, MORE OR LESS.



W.L.FISH & COMPAN PROFESSIONAL SURVEYORS AND NAPPER

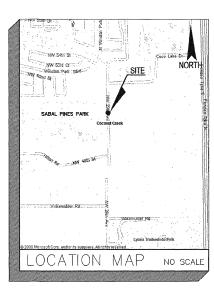

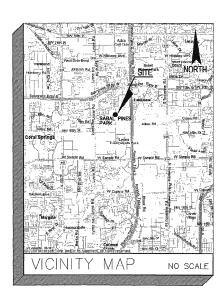

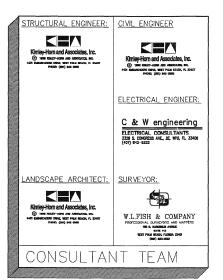

	SITE NUMBER.	FL JUIZA
	SITE ADDRESS:	SABAL PINES PARK 5005 NW 39TH AVENUE COCONUT CREEK, FL 33063
	PROPERTY OWNER:	CITY OF COCONUT CREEK 4800 W. COPANS ROAD COCONUT CREEK, FL33063
	CONTACT PERSON:	LARRY BROWN ENGINEERED ENVIRONMENTS 990 S. ROGERS CIR., SUITE BOCA RATON, FL 33487 (561) 241-8403
	APPLICANT:	NEXTEL 6700 N. ANDREWS AVENUE SUITE 700 FT. LAUDERDLE, FL 33309
	CURRENT ZONING:	PUD
	PROJECT	SUMMARY
/		

NO.	
T-1	TITLE SHEET
	SURVEY
G-1	GENERAL NOTES #1
G-2	GENERAL NOTES #2
G-3	GENERAL NOTES #3
C-1	SABAL PINES PARK MASTER PLAN
C-2	NEXTEL SITE PLAN
C-3	DETAILS
C-4	SERVICE GATE AND FENCE DETAILS
C-5	MONOPOLE ELEVATION
S-1	SHELTER FOUNDATION
LA-1	LANDSCAPE PLAN
LA-2	LANDSCAPE DETAILS
IR-1	IRRIGATION PLAN
	IRRIGATION DETAILS
E-1	ELECTRICAL SITE PLAN
E-2	ELECTRICAL DETAILS
SHE	EET INDEX
}	



6700 N. ANDREWS AVENUE SUITE 700 FT. LAUDERDALE, FLORIDA 33309 (954) 275-2400



Kimley-Horn and Associates, Inc.

(E) 1998 KIMLEY-HORN AND ASSOCIATES, INC. ASI EMBARCADERO DRIVE, WEST PALM BEACH, FL 33407 PHONE: (561) 845 0665

REGISTRATION NUMBERS

	KIMLEY HORN & ASSOCS., INC.	EB0000696
	DAVID STEWART	PE 31180
	CHARLES GEER	PE 31435
	KIRK DROST	PE 51910
	RUSSELL MORRISON	PE 51567
	ANGELINA G. FAIRCHILD	PE 43958
	SETH SCHMID	PE 54640



SEAL JAN 1 7 2001

	DECOMPOSION.	
NO. DATE	DESCRIPTION	
	1	

APPROVALS
PROJECT MANAGER DATE:
NEXTELRF:DATE:
PROPERTY OWNER DATE:

ANTENNA INSTALLATION AT WINSTON PARK SITE NUMBER: EL 3672A

SCALE:	AS SHOWN	
DESIGNED BY:	JBC	
DRAWN BY:	AJD	
APPROVED BY:	DWS	
DATE:	JANUARY 2001	


KHA PROJECT NUMBER
044201071
DRAWING NUMBER
T-1
SHEET TITLE
TITLE SHEET
DATE 2/L/(A) BY PLANNING & ZONING SHEET NUMBER

Instrument of service, is intended only for the specific purpose and client instrument of service, is intended only for the specific purpose and client which it was prepared. Reuses of and improper reliance on this document without written authorization and adoptation by Kimley-Horn and Associate Inc. shall be without liability to Kimley-Horn and Associate Inc. shall be without liability to Kimley-Horn and Associates, inc.

4eW442015721VCONSTICATE dwg 11117/01 01:25:32 P

OF.

1

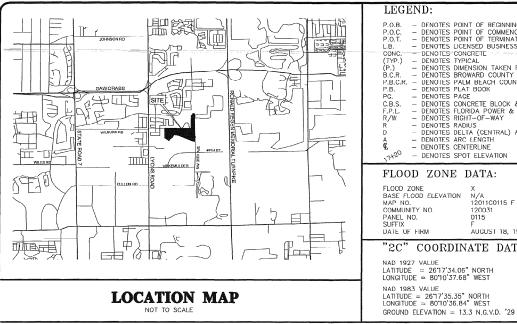

WINSTON PARK SECTION TWO P.B. 136, PG. 1

PARCEL "C"

N.81°38'30"W. 145.88'—

15' R/W, P.B. 2, PGS. 45-54, (P.B.C.R.)

PARCEL "E"

N. 5 703 56". N. 5 703 56". W.

LEGEND: DENOTES POINT OF COMMENCEMENT DENOTES POINT OF TERMINATION DENOTES LICENSED BUSINESS DENOTES TYPICAL DENOTES DIMENSION TAKEN FROM PLAT DENOTES BROWARD COUNTY RECORDS DENOTES PALM BEACH COUNTY RECORDS DENOTES PLAT BOOK DENOTES PAGE DENOTES PAGE DENOTES CONCRETE BLOCK & STUCCO DENOTES FLORIDA POWER & LIGHT CO. DENOTES RIGHT-OF-WAY

 DENOTES RIGHT-UF-WAY
 DENOTES RADIUS
 DENOTES DELTA (CENTRAL) ANGLE
 DENOTES ARC LENGTH
 DENOTES CENTERLINE - DENOTES SPOT ELEVATION

FLOOD ZONE DATA:

FLOOD ZONE BASE FLOOD ELEVATION MAP NO. N/A 12011C0115 F 120031 COMMUNITY NO. PANEL NO. SUFFIX DATE OF FIRM . AUGUST 18, 1992

"2C" COORDINATE DATA:

R=90.00'

D=72°52'31"

NAD 1927 VALUE LATITUDE = 26"17'34.06" NORTH LONGITUDE = 80"10'37.68" WEST NAD 1983 VALUE LATITUDE = 2617'35.35" NORTH LONGITUDE = 8010'36.84" WEST

R=25.00'

A=25.82'

N.60°02'37"E.~ 84.27'

N.88'40'56"E. 114.38' 00

R=185.00 D=89'24'03' A=288.66'

N.00'43'08"W. 112.75' -

R=15 00

N.00°50'12"W. 15.00'-

N.67.59'20"W. 744.70"

D=90*03'24" A=23.58' N.00*53'46"W. 113.72'

TRACT "A"
WINSTON PARK SECTION TWO
P.B. 136, PG. 1

N.89°37'16"E. 1815 69'

31.48'

N.81°02'56"W.

-S.25°19'35"W. 126.68'

S.52 59'45"W.

226.06

BANYAN TRAILS

P.B. 154, PG. 3 (B.C.R.)

PARCEL "C"

BANYAN TRAILS P.B. 154, PG. 3

-N.62°29'06"W 94.84'

S.89'02'50"W.

R=630.00'

A=2.50

D=0013'39"

D=59°10'28"

PARENT TRACT LEGAL DESCRIPTION

ALL OF TRACT "B" AND THAT CERTAIN 100 FOOT CANAL RIGHT-OF-WAY AS SHOWN ON WINSTON PARK SECTION TWO, ACCORDING TO THE PLAT THE PART OF THE PALM BEACH COUNTY, FLORIDA AND BEING MORE PARTICULARLY DESCRIBED AS FOLLOWS:* SEE NOTE BELOW

PALM BEACH COUNTY, FLORIDA AND BEING MORE PARTICULARLY DESCRIBED AS FOLLOWS: SEE NOTE BELOW

DECININING AT THE SOUTHEAST CORNER OF CAID PARCELETY, ALSO DEING THE NORTH LEAST CORNER OF SAID PARCELETS, THE NORTH AND THE ARC OF SAID CURVE, HAVING A FREET TO THE POINT OF CURVATURE OF A CIRCULAR CURVE TO THE RIGHT. THENCE SOUTHERN YALONG THE ARC OF SAID CURVE, HAVING A RADIUS OF 845 GUFET AND A CENTRAL ANGLE OF 254 44 FEET TO THE POINT OF CURVATURE OF A CIRCULAR CURVE TO THE LIST THE SCENE OF THE SAID CENTRAL ANGLE OF 257 CHOICE, A DISTANCE OF 317 AND THE LIST THE SAID CENTRAL ANGLE OF 277 CHOICE, A DISTANCE OF 317 AND THE LIST THE SAID CENTRAL ANGLE OF 277 CHOICE, A DISTANCE OF 317 AND THE SAID CENTRAL ANGLE OF 277 CHOICE, A DISTANCE OF 317 AND THE SAID CENTRAL ANGLE OF 317 AND THE SAID CENTRAL AN PROJECTION, DISTANCE OF TROUTEST TO THE SOUTH WEST CONGEROR'S SAID TRACT TS, THEN DECOMMIND ENDRING THOUSE ZEWEST ALLOWS SAID WEST BOUNDAY OF TRACT TS, A DISTANCE OF 872.8 FEET TO A POINT ON THE SOUTHEAST RIGHT-OF-WAY OF WINSTON PARK BOULDEVARD AS SHOWN ON SAID WINSTON PARK SECTION TWO. THE RADIUS POINT OF THE NEXT DESCRIBED CURVE BEARS NORTH 43-472" WEST FROM SAID POINT, THENCE NORTHEASTERLY ALONG THE ARC OF SAID CURVE, ALSO BEING ALONG SAID WINSTON PARK BOULDER RIGHT-OF-WAY, HAVING A RADIUS OF 830.00 FEET AND A CENTRAL ANGLE OF 8012139", A DISTANCE OF 2.50 FEET, THENCE NORTH 601022" EAST, NON-TANGENT TO THE EVERSE CURVATURE, THENCE NORTHEASTERLY AND EASTERLY ALONG THE ARC OF SAID CURVE, HAVING A RADIUS OF 25.00 FEET AND A SENITAL ANGLE OF 38 1807, ADISTANCE OF 16.71 FEET OTHER POINT OF THE NEXT PROSENCENDETH 164 3831 "EAST, A DISTANCE OF 119.15 FEET OF THE NEXT PROSENCE OF THE STATE OF THE NEXT PROSENCE OF THE NEXT

NEXTEL LEASE SITE LEGAL DESCRIPTION:

A PORTION OF PARCEL "D" OF BANYAN TRAILS, AS RECORDED IN PLAT BOOK 154, PAGE 3 OF THE PUBLIC RECORDS OF BROWARD COUNTY, FLORIDA AND BEING MORE PARTICULARLY DESCRIBED AS FOLLOWS:

COMMENCE AT THE NORTHEAST CORNER OF PARCEL 'E' OF SAID BANYAN TRAILS; THENCE SOUTH 00 30 12°, ALONG THE EASTERLY LINE OF SAID PARCEL 'E'. SAID EASTERLY LINE ALSO BEING THE WESTERLY RIGHT-OF-UNY LINE OF INV 38° AVENUE, A DISTANCE OF A29 FEET; THENCE SOUTH 390344 WEST, A DISTANCE OF 259,25 FEET, TO THE FORM OF BEGINNING OF THE FOLLOWING DESCRIBED NEXTEL LEASE SITE.

THENCE SOUTH 29°15'11" WEST, A DISTANCE OF 20.00 FEET; THENCE NORTH 60°44'49" WEST, A DISTANCE OF 40.00 FEET; THENCE NORTH 29°15'11" EAST, A DISTANCE OF 20.00 FEET; THENCE SOUTH 60°44'49" EAST, A DISTANCE OF 40.00 FEET, TO THE POINT OF BEGINNING.

A STRIP OF LAND 20.00 FEET IN WIDTH, FOR ACCESS EASEMENT PURPOSES, SAID STRIP LYING WITHIN A PORTION OF PARCEL "D" OF BANY, TO POOT CANAL RIGHT-O-YMY AS SHOWN ON WINSTON PARK SECTION TWO AS RECORDED IN PLAT BOOK 158, PAGE 1, OF SAID PUBLIC RECORDS OF BROWNING COUNTY, FLORIDA, A PORTION OF A 25 FOOT RIGHT-OF SAID SHOWN ON THE PLAT OF PAUM BEACH FARMS COUNTY, FLORIDA, AND A CHIEF COMPANY PLAT NO.2, PLAT BOOK, PAGES AS THROUGH OF A SECTION OF A 25 FOOT RIGHT-OF SAID SHOWN ON THE PLAT OF PAUM BEACH FARMS OF COMPANY PLAT NO.2, PLAT BOOK, PAGES AS THROUGH OF A SECTION OF PAUM BEACH COUNTY, FLORIDA, AND A PORTION OF PAGE 15" COCO LAKES, AS RECORDED IN PLAT BOOK 155, PAGE 25, OF SAID PUBLIC RECORDS OF BROWNED COUNTY; THE SIDELINES OF SAID ACCESS EASEMENT LYING TOO PEACH SECTION OF THE FOLLOWING DESCRIBED CENTRICINE.

COMMENCE AT THE MOST FASTERIY CORNER (POINT OF BEGINNING) OF THE PREVIOUSLY DESCRIBED NEXTEL LEASE SITE, THENCE SOUTH 29/15/11 WEST, ALONGTHE SOUTHEASTERLY LINEOF SADDREXTELLEASE SITE, ADISTANCEOF 20.00FEET; THENCENORTHEOWAY "WEST, ALONG THE THE SOUTHWESTERLY LINE OF SADD NEXTEL LEASE SITE, A DISTANCE OF AUDU FEET; THENCE NORTH 19/15/11/1 LAST, ALONG THE NORTHWESTERLY LINE OF SAD NEXTEL LEASE SITE, A DISTANCE OF 10.00FEET, TO THE POINT OF BEGINNING OF THE FOLLOWING DESCRIBED

THENCENORTHEOWARD WEST, DEPARTING SAID NORTHWESTERLY LINE. A DISTANCE OF 10.00 FEET, THENCE NORTHWOSS-90" WEST, A DISTANCE OF 46.78 FEET, THENCE NORTH 1895649" WEST, A DISTANCE OF 17.75 FEET 17.01 THE BEGINNING OF A CURVE CONCAR TO THE NORTHWEST AND HAWING ARADIUS OF 15.00 FEET; THENCE WESTERLY, NORTHWESTERLY AND HORTHERLY, 23.31 FEET, ALONG THEARCO'S SAID CURVE, THROUGH A CENTRAL ANGLE OF \$80.000; TO A POINT O'T INDECENS THE DISTANCE OF 18.50 FEET, TO THE BEGINNING OF A CURVE, CONCAWE TO THE SOUTHWEST, AND HAWING A RADIUS OF 15.00 FEET, THENCE NORTHHERLY, NORTHWESTERLY AND WESTERLY, 23.65 FEET, ALONG THE RAC OF \$80.000 FEET, THENCE NORTHWESTERLY AND WESTERLY, 23.65 FEET, ALONG THE ARC OF \$9.57 FEET, THENCE NORTHWESTERLY WEST, A DISTANCE OF \$9.57 FEET, THENCE NORTHWESTERLY WISTON WEST, A DISTANCE OF 11.275 FEET, TO THE BEGINNING OF A CURVE CONCAVE TO THE SOUTH 80.000 FEET, THENCE NORTHWESTERLY WISTON WEST, A DISTANCE OF \$9.57 FEET, THENCE NORTHWESTERLY WISTON WEST, A DISTANCE OF \$9.57 FEET, THENCE NORTHWEST, THENCE NORTHWESTERLY WISTON WEST, A DISTANCE OF \$9.57 FEET, THENCE NORTHWEST, THENCE N

- NOT VALID WITHOUT THE SIGNATURE AND THE ORIGINAL RAISED SEAL OF A FLORIDALICENSED SURVEYOR AND MAPPER. NO ABSTRACT OF THE PUBLIC RECORDS FOR EASEMENTS OR RIGHTS OF-WAY WAS PROVIDED TO OR CONDUCTED BY THIS OFFICE BENCHMARK USED IS A BROWAND COUNTY FOR SITE OF DIVISION SURVEY, HAVEN IS A STANDAU BRASS CAP STAMPED BM #280 IN STANDARD 36" X 4" CONCRETE MONUMENT, 4½ SOUTH OF CENTERLINE VINKEMULDER ROAD AND

S.

3. X

FL. PAI FLORI

SITE TON UNTY, I

BOUNDARY AND LEASE SITE FOI NEXTEL TP/WINS BROWARD CO

ANY. Mappers

MP,

& CO

W.L.FISH PROFESSIONAL SU

DRAWN:

CHECKED.

DATE:

JOB NO.

M. LA TOUR

W. L. FISH

10/25/2000

2000-284 SHEET NO.


2 of 17


 \sim


SOUTH 00:50:22" EAST (SURVEY BEARING - CRAVEN-THOMPSON & ASSOCIATES, INC.) SOUTH 00:50:12" EAST (GRID BEARING - W. L. FISH & COMPANY, INC.)

CERTIFICATION:

I HEREBY CERTIFY THAT THE BOUNDARY AND TOPOGRAPHIC SURVEY SHOWN HEREON MEETS THE MINIMUM TECHNICAL STANDARDS FOR SURVEYINGIN THE STATE OF FLORIDASS SET FORTHEY THE FLORIDADORD OF PROFESSIONAL SURVEYORS AND MAPPERS IN CHAPTER 61(51) FLORIDAD ADMINISTRATIVE CODE, PURSUANT TO SECTION 47(207) FLORIDAS TRATUTES.

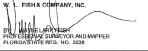

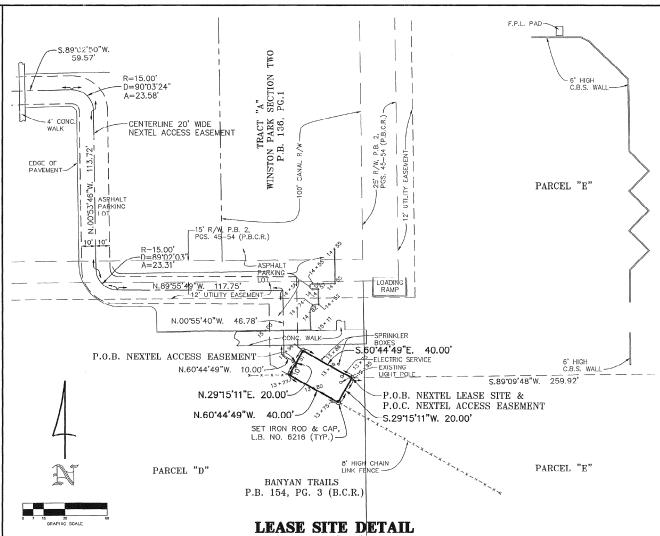

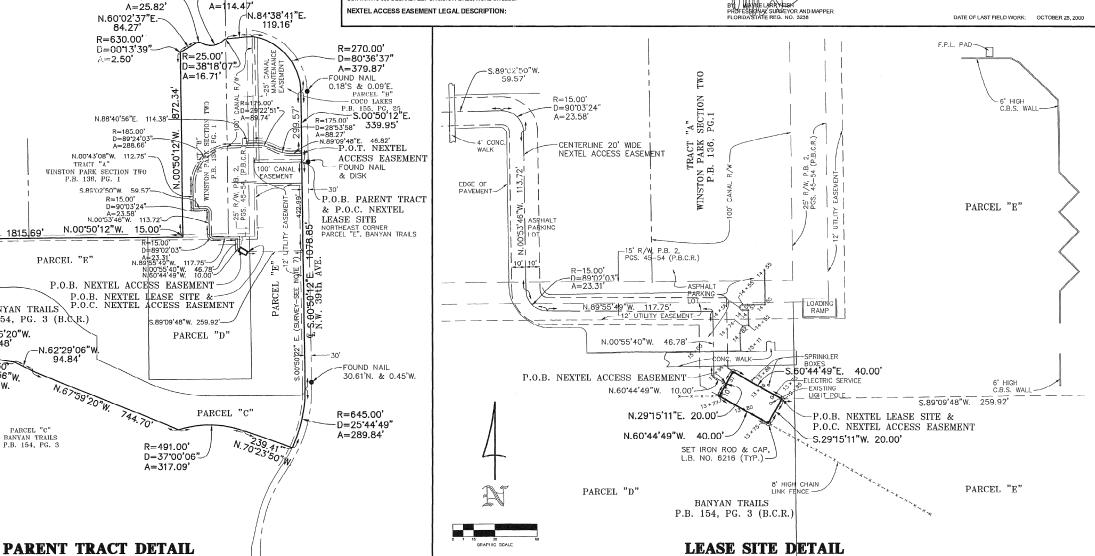

1-1.00 NEXTEL COMMUNICATIONS REPRESENTATIVE

A. THE NEXTEL COMMUNICATIONS SITE DEVELOPMENT MANAGER (HEREIN AFTER SDM) OR HIS DESIGNEE (INCLUDING BUT NOT LIMITED TO THE ARCHITECT/ENGINEER, OR CONSTRUCTION MANAGER) SHALL SERVE AS THE SINGLE POINT OF CONTACT BETWEEN THE CONTRACTOR AND NEXTEL COMMUNICATIONS. NOT WITH STANDING THE HAQUIRCHMENTS SPECIFIED HEREIN, THE SDM OR DESIGNATED REPRESENTATIVE IS EMPOWERED TO DIRECT THE CONTRACTOR TO VARY OR CHANGE FROM THE PLANS AND SPECIFICATIONS AS CIRCUMSTANCES OR CONDITIONS ARISE.

1-1.01 INTENT

A THESE SPECIFICATIONS AND CONSTRUCTION DRAWINGS
ACCOMPANYING THEM DESCRIBE THE WORK TO BE PERFORMED AND
THE MATERIALS TO BE FURNISHED FOR THE CONSTRUCTION OF
THE NEXTEL COMMUNICATIONS SITE NO. FL3672B, WINSTON PARK

- B. THE DRAWINGS AND SPECIFICATIONS ARE INTENDED TO BE FULLY EXPLANATORY AND COMPLIMENTARY. HOWEVER, SHOULD ANYTHING BE SHOWN, INDICATED OR SPECIFIED ON ONL AND NOT THE OTHER, IT SHALL BE THE SAME AS IF SHOWN, INDICATED OR SPECIFIED ON BOTH.
- C. THE INTENTION OF THE DOCUMENTS IS TO INCLUDE ALL LABOR AND MATERIALS REASONABLY NECESSARY FOR THE PROPER EXECUTION AND COMPLETION OF THE WORK AS INDICATED IN THE DOCUMENTS.
- D. THE PURPOSE OF THE SPECIFICATIONS IS TO SUPPLEMENT THE INTENT OF THE DRAWINGS AND TO DESIGNATE A PROCEDURE, TYPE OR QUALITY OF MATERIALS REQUIRED TO COMPLETE THE WORK.
- E. MINOR DEVIATIONS FROM THE DESIGN LAYOUT ARE ANTICIPATED AND SHALL BE CONSIDERED AS PART OF THE WORK HOWEVER, NO CHANGES INFAIL THE HE CHARACTER INTENT OF THE DESIGN WILL BE MADE OF PERMITTED BY NEXTEL, INC WITHOUT A

1-1.02 CONFLICTS

- A. THE CONTRACTOR AND EACH SUBCONTRACTOR SHALL BE RESPONSIBLE FOR VERIFICATION OF ALL MEASUREMENTS AT THE SITE BEFORE OBDERING ANY MATERIALS OR PERFORMING ANY WORK, NO EXIRA CHANGE OF COMPENSATION SHALL BE ALLOWED DUE TO DIFFERENCE DETWEEN ACTUAL DIMENSIONS ADDIMENSIONS INDICATED ON THE CONSTRUCTION DRAWNICS ANY SUCH DISCREPANCY IN DIMENSION WHICH MAY INADVERTENTLY OCCUR SHALL BE SUBMITTED TO THE NEXTEL COMMUNICATIONS SOM FOR CONSIDERATION BEFORE THE CONTRACTOR PROCEEDS WITH THE WORK IN THE AFFECTED AREA.
- THE CONTRACTOR, IF AWARDED THE CONTRACT, WILL NOT BE ALLOWED ANY EXTRA COMPENSATION BY REASON OF ANY MATTER OR THING WHICH SUCH THE CONTRACTOR MIGHT NOT HAVE FULLY INFORMED HIMSELF PRIOR TO BIDDING.
- NO PLEA OF IGNORANCE OF CONDITIONS THAT EXIST, OR OF DIFFICULTIES THAT MAY BE ENCOUNTERED OR OF ANY OTHER RELEVANT MATTER CONCERNING THE WORK TO BE PERFORMED WILL BE ACCEPTED AS A REASON FOR ANY FAILURE OR OMISSION ON PART OF THE CONTRACTOR TO FULFILL THE REQUIREMENTS OF THE CONTRACT DOCUMENTS.

1-1.03 BIDDING PROCESS

A. BIDDING SCOPE CONTRACTORS TO SUPPLY ALL MATERIALS AND PERFORM ALL LABOR AS SHOWM, AND PROVIDE ALL TOOLS, EQUIPMENT AND TRANSPORTATION NECESSARY TO COMPLETE THE WORK AS DESCRIBED IN THE DRAWINGS AND SPECIFICATIONS.

PROJECT NAME: WINSTON PARK, SITE NUMBER: FL3672B

- ANTENNA CONSIST OF: (9) BASE STATION ANTENNAS FURNISHED BY NEXTEL COMMUNICATIONS.
- ALL ADDITIONAL ANTENNAS SUPPLIED BY: NEXTEL COMMUNICATIONS
- 3. ALL FOAM DIELECTRIC COAXIAL CABLES AND JUMPER CABLES SUPPLIED BY NEXTEL COMMUNICATIONS
- RADIO EQUIPMENT (FNE) SUPPLIED BY NEXTEL COMMUNICATIONS AND IS INSTALLED BY: OTHERS
- COMMERCIAL POWER SURGE ARRESTOR SUPPLIED BY NEXTEL COMMUNICATIONS
- TELEPHONE FACILITY SURGE ARRESTOR SUPPLIED BY NEXTEL COMMUNICATIONS

NOTE: GENERAL CONTRACTOR TO PICK UP FURNISHED MATERIALS AS DIRECTED BY SDM.

B. INSTRUCTIONS TO BIDDERS

NEXTEL COMMUNICATIONS REQUESTS A FIRM SUM BID FOR ALL WORK DESCRIBED IN THE CONTRACT AND AS INDICATED IN THESE CONSTRUCTION DRAWINGS AND SPECIFICATIONS.

BIDDERS WILL GUARANTEE BIDS FOR 60 DAYS FROM DUE DATE. BIDS SHALL INCLUDE ALL APPLICABLE STATE AND FEDERAL TAXES.

2. PROPOSAL: (AS OUTLINED IN BID DOCUMENTS)

IT IS UNDERSTOOD BY NEXTEL COMMUNICATIONS THAT THE BIDDER IN SUBMITTING HIS BID, WARRANTS THAT HE HAS: CAREFULLY EXAMINED THE SITE OF THE PROJECT TO ACQUAINT

- A. SURROUNDING PROPERTIES.
- B. MEANS OF APPROACH TO THE SITE.
- C. CONDITIONS OF THE ACTUAL JOB SITE.
- D. FACILITIES FOR DELIVERING, STORING, PLACING, HANDLING, AND REMOVAL OF MATERIALS AND EQUIPMENT.
- E. ANY AND ALL DIFFICULTIES THAT MAY BE ENCOUNTERED DURING THE EXECUTION OF ALL WORK IN ACCORD WITH THE CONTRACT DOCUMENTS.

1-1.04 CONTRACTS AND WARRANTIES

- A. "A1A DOCUMENT A107" ABBREVIATED FORM OF AGREEMENT BETWEEN NEXTEL COMMUNICATIONS AND CONTRACTOR HAS BLEN MODIFIED-AND-WILL-DE-EMPLOYED-FOR-CONTRACT-PURPOSES.
- B. EACH CONTRACTOR IS RESPONSIBLE FOR PULLING THE BUILDING PERMIT AT THE LOCAL JURISDICTION AS THE CONTRACTOR OF RECORD, AND PROVIDE JURISDICTION WITH ALL PROOF REQUIRED TO OPERATE AS A CONTRACTOR IN THAT JURISDICTION. THE CONTRACTOR SHALL BE REIMBURSED FOR THE AMOUNT OF ANY FEE PAID AS FOLLOWS.
 - PLAN REVIEW FEE. BUILDING PERMIT FEE.
- CONNECTIONS AND INSPECTIONS FEE.
- C. EACH CONTRACTOR IS RESPONSIBLE FOR APPLICATION & PAYMENT OF CONTRACTOR LICENSES & BONDS.

- A. DO NOT USE THE EXISTING BUILDING SPACE FOR STORAGE OF TOOLS OR MATERIALS WITHOUT THE SDM AND/OR BUILDING
- B. ALL MATERIALS MUST BE STORED IN A LEVEL AND DRY LOCATION AND IN A MANNER THAT WILL NOT OBSTRUCT THE FLOW OF OTHER WORK. ANY EQUIPMENT OR MATERIAL STORAGE METHOD MUST MEET ALL RECOMMENDATIONS OF THE

1-1.06 PROTECTION

- A. PROTECT FINISHED SURFACES, INCLUDING JAMBS AND HEADS OF OPENINGS USED AS PASSAGEWAYS THROUGH WHICH EQUIPMENT AND MATERIALS WILL PASS.
- B. PROVIDE PROTECTION FOR EQUIPMENT ROOM SURFACES PRIOR TO ALLOWING EQUIPMENT OR MATERIALS TO BE MOVED OVER SUCH SURFACES.

1-1.07 REPAIRS AND REPLACEMENTS:

- A. IN EVENT OF DAMAGE, THE CONTRACTOR SHALL PROMPTLY MAKE ALL REPLACEMENTS AND REPAIRS AND AT NO ADDITIONAL COST TO NEXTEL COMMUNICATIONS AND/OR BUILDING OWNER.
- B. ADDITIONAL TIME REQUIRED TO SECURE REPLACEMENTS AND TO MAKE REPAIRS WILL NOT BE CONSIDERED BY NEXTEL COMMUNICATIONS TO JUSTIFY AN EXTENSION IN THE CONTRACT TIME FOR COMPLETION.

1-1.08 TEMPORARY FACILITIES:

- A. WATER: WATER IS NOT AVAILABLE TO THE CONTRACTORS ON SITE.

LIGHT AND POWER ARE NOT AVAILABLE ON SITE.

- C. TELEPHONE:
 - EACH CONTRACTOR TO PROVIDE HIS OWN TELEPHONE ACCESS IF REQUIRED.

CONTRACTORS ARE NOT TO USE NEXTEL COMMUNICATIONS

D. IF PERMANENT POWER IS COMPLETED, ALL CONTRACTORS MAY USE THE SERVICE CONNECTION FOR PRODUCTION WORK ONLY, PROVIDED THAT ELECTRICAL CORDS AND CONNECTIONS ARE FURNISHED BY THE CONTRACTORS AND ARE DISCONNECTED AND PROPERTY STORED DURING NON-WORKING HOURS.

1-1.09 CLEAN UP:

- THE CONTRACTORS SHALL AT ALL TIMES KEEP THE SITE FREE FROM ACCUMULATION OF WASTE MATERIALS OR RUBBISH CAUSED BY THEIR EMPLOYEES AT WORK, AND AT THE COMPLETION OF THE WORK, THEY SHALL REMOVE ALL RUBBISH FROM AND ABOUT THE BUILDING, INCLUDING ALL TOOLS, SCAFFOLDING AND SURPLUS MATERIALS, AND SHALL LEAVE THE WORK CLEAN AND READY FOR USE.
- B. EXTERIOR: VISUALLY INSPECT EXTERIOR SURFACES AND REMOVE ALL TRACES OF SOIL, WATER MATERIALS, SMUDGES AND OTHER FOREIGN MATTER.
 - REMOVE ALL TRACES OF SPLASHED MATERIALS FROM ADJACENT SURFACES.
- INTERIOR: VISUALLY INSPECT INTERIOR SURFACE AND REMOVE ALL TRACES OF SOIL, WASTE MATERIALS, SMUDGES AND OTHER
 - REMOVE ALL TRACES OF SPLASHED MATERIAL FROM ADJACENT SURFACES.
 - REMOVE PAINT DROPPINGS, SPOTS, STAINS AND DIRT FROM FINISHED SURFACES.

1-1.10 CHANGE ORDER PROCEDURE:

- CHANGE ORDER MAY BE INITIATED BY THE SDM, AND/OR THE CONTRACTOR. THE CONTRACTOR, UPON VERBAL REQUEST FROM THE SDM SHALL PREPARE A WRITERN PROPOSAL DESCRIBING THE CHANGE IN WORK OR MATERIALS AND ANY CHANGES IN THE CONTRACT AMOUNT AND PRESENT TO THE SUM FOR APPROVAL. SUBMIT REQUESTS FOR SUBSTITUTIONS IN THE FORM. AND IN ACCORDANCE WITH BROCEDURES FOR CONTRACT OF THE SUM CONTRACT OF THE ACCORDANCE WITH PROCEDURES REQUIRED FOR CHANGE ORDER PROPOSALS. ANY CHANGES THE SCOPE OF WORK OR MATERIALS WHICH ARE PERFORMED BY THE CONTRACTOR WITHOUT A WRITTEN CHANGE ORDER AS DESCRIBED AND APPROVED BY THE 5DM, SHALL BECOME THE FOIL F RESPONSIBILITY OF THE CONTRACTOR.
- 1-111 RELATED DOCUMENTS AND COORDINATION:

GENERAL CARPENTRY, ELECTRICAL, AND ANTENNA DRAWINGS ARE INTERRELATED. IN PERFORMANCE OF THE WORK, EACH CONTRACTOR MUIST REFER TO ALL DRAWINGS. ALL COORDINATION TO BE THE RESPONSIBILITY OF THE GENERAL CONTRACTOR.

1-1.12 SHOP DRAWINGS:

- CONTRACTORS TO SUBMIT SHOP DRAWINGS AS REQUIRED AND LISTED IN THESE SPECIFICATIONS THROUGH THE GENERAL CONTRACTOR TO THE SDM, FOR APPROVAL.
- B. ALL SHOP DRAWINGS TO BE REVIEWED, CHECKED AND CURRECIED BY GENERAL CONTRACTOR PRIOR TO SUBMITTAL TO THE SDM.

1-1.13 PRODUCTS AND SUBSTITUTIONS:

- SUBMIT 3 COPIES OF EACH REQUEST FOR SUBSTITUTION. IN EACH REQUEST IDENTIFY THE PRODUCT FABRICATION OF INSTALLATION METHOD TO SEE REPLACED BY THE SUBSTITUTION. INCLUDE RELATED SPECIFICATION SECTION AND DRAWING NUMBERS, AND COMPLETE DOCUMENTATION SHOWING COMPLIANCE WITH THE REQUIREMENTS FOR SUBSTITUTIONS.
- ALL NECESSARY PRODUCT DATA AND CUT SHEET WHICH PROPERLY INDICATE AND DESCRIBE THE ITEMS, PRODUCTS, AND MATERIALS BEING INSTALLED. THE CONTRACTOR SHALL, IF DEEMED NECESSARY BY THE SDM, SUBMIT ACTUAL SAMPLES TO THE SDM FOR APPROVAL IN LIEU OF CUT SHEETS.

COMPLIANCE

IT IS THE CONTRACTOR'S RESPONSIBILITY TO VERIFY COMPLIANCE WITH THE GOVERNING CODES AND TO NOTIFY THE SDM OF ANY DISCREPANCIES PRIOR TO PERFORMING WORK.

REFERENCE TO ANY STANDARD OR CODE OF PRACTICE IN THIS SPECIFICATION SHALL BE DEFMED TO MEAN THE EDITION CURRENT AT THE TIME OF AWARD OF THE CONTRACT. THE CONTRACTOR SHALL COMPLY WITH ALL ZONING AND SITE ACQUISITION SPECIAL STIPULATIONS AS OUTLINED IN THE JOB SPECIFICATIONS, OR AS DIRECTED BY THE SDM.

ANSI/EIA - 222 - E STANDARD BUILDING CODE BUILDING OFFICIALS & CODE ADMINISTRATORS (BOCA)
NATIONAL ELECTRICAL CODE (NEC) WITH LOCAL AMENDMENTS
UNDERWRITERS LABORATORIES APPROVED ELECTRICAL PRODUCTS AMERICAN INSTITUTE OF STEEL CONSTRUCTION SPECIFICATIONS (AISC)

1-1.15 ADMINISTRATION

THE CONTRACTOR SHALL FURNISH TO THE SDM WITH THE NAME AND CONTACT TELEPHONE NUMBERS (MOBILE, PAGER, AND RESIDENCE/HOTEL) OF THE NEXTEL APPROVED ON-SITE SUPERVISION MUST BE REPORTED TO THE SDM IMMEDIATELY AND ARE SUBJECT TO NEXTEL APPROVAL

B. PERMITS AND LICENSES

THE CONTRACTOR SHALL OBTAIN, AT HIS OWN EXPENSE, ALL REQUIRED LOCAL, STATE, AND/OR COUNTY CONSTRUCTION PERMITS AND LICENSES. COPIES OF ALL PERMITS SHALL BE SENT TO SOM. APPROVALS FROM RELEVANT PLANNING BOARDS, ENVIRONMENTAL BOARDS, AND/OR OTHER COMMITTEES WILL BE SUPPLIED BY OTHERS, BUT MUST BE CONFIRMED BY THE CONTRACTOR PRIOR TO THE APPLICATION FOR CONSTRUCTION

COMMENCEMENT OF WORK

MAJUR CATEGORY OR UNIT OF WORK TO BE PERFORMED AT SITE, PROPERLY SEQUENCED AND COORDINATED WITH OTHER ELEMENTS OF WORK. SHOW COMPLETION OF THE WORK SUFFICIENTLY IN ADVANCE OF THE DATE ESTABLISHED FOR SUBSTANTIAL COMPLETION OF THE WORK. THE SCHEDULE SHALL INCLUDE START AND FINISH DATES FOR THE FOLLOWING ITEMS.

COMMERCIAL AC POWER ANTENNA INSTALLATION

- PRIOR TO COMMENCING THE WORK, THE GENERAL CONTRACTOR SHALL SCHEDULE AN ON-SITE MEETING WITH ALL MAJOR PARTIES TO THE PROJECT. THIS WOULD INCLUDE (THOUGH NOT LIMITED TO) THE DESIGNATED ELECTRICIAN, LOCAL TELEPHONE COMPANY, CARPENTRY FOREMAN (IF SUBCONTRACTED), A
 REPRESENTATIVE FROM THE LOCAL SPECIFIED WAREHOUSE AND
 SDM OR HIS DESIGNATED REPRESENTATIVE.
- CONTRACTOR SHALL FIELD VERIFY ALL EXISTING UTILITIES BOTH HORIZOTALLY AND VERTICALLY PRIOR TO STRAT OF CONSTRUCTION. ANY DISCREPANCIES OR DOUBTS AS TO THE INTERPRETATION OF PLANS SHOULD BE IMMEDIATELY REPORTED TO THE ARCHITECT/ENGINEER FOR RESOLUTION AND NO FURTHER WORK SHALL BE PERFORMED UNTIL DISCREPANCY IS CHECKED AND CORRECTED BY THE ARCHITECT/ENGINEER. FAILURE TO SECURE SUCH INSTRUCTION MEANS CONTRACTOR WILL HAVE WORKED AT HIS OWN RISK AND EXPENSE.
- THE CONTRACTOR SHALL BE EQUIPPED WITH A MEANS OF CONSTANT COMMUNICATIONS, SUCH AS A CELLULAR PHONE OR A PAGER. THIS EQUIPMENT WILL NOT BE SUPPLIED BY NEXTEL COMMUNICATIONS NOR WILL SERVICE BE ARRANCED.
- THE CONTRACTOR IS RESPONSIBLE FOR ALL SAFETY INCLUDING BUT NOT LIMITED TO PROTECTION OF ALL SITE PERSONNEL AND THE GENERAL PUBLIC DURING THE ENTRE SITE CONSTRUCTION PERIOD. HE SHALL TAKE ALL REASONABLE PRECAUTIONS TO PLACE AND MAINTAIN BARRICADES, LAMPS, SIGNS, AND THE LIKE IN ACCORPANCE WITH OSHA SAFETY ACT AND ANSI OCCUPATIONAL GUIDELINFS.
- PROVIDE DAILY UPDATES ON SITE PROGRESS, EITHER VERBAL OR WRITTEN TO SDM.
- COMPLETE INVENTORY OF CONSTRUCTION MATERIALS AND EQUIPMENT IS REQUIRED PRIOR TO START OF CONSTRUCTION.
- NOTICES UNDER THE CONTRACT

K. COORDINATION WITH PUBLIC UTILITY AUTHORITIES

THE CONTRACTOR SHALL COORDINATE WITH RELEVANT AUTHORITIES THE WORKS THEY ARE TO DE CARRIED OUT. HE SHALL CONDUCT HIS OPERATIONS OF A TO NOT INTERFERE WITH THE OPERATIONS OF PUBLIC AND/OR PRIVATE UTILITY AUTHORITIES, INSTALLING SERVICES ON THE SITE.

THE CONTRACTOR WILL BE RESPONSIBLE FOR THE PROTECTION OF SUCH FACILITIES AND STRUCTURES DURING CONSTRUCTION OF THIS SITE.

L. INSPECTIONS

THE CONTRACTOR SHALL NOTIFY THE SDM AT LEAST 24 HOURS IN ADVANCE OF REQUIRED INSPECTIONS. INSPECTIONS THAT WILL BE REQUIRED BY THE SDM OR OTHER DESIGNATED NEXTEL REPRESENTATIVE ARE:

- INSPECTION OF GROUNDING SYSTEM
- PRACTICAL COMPLETION

THE CONTRACTOR SHALL BE SOLELY RESPONSIBLE FOR ENSURING THAT ALL RELEVANT AUTHORITY INSPECTIONS ARE CARRIED OUT IN A TIMELY MANNER. THE CONTRACTOR SHALL PROVIDE DOCUMENTATION OF ALL INSPECTIONS.

THE CONTRACTOR IS RESPONSIBLE FOR COORDINATING WITH NEXTEL'S DESIGNATED ENGINEERING FIRM TO OBTAIN ALL REQUIRED INSPECTIONS AND TESTING. THE CONTRACTOR SHALL PROVIDE DOCUMENTATION OF ALL INSPECTIONS.

M. ENVIRONMENTAL PROTECTION

NOISE LEVEL: THE CONTRACTOR SHALL ENSURE THAT STATE AND LOCAL REGULATIONS ARE COMPUED WITH IN REGARD TO NOISE LEVELS PRODUCED BY HIS OR HIS SUB-CONTRACTOR'S EQUIPMENT OR METHODS OF CONSTRUCTION.

DUST CONTROL: THE CONTRACTOR SHALL TAKE ALL NECESSARY STEPS TO LIMIT THE CREATION OF ANY DUST NUISANCE THAT MIGHT ARISE DURING CONSTRUCTION TO THE SATISFACTION OF THE LOCAL AUTHORITIES AND THE BUILDING OWNER. THE SDM MAY DIRECT THAT WORK CEASE UNTIL SUCH TIME AS ANY PARTICULAR DUST NUISANCE IS CONTROLLED TO THE SATISFACTION OF THE SDM, LOCAL AUTHORITIES, AND BUILDING OWNERS.

N. REINSTATEMENT

ANY PAVEMENT, FOOTPATH, CURB, GUTTERS, WALLS, FLOORS, SERVICES, AND EXISTING FEATURES OR OTHER PROPERTIES, DISTURBED OR DESTROYED DURING CONSTRUCTION SHALL BE REINSTATED TO A CONDITION AT LEAST EQUAL TO THAT EXISTING BEFORE COMMENCEMENT OF DEHANIUMS.

AS-BOULTS URANINGS

THE CONTRACTOR SHALL PREPARE A RED LINED SET OF ASBULL DRAWINGS. THE FORM OF MARKED UP CONSTRUCTION
PLANS SHALL BE STANDARD ACCEPTABLE TO THE SOM SUCH
DRAWINGS SHALL BE SUBMITTED TO THE SOM WITHIN TWO WEEKS
FROM PRACTICAL COMPLETION AND PRIOR TO APPROVAL OF THE
CONTRACTOR'S FINAL INVOICE.

P. PRACTICAL COMPLETION

DOCUMENTATION BY NEXTEL BEFORE COMPLETION CAN BE ISSUED

- ALL QUALITY ASSURANCE CHECKLISTS AS OUTLINED IN THE PREVIOUS SECTIONS
- 2. WARRANTIES AND MAINTENANCE MANUALS, IF APPLICABLE
- 3. GROUND SYSTEM RESISTANCE TEST

MARKED UP DRAWINGS SUITABLE TO PRODUCE AS—BUILTS WILL BE REQUIRED WITHIN TWO WEEKS FOLLOWING PRACTICAL COMPLETION AND BEFORE FINAL PAYMENT. THESE DRAWINGS SHALL BE SUBMITTED TO THE SDM FOR APPROVAL AND FURTHER PROCESSING.

LINE WAIVERS AS OUTLINED IN THE PAYMENT TERMS OF THE CONTRACT WILL BE REQUIRED PRIOR TO APPROVAL OF FINAL

1 - 1.16 INSURANCE AND BONDS:

- A. EACH CONTRACTOR SHALL AT HIS OWN EXPENSE CARRY AND MANI AIN FOR I HE DURATION OF THE PROJECT ALL INSURANCE AS REQUIRED AND LISTED AND SHALL NOT COMMENCE WITH HIS WORK UNTIL HE HAS PRESENTED A CERTIFICATE OF INSURANCE STATING ALL COVERAGES TO THE GENERAL CONTRACTOR WHO SHALL, IN TURN, FORWARD A COPY OF ALL CERTIFICATES TO THE SDM.
- NEXTEL COMMUNICATIONS SITE NO. FL3672B, WINSTON PARK SHALL BE NAMED AS ADDITIONAL INSURED ON ALL POLICIES.
- C. THE FOLLOWING ITEMS ARE QUALIFICATIONS THAT NEXTEL COMMUNICATIONS WILL REQUIRE FROM THE CONTRACTOR WHO IS AWARDED THE CONTRACT.
 - 1. CONTRACTOR MUST PROVIDE PROOF OF INSURANCE MEETING NEXTEL COMMUNICATIONS INSURANCE REQUIREMENTS. THE FOLLOWING IS A LIST OF MINIMUM INSURANCE REQUIREMENTS REQUIRED BY NEXTEL COMMUNICATIONS:

STATUTORY WORKERS' COMPENSATIONS, INCLUDING \$500.000.00 EMPLOYERS' LIABILITY.

- 2. COMPREHENSIVE GENERAL LIABILITY INCLUDING PERSONAL INJURY, BROAD FORM PROPERTY DAMAGE, INDEFENDENT CONTRACTOR. "XCU". AND PRODUCTS/COMPLETED OPERATIONS, WITH LIMITS NOT LESS THAN \$2,000,000.00 PER OCCURRENCE.
- 3. ADDITIONAL INSURED ENDORSEMENT NAMING NEXTEL COMMUNICATIONS AND KIMLEY-HORN AND ASSOCIATES, INC. ON THE LIABILITY POLICIES OF THE CONTRACTOR.
- 4. AUTOMOBILE LIABILITY NOT LESS THAN \$1,000,000.00 PER OCCURRENCE
- 5. EXCESS LIABILITY "UMBRELLA" POLICY OF \$5,000,000.00 PER OCCURRENCE.

NEXTEL **COMMUNICATIONS** 6700 N. ANDREWS AVENUE

SUITE 700 FT. LAUDERDALE, FLORIDA 33309 (954) 275-2400



Kimley-Horn and Associates, inc.

(C) 1998 KIMLEY-HORN AND ASSOCIATES, INC. CADERO DRIVE, WEST PALM BEACH, FL 33407 PHONE: (561) 845 0665

REGISTRATION NUMBERS KIMLEY HORN & ASSOCS., INC. FB0000696 DAVID STEWART PE 31180

CHARLES GEER

RUSSELL MORRISON

KIRK DROST

Late JAN 1 7 2001

PE 31435

PE 51910

SEAL REVISIONS NO. DATE DESCRIPTION

PROJECT MANAGER _____ __ DATE: NEXTEL __RF:__ DATE: _ PROPERTY OWNER ____ _ DATE: _

ANTENNA INSTALLATION

AT WINSTON PARK

SITE NUMBER: FL 3672A

AJD

DWS

SCALE: AS SHOWN DESIGNED BY: JBC

DATE: JANUARY 2001 KHA PROJECT NUMBER 044201071 DRAWING NUMBER

G-1

SHEET TITLE GENERAL NOTES #1

SHEET NUMBER

DRAWN BY:

APPROVED BY:

3

17

044201071
G-1.dwg
1*=1*

This document, together with the concepts and designs presented herein, as a instrument of service, is intended only for the specific purpose and client for which it was prepared. Reuse of our dispragar relations on this document without written authorization and adaptation by Kimley-Horn and Associates, Inc., shall be without liability to Kinley-Horn and Associates, Inc., shall be without liability to Kinley-Horn and Associates, Inc.

COMPILANCE
ALL MATERIALS, DESIGN, AND WORKMANSHIP SHALL DE IN
ACCORDANCE WITH ALL APPLICABLE CODES (SOME OF WHICH ARE
LISTED BELOW), ORDINANCES, AND AUTHORITES HAVING
JURISDICTION OVER THE WORK. UPON THE COMPLETION OF THE
WORK, THE CONTRACTOR SHALL PROVIDE NEXTEL WITH A
CERTIFICATE OF OCCUPANCY (IF REQUIRED) AND OTHER LEGAL
DOCUMENTS TO EXPIRY SUCH COMPILANCE. WHERE NO CODES
EXIST, THE WORK SHALL CONFORM WITH THE STANDARD
BUILDING CODE, AND/OR THE
SPECIFICATIONS HEREIN, WHICHEVER IS MORE STRINGENT, AND
A DOCUMENT STATEMENT SHALL BE FURNISHED TO THIS EFFECT.

FAA APPROVAL WILL BE SUPPLIED BY OTHERS, BUT MUST BE CONFIRMED BY THE CONTRACTOR WITH THE SDM PRIOR TO THE

SUBMIT A BAR CHART TYPE PROGRESS SCHEDULE NOT MORE THAN 3 DAYS AFTER THE DATE ESTABLISHED FOR COMMENCEMENT OF THE WORK ON THE SCHEDULE. INDICATE A TIME BAR FOR EACH MAJOR CATEGORY OR UNIT OF WORK TO BE PERFORMED AT SITE,

BUILDING PERMIT FINISH CARPENTRY INSPECTIONS GROUNDING SYSTEM

ALL NOTICES, APPLICATIONS, INSTRUCTIONS AND REQUESTS TO BE GIVEN TO THE CONTRACT MAY BE GIVEN VERBALLY OR IN WRITING. AT HIS OWN DISCRETION, THE CONTRACTOR SHALL FORWARD TO THE SDM A LETTER CONFORMING HIS VERBALL AGREEMENT.

- CONTRACTOR SHALL PERFORM ALL VERIFICATION OBSERVATIONS TESTS, AND EXAMINATION WORK PRIOR TO THE ORDERING OF THE ELECTRICAL EQUIPMENT AND THE ACTUAL CONSTRUCTION. CONTRACTOR SHALL ISSUE A WRITTEN NOTICE OF ALL FINDINGS TO THE ARCHITECT LISTING ALL MALFUNCTIONS, FAULTY EQUIPMENT AND
- 3. HEIGHTS SHALL BE VERIFIED WITH OWNER PRIOR TO INSTALLATION.
- 4. THESE PLANS ARE DIAGRAMMATIC ONLY, FOLLOW AS CLOSELY AS POSSIBLE.
- EACH CONDUCTOR OF EVERY SYSTEM SHALL BE PERMANENTLY TAGGED IN EACH PANEL BOARD, PULLBOX, J-BOX, SWITCH BOX, ETC., IN COMPLIANCE WITH OCCUPATIONAL SAFETY AND HEALTH ADMINISTRATION
- CONTRACTOR SHALL PROVIDE PANEL BOARD DIRECTORY IN TYPING FORM. HAND WRITTEN FORM IS NOT ACCEPTABLE.
- CONTRACTOR SHALL PROVIDE ALL LABOR, MATERIALS, INSURANCE, EQUIPMENT, INSTALLATION, CONSTRUCTION TOOLS, TRANSPORTATION, ETC. FOR A COMPLETE AND PROPERLY OPERATIVE SYSTEM ENERGIZED THROUGHOUT AND AS INDICATED ON DRAWNGS, AS SPECIFIED HEREIN AND/OR AS OTHERWISE REQUIRED.
- AND/OR AS DIHERWISE REQUIRED.

 ALL MATERIALS AND EQUIPMENT SHALL BE NEW AND IN PERFECT CONDITION WHEN INSTALLED AND SHALL BE OF THE BEST GRADE AND OF THE SAME MANUFACTURENT TIRROUGIOUT FOR EACH CLASS OR FROUP OF EQUIPMENT. MATERIALS SHALL BE INSTED "I" WHERE SUBJECT TO SUCH APPROVAL. MATERIALS SHALL MEET WITH APPROVAL OF THE DIVISION OF INDUSTRIAL SAFETY AND ALL GOVERNING BODIES HAVING JURISDICTION. MATERIALS SHALL BE MANUFACTURED IN ACCORDANCE WITH APPLICABLE STANDARDS ESTABLISHED BY ANSI, NEMA, NBFU AND "U." LISTED.
- CONTRACTOR SHALL PERFORM HIS WORK IN ACCORDANCE WITH ALL GOVERNING STATE, SBC, NEC, COUNTY AND LUCAL CODES AND O.S.H.A.
- 10. CONTRACTOR SHALL SECURE ALL NECESSARY BUILDING PERMITS AND PAY ALL REQUIRED FEES PURSUANT TO THE WORK.
- 11. COMPLETE JOB SHALL BE GUARANTEED FOR A PERIOD OF ONE (1) YEAR AFTER THE DATE OF JOB ACCEPTANCE BY OWNER. ANY WORK, MATERIAL OR EQUIPMENT FOUND TO BE FAULTY DURING THAT PERIOD SHALL BE CORRECTED A ONCE, UPON WRITTEN NOTIFICATION, AT THE EXPENSE OF
- 12. ALL CONDUIT SHALL HAVE A PULL WIRE OR ROPE.
- 13. PROVIDE SDM WITH ONE SET ON COMPLETE ELECTRICAL "AS INSTALLED" DRAWINGS AT THE COMPLETION OF THE JOB, SHOWING ACTUAL DIMENSIONS, ROUTINGS, AND
- 14. ALL BROCHURES, OPERATING MANUALS, CATALOGS, SHOP DRAWNGS, ETC. SHALL BE TURNED OVER TO SDM AT JOB COMPLETION.
- USE T-TAP CONNECTIONS ON ALL MULTI-CIRCUITS WITH COMMON NEUTRAL CONDUCTOR FOR LIGHTING FIXTURE.
- 16. ALL CIRCUIT BREAKERS, FUSES AND ELECTRICAL FOUIPMENT SHALL HAVE AN INTERRUPTING SHORT CIRCUIT CURRENT TO WHICH THEY MAY BE SUBJECTED, AND A MINIMUM OF 10,000 A.I.C.
- THE ENTIRE ELECTRICAL INSTALLATION SHALL BE GROUNDED AS REQUIRED BY SBC. NEC AND ALL APPLICABLE CODES.
- 18. PATCH, REPAIR AND PAINT ANY AREA THAT HAS BEEN DAMAGED IN THE COURSE OF THE FLECTRICAL WORK.
- 19. PENETRATIONS IN FIRE RATED WALLS SHALL BE FIRE STOPPED IN ACCORDANCE WITH APPLICABLE LOCAL BUILDING CODES.
- 20. RECEPTACLES SHALL BE 20 AMPERE, 125 VOLT A.C., HUBBELL #5362, WHITE. MOUNT ALL RECEPTACLES AT 18" A.F.F. OR AS REQUIRED BY THE SDM, OR APPROVED
- 21. WALL SWITCHES SHALL BE 15 AMPERE, 120 VOLT AC, SINGLE-POLE, HUBBELL #1201, WHITE OR AS REQUIRED BY THE SDM.
- 22. PLASTIC PLATES FOR ALL SWITCHES, RECEPTACLES, PLASID PLATES FOR ALL SWITCHES, RELEFIACLES, TELEPHONE AND BLANKED OULETS, SHALL HAVE ENGRAVED LETTERING WHERE INDICATED ON THE DRAWNIGS. WEATHERPROOF RECEPTACLES SHALL HAVE SIERRA #WPD-8 LIFT COVERPLATES.
- 23. WIRE AND CABLE CONDUCTORS SHALL BE COPPER, 600V TYPE THEN OR THWN, WITH A MINIMUM SIZE OF #12 AWG, COLOR CODES. ALL RECTIFIER DROPS SHALL BE STRANDED TO ACCEPT CRIMP CONNECTORS.
- 24 CROUNDING CONDUCTORS SHALL BE SOLID TINNED COPPER AND ANNEALED #2.
- 25. ALL CONDUCTORS SHALL BE COPPER
- 26. ALL MATERIALS SHALL BE "UL" APPROVED.
- 2/. MEIER SOCKET AMPERES, VOLTAGE, NUMBER OF PHASES SHALL DE AS NOTED ON THE DRAWINGS. MANUFACTURED BY SQUARE "D" COMPANY OR APPROVED EQUAL.
- 28. CONDUIT:
 - A RIGID CONDUIT SHALL BE ILL LABEL GALVANIZED INGUI CONDOIT SHALL BE U.L. EABEL GALVANIZED ZINC COATED WITH ZINC INTERIOR AND SHALL BE USED WHEN INSTALLED IN OR UNDER CONCRETE SLABS, IN CONTACT WITH THE EARTH, UNDER PUBLIC ROADWAYS, IN MASONRY WALLS OR EXPOSED ON BUILDING EXTERIOR. RIGID CONDUIT IN CONTACT WITH FARTH SHALL BE 1/2 LAPPED WRAPPED WITH HUNTS WRAP PROCESS NO. 3.
 - B.F. FCTRICAL METALLIC TUBING SHALL HAVE U.L. LISTED LABEL, FITTING SHALL BE GLAND RING COMPRESSION TYPE. EMT SHALL BE USED ONLY FOR

044201071
G-2.dwg
09-27-00
1*=1

his document, together with the concepts and designs presented herein, as an instrument of service, is intended only for the specific purpose and client for which it was prepared. Reuse of an dimproper relations on this document without written authorization and adoptation by Kimley-Horn and Associates, inc. shall be without illosity to Kimley-Horn and Associates, inc. shall be without illosity to Kimley-Horn and Associates, inc. shall be without illosity to Kimley-Horn and Associates, inc.

- C.FLEXIBLE METALLIC CONDUIT SHALL HAVE U.L.
 LISTED LABEL AND MAY BE USED WHERE PERMITTED BY
 CODE. FITTINGS SHALL BE "JAKE" OR "SQUEZZE"
 TYPE, SEAL TIGHT FLEXIBLE CONDUIT. ALL CONDUIT
 IN EXCESS OF SIX FECT IN LENGHI SHALL HAVE FULL
- D.CONDUIT RUNS MAY BE SURFACE MOUNTED IN CEILING OR WALLS UNIESS INDICATED OTHERWISE, CONDUIT INDICATED SHALL RUN PARALLEL OR AT RIGHT ANGLES TO CEILING, FLOOR OR BEAMS, VERIFY EXACT ROUTING OF ALL EXPOSED COMDUIT WITH ARCHITECT PRIOR TO INSTALLING.
- E.ALL ALARMS SHALL RF (2) #22 AWG AND BE RUN FROM EACH OF THE ITEMS AS INDICATED ON DRAWNICS. THE ALARM WIRES SHALL HAVE AN ADDITIONAL LENGTH REACHING TO THE FLOOR, TAGGED AND LABELED WITH THE APPROPRIATE ALARM ITEM. ALL CONTACTS WILL BE NORMALLY CLOSED, DRY AND ISOLATED FROM CROUND. ALARM WILL BE NEATLY RUN AND SECURED EVERY THREE FEET TO WALLS AND EXISTING CABLE TRAY.
- 29. CONTRACTOR TO COORDINATE WITH UTILITY COMPANY FOR CONNECTION OF TEMPORARY AND PERMANENT POWER TO SITE. THE TEMPORARY POWER AND ALL HOUKUP COSTO BE PAID BY CONTRACTOR.
- 30. ALL ELECTRICAL EQUIPMENT SHALL BE LABELED WITH PERMANENT ENGRAVED PLASTIC LABELS.
- 31. UPON COMPLETION OF WORK, CONDUCT CONTINUITY, SHORT CIRCUII, AND FALL POLENIAL GROUNDING TESTS FOR APPROVAL. SUBMIT TEST REPORTS TO SOM. CLEAN PREMISES OF ALL DEBRIS RESULTING FROM WORK AND LEAVE WORK IN A COMPLETE AND UNDAWAGED CONDITION.
- 32. GROUNDING ELECTRODE SYSTEM
 - A. PREPARATION
 - 1.SURFACE PREPARATION

ALL CONNECTIONS SHALL BE MADE TO BARE METAL.
ALL PAINTED SURFACES SHALL BE FIELD INSPECTED
TO ENSURE PROPER CONTACT. NO WASHERS ARE
ALLOWED BETWEEN THE HEMS BEING GROUNDED. ALL
CONNECTIONS ARE TO HAVE A NON-OXIDIZING AGENT
APPLIED PRIOR TO INSTALLATION.

GROUND BAR PREPARATION:

ALL COPPER CROUND BARS SHALL BE CLEANED, POLISHED AND A NON-OXIDIZING AGENT APPLIED. NO FINGERPRINTS OR DISCOLORED COPPER WILL BE PERMITTED.

SLEEVES:

ALL GROUNDING CONDUCTORS SHALL RUN THROUGH PVC SLEEVES WHEREVER CONDUCTORS RUN THROUGH WALLS, FLOORS OR CEILINGS. IF CONDUCTORS MUST RUN THROUGH EMT, BOTH ENDS OF CONDUIT SHALL BE GROUNDED. SEAL BOTH ENDS OF CONDUIT WITH SILICONE CAULK.

B.GROUND BARS

ALL GROUND BARS SHALL BE 1/4" THICK BARE COPPER PLATE AND OF SIZE INDICATED ON DRAWINGS. C.INTERIOR CONNECTIONS

1. ALL INTERIOR NON-ELECTRICAL MATERIALS, I.E.
HVAC GRILLES, HOLLOW METAL DOOR FRAMES/DOORS,
CABLE HAYS, IELCO ENHANCE CONDUIT (EM
ONLY), ETC. SIALL BE GROUNDED WITH 6 GREEN
GROUND WIRES OR JIMPERS WITH SING!F HOME RUNS
BACK TO THE MASTER GROUND BAR (THE CABLE
TRAY, DOOR/FRAME AND STEEL CHANNEL MAY BE
JUMPED TOGETHER AND HAYE A SINGLE GROUND WIRE
CONNECTION TO THE MASTER GROUND BAR). ALL
PAINT OR DELETERIOUS MATERIAL SHALL BE
REMOVED AT THE POINT OF ATTACHMENT OF ALL
GROUND JUMPERS, ALL SINGLE LUC CONNECTORS
MUST BE BOLT-THRU USING STAR AND LOCK
WASHERS, DOUBLE LUG CONNECTORS MAY BE
SCREWED WITH START WASHERS.

D.EXTERNAL CONNECTIONS

- 1.ALL GROUNDING COMECTIONS SHALL BE MADE BY THE "CADWELD" PROCESS. CONNECTIONS SHALL INCLUDE ALL CABLE TO CABLE. SPLICES, TEE'S X'S ETC. ALL CABLE TO GROUND RODS, GROUND ROD SPLICES AND LICHTINING PROTECTION SYSTEM AS INDICATED. ALL MATERIALS USED (MOLDS, WELDING METAL, TOOLS, ETC.) SHALL BE BY "CADWELD" AND INSTALLED PER MANUFACTURER'S RECOMMENDATIONS AND PROCEDURES.
- 2.ALL GROUNDING AND BONDING CONDUCTORS SHALL BE CONNECTED BY TWO HOLES CRIMP TYPE (COMPRESSION) CONNECTIONS (EXCEPT FOR THE ACEG AND GROUND ROD) MECHANICAL CONNECTIONS, FITTING OR CONNECTIONS THAT DEPEND SOLELY ON SOLDER SHALL NOT BE USED.
- 3.INTERIOR WAVEGUIDE PORT SHALL BE GROUNDED TO THE INTERIOR MASTER GROUND BAR LOCATED BELOW THE WAVEGUIDE ENTRY PORT, WITH 6 SOLID WIRE. THESE CONNECTIONS SHALL BE DOUBLE LUG—BOLTED, SCREWED MECHANICAL CONNECTIONS WITH STAR WASHERS AND NON-OXIDIZING GREASE.

ALL GROUND CABLES SHALL BE STANDARD TNND SOLID BARE COPPER AND OF SIZE INDICATED ON DRAWINGS UNLESS INDICATED OTHERWISE

LUGS SHALL BE 2-HOLE, SHORT BARREL, STRAND COPPER UNLESS OTHERWISE SPECIFIED IN THIS DOCUMENT. LUGS SHALL BE THOMAS AND BETTS SERIES 548 BE OR EQUIVALENT.

535 MCM DLO 262 MCM DLO #1/0 DLO #4/0 THWN AND BARE #2/0 THWN #2 THHN #6 DLO

54862BE 54866BE 54862BE 54207BE 54205BE

2. WHEN THE DIRECTION OF THE CONDUCTOR MUST CHANGE, IT SHALL BE DONE GRADUALLY. THE CURVATURE OF THE TURN SHALL BE DONE IN ACCORDANCE WITH THE FOLLOWING CHART:

GROUND CONDUCTOR SIZE

NO. 6 AWG TO NO. 4 AWG NO. 2 AWG TO NO., 1/0 AWG NO. 2/0 AWG TO 750 MCM BUS BAR 8 INCHES 1 FOOT NO RESTRICTIONS

33. ASTM FALL POTENTIAL TESTS

1. FOR TENANT IMPROVEMENT SITES, TESTING CAN BE DONE USING THE AEMC MODEL #3700 TESTER TEST THE INTERFACE BETWEEN THE ANTENNA GROUNDING CONDUITS AND BUILDING STEEL, THE SITE CROUND BUSS CONDUCTOR AND BUILDING STEEL, AND THE CONDUCTOR BETWEEN THE MASTER GROUND BAR (MGB) AND THE VERTICAL EQUALIZER

COAXIAL CABLE

3-1.01 GENERAL

- WORK SHALL BE NEW AND OF STANDARD COMMERCIAL QUALITY
- CERTAIN MATERIALS AND PRODUCTS WILL DE SUPPLIED DY NEXTEI COMMUNICATIONS (REFER TO THE HINDEX FOR THE "LIST OF NEXTEI COMMUNICATIONS FURNISHED EQUIPMENT, MATERIALS AND SUPPLIES" FOR THESE ITEMS). THE CONTRACTOR IS RESPONSIBLE FOR PICK-UP AND DELIVERY TO SITE ALL NEXTEL COMMUNICATIONS FURNISHED MATERIALS.
- ALL OTHER MATERIALS AND PRODUCTS SHOWN IN THE SPECIFICATIONS SKETCHES, DRAWINGS, GENERAL CONTRACT DOCUMENTS, ADDENDIMS, AMENDMENTS AND/OR INSTRUCTION SHALL BE SUPPLIED BY THE CONTRACTOR.

A. ANTENNAS:

INSTALLATION OF ANTENNAS AND ASSOCIATED MOUNTINGS SHALL USE HARDWARE PER MANUFACTURES RECOMMENDED STANDARDS OF

B. CABLE:

INSTALLATION OF COAXIAL CABLE AND TERMINATIONS BETWEEN ANTENNAS AME EQUIPMENT ROOM THE TRONGS PERCITOR. ANTENNAS AME EQUIPMENT ROOM THE TRONGS PERCITOR. ALL CONVECTORS BETWEEN THE ANTENNA AND EQUIPMENT SPACE ENTRY PORT SHALL BE WEATHER PROFED WITH A WEATHER PROJETION OF ROOM THE PROVIDED BY THE CONTRACTOR ALL COAX TO TERMINATE ONE FOOT INSIDE EQUIPMENT SPACE OR BUILDING UNLESS OTHERWISE STATED.

- 1. CABLE SPECIFICATION:
- A. 1 5/8" DIA COAXIAL CABLE ANDREW LDF 7-50A B. 1 1/4" DIA COAXIAL CABLE ANDREW LDF 6-60 C. 7/8" DIA COAXIAL CABLE ANDREW LDF 6-50 D. 1/2" DIA COAXIAL CABLE ANDREW LDF 4-75A
- 2. HOISTING GRIP
- A. FOR 1 5/8" DIA COAXIAL CABLE USE ANDREW 24312A FOR 1/1/4" DIA COAXIAL CABLE - USE ANDREW 19961
- C. FOR 7/8" DIA COAXIAL CABLE USE ANDREW 19256B D. FOR 1/2" DIA COAXIAL CABLE - USE ANDREW 43094
- 3-202 ANTENNA AND COAXIAL CABLE GROUNDING
 - A. THE DIRECTIONAL ANTENNA COAX CABLES ARE TO HAVE AS A MINIMUM OF TWO GROUND KITS INSTALLED, ONE AT THE ANTENNA JUMPER CONNECTION AND ONE AT THE WAVEGUIDE ENTRY PORT
 - B. ALL EXTERIOR #6 GREEN GROUND WIRE DAISY CHAIN CONNECTIONS ARE TO BE WEATHER SEALED WITH ANDREWS CONNECTION/SPLICE WEATHERPROUPING KIT TYPE #221213 U EQUAL.
 - ALL COAXIAL CABLE GROUNDING KITS ARE TO BE INSTALLED ON STRAIGHT RUNS (NOT WITHIN BENDS) OF COAX CABLE.
 - FOR 1 5/8" DIA COAXIAL CABLE USE ANDREW 241088—4 FOR 1 1/4" DIA COAXIAL CABLE USE ANDREW 241088—3 FOR 7/8" DIA COAXIAL CABLE USE ANDREW 241088—2 FOR 1/2" DIA COAXIAL CABLE USE ANDREW 241088—1
- 3-203 COAXIAL CABLE IDENTIFICATION
 - TO PROVIDE EASY IDENTIFICATION AND UNIFORM MARKING OF ANTENNA CABLING, THE FOLLOWING SHALL APPLY:
 - 1. LOCATION: MARKINGS SHALL BE MADE BY USE OF 3M COLORED, 1-INCH WIDE TAPE AFFIXED AT THREE PLACES ON THE COAX CABLE RUN AS FOLLOWS:
 - a. FIRST LOCATION IS AT THE END OF THE COAX NEAREST THE ANTENNA (WHERE THE COAXIAL CABLE AND JUMPER ARE CONNECTED).
 - b. SECOND, AT A POINT OUTSIDE THE WAVEGUIDE ENTRY PRIOR ENTERING THE BUILDING
 - c. THIRD, INSIDE THE EQUIPMENT SPACE, AT A POINT ON THE COAXIAL CABLE, APPROXIMATED FROM THE WAVEGUIDE ENTRY PORT.
 - 2. SECTOR IDENTIFICATION: NORMALLY A SITE WILL HAVE UP TO THREE SECTORS. SECTORS SHALL BE DESIGNATED BY NUMBERING EACH IN A CLOCKWISE MANNER. THE FIRST SECTOR IS THE ONE CLOSEST TO (MEASURING CLOCKWISE) ZERO DEGREES (TRUE, NORTH). THE SECOND AND INHID FOLLOW CLOCKWISE IN SEQUENCE. THEREFORE, THE MARKING OF ANTENNA CABLING IS AS FOIL OWE:
 - a. SECTOR #1 COAXIAL CABLE WILL HAVE ONF BAND OF A 1. SECTOR #1 COAXIAL CABLE WILL HAVE ONE BAND OF .
 PRE-SELECTED COLORED TAPE (REFER TO 3-204) FOR
 EACH COAXIAL RUN. NORMALLY SITES WILL
 INITIALLY GO ON THE AIR WITH AS FEW AS TWO ANTENNAS PER SECTOR AND AS THE SYSTEM GROWS, AN ADDITIONAL ONE TO TWO ANTENNAS MAY BE ADDED.

A. COLOR CODE

THE RULE IS TO FACE THE SECTOR UNDER OBSERVATION WHEN DETERMINING THE POSITIONING OF THE COAXIAL CABLE RUN AND ANTENNA ON THE BUILDING STRUCTURE.

- RED IS THE DESICNATED COLOR TAPE TO BE AFFIXED TO THE COAXIAL CABLE FOR THE RUN (ANTENNA) AT THE EXTREME LEFT.
- 2. GREEN IS THE DESIGNATED COLOR TAPE TO BE AFFIXED TO THE COAXIAL CABLE FOR THE RUN (ANTENNA) AT THE EXTREME RIGHT. AS A MEMORY AID, WHEN FACING (LOOKING) AT THE SPECIFIC SECTOR, THE LEFT HAND SIDE (RED) AND RIGHT HAND SIDE (GREEN) CORRESPONDS TO THE MARITIME "GREEN" FOR STARBOARD AND "RED" FOR PORTSIDE. THESE TWO COLORS DENOTE THE ANTENNAS AND COAXIAL CABLE AT THE EXTREME ENDS OF THE BUILDING STRUCTURE.
- BILIF IS THE DESIGNATED COLOR TAPE TO BE AFFIXED TO THE COAXIAL CABLE FOR THE THIRD ANTENNA/COAXIAL CABLE RON AND ANTENNA (MDDLE). AS A MEMORY AID, RUN THE COAXIAL CABLE COLORS WITH THE FLAG IM MIND, RED, GREEN AND BLUE. THIS WILL ASSIST IN REMEMBERING THE COLORS FOR THE TWO INSIDE COAXIAL CABLE/ANTENNAS.

B. EXAMPLES

- TWO BANDS OF RED TAPE DESIGNATES SECTOR TWO, AT THE EXTREME LEFT ANTENNA/COAXIAL CABLE RUN.
- TWO BANDS OF CREEN TAPE DESIGNATES SECTOR TWO, AT THE EXTREME RIGHT ANTENNA/COAXIAL CABLE RUN.
- TWO BANDS OF BLUE TAPE DESIGNATE SECTOR TWO, FOR THE THIRD ANTENNA/COAXIAL CABLE RUN (MIDDLE).
- 4. TRIPLE BANDS OF RED, GREEN, AND BLUE TAPE DESIGNATES SECTOR THREE (REMEMBER THE RULE IS TO FACE THE SECTOR UNDER OBSERVATION RED IS EXTREME LEFT, GREEN IS EXTREME RIGHT AND BLUE IS MIDDLE).

PROVIDE FOUR (4) SETS OF SWEEP TEST AND TOLD TEST RESULTS TO THE SDM. SWEEP TESTS SHALL BE AS PER ATTACHED ANDREW "MINIMUM FIELD TESTING RECOMMENDED FOR ANTENNA AND HELIAX COAXIAL CABLE SYSTEMS" DATE 10-5-93. DOCUMENTS ARE TO BE BOUND AND SUBMITTED WITHIN ONE WEEK OF WORK COMPLETION.

3-207 COAXIAL CABLE LIGHTNING SURGE PROTECTION

- ONE POLY-PHASER (REFERENCED ATTACHED CATALOG CUT)
 PER TRANSMISSION CABLE RUN.
- ONE TRI-LEVEL POLY-PHASER TRAPEZE HANGING ASSEMBLY (KIT TO BE ASSEMBLED).

THE POLY PHASER AND ASSOCIATED TRAPEZE HANGING ASSEMBLY SHOULD BE MOUNTED 1'-O' INSIDE THE WAVECUIDE ENTRY PORT AT 2'-6' A.F.F. A MINIMUM #6 GROUND WIRE SHOULD BE RUN FROM EACH LEVEL OF THE TRAPEZE HANGING ASSEMBLY TO THE MAIN GROUND BUSS SHAPE.

C & W engineering

2326 S. CONGRESS AVE., 2E, WPB, FL. 33406

ELECTRICAL CONSULTANTS

(407) 642-5333



6700 N. ANDREWS AVENUE SUITE 700 FT. LAUDERDALE, FLORIDA 33309 (954) 275-2400



Kimley-Horn and Associates, inc.

© 1998 KIMLEY-HORN AND ASSOCIATES, INC. 1431 EMBARCADERO DRIVE, WEST PALM-BEACH, FL 3340 PHONE: (561) 845 0665

REGISTRATION NUMBERS

KIMLEY HORN & ASSOCS., INC. FB0000696 DAVID STEWART PE 31180 CHARLES GEER PE 31435 KIRK DROST PF 51910

1-15-01

SEAL

REVISIONS NO. DATE DESCRIPTION

APPROVALS PROJECT MANAGER ______ DATE: .___ NEXTEL RF: ___ DATE: ___ PROPERTY OWNER ___ υΑΤΕ: __

ANTENNA INSTALLATION AT WINSTON PARK SITE NUMBER: FL 3672A

SCALE: AS SHOWN DESIGNED BY: JBC DRAWN BY: AJD APPROVED BY: DGW DATE: JANUARY 2001

KHA PROJECT NUMBER 044201071 DRAWING NUMBER G-2SHEET TITLE

GENERAL NOTES #2

OF

SHEET NUMBER

4

17

b. SECTOR #2 COAXIAL CABLE WILL HAVE TWO BANDS OF PRE-SELECTED COLORED TAPE.

c. SECTOR #3 COAXIAL CABLE WILL HAVE THREE BANDS OF PRE-SELECTED COLORED TAPE.

1. SECTION INCLUDES:

STRUCTURAL—STEEL—FRAMING—MEMBERS,—BASE—PLATES,—PLATES,—BARS AND CROUTING UNDER BASE PLATES. SUBMITTALS:

SHOP DRAWINGS: INDICATE SIZES, SPACING, AND LOCATIONS OF STRUCTURAL MEMBERS, OPENINGS, CONNECTIONS, CAMBERS, LOADS, AND WELDED SECTIONS.

- 3. QUALITY ASSURANCE
- A. FABRICATE STRUCTURAL STEEL MEMBERS IN ACCORDANCE WITH ASC SPECIFICATIONS FOR THE DESIGN, FABRICATION AND ERECTION OF STRUCTURAL STEEL FOR BUILDINGS.
- B. PERFORM DESIGN UNDER DIRECT SUPERVISION OF A PROFESSIONAL STRUCTURAL ENGINEER LICENSED IN THE STATE.

PART 2 - PRODUCTS

MATERIALS:

STRUCTURAL STEEL MEMBERS: STRUCTURAL TUBING: PIPE:

GALVANIZING

BOLTS, NUTS AND WASHERS ANCHOR BOLTS WELDING MATERIALS GROUT

ASTM A36
ASTM A325
ASTM A325
ASTM A325
ASTM A307
AWS D1.1, TYPE REQUIRED FOR MATERIALS BEING WELDED
NON—SHRINK TYPE, PREMIXED COMPOUND CONSISTING OF
NONMETALLIC AGGREGATE, CEMENT, WATER REDUCING
AMD PLASTRICIZING ADDITIVES, CAPABLE OF DEVELOPING
A MINIMUM COMPRESSIVE STRENGTH OF 7000 PSI AT 28
DAYS

ASTM A36

SHOP AND TOUCH-UP PRIMER SSPC 15, TYPE 1, RED OXIDE TOUCH-UP PRIMER FOR GALV. ZINC RICH TYPE SURFACES

ASTM A501, GRADE B ASTM A53, TYPE E OR S, CRADE B

2. FABRICATION

CONTINUOUSLY SEAL JOINTED MEMBERS BY CONTINUOUS WELDS. GRIND EXPOSED WELDS SMOOTH.

FINISH

- A. PREPARE STRUCTURAL COMPONENT SURFACES IN ACCORDANCE WITH SSPC SP-1 TO SP-10 PROCEDURES.
- SHOP PRIME STRUCTURAL STEEL MEMBERS. DO NOT PRIME SURFACES THAT WILL BE FIELD WELDED, IN CONTACT WITH CONCRETE, OR HIGH STRENGTH BOLTED.

1 FXAMINATION AND PREPARATION

VERIFY THAT THE FIELD CONDITIONS ARE ACCEPTABLE

- A. ALLOW FOR ERECTION LOADS. PROVIDE TEMPORARY BRACING TO MAINTAIN FRAMING IN ALIGNMENT UNTIL COMPLETION OF ERECTION AND INSTALLATION OF PERMANENT BRIDGING AND BRACING.
- B. FIELD WELD COMPONENTS INDICATED ON SHOP DRAWINGS.
- D. AFTER ERECTION, PRIME WELDS, ABRASIONS, AND SURFACES NOT SHOP PRIMED OR GALVANIZED EXCEPT SURFACES TO BE IN CONTACT WITH CONCRETE.

FIELD INSPECTION OF MEMBERS, CONNECTIONS, WELDS AND TORQUING.

PART 1 - GENERAL

SCOPE

- GENERAL WELDING REQUIREMENTS FOR ALL PORTIONS OF THE PROJECT (FIELD & SHOP).
- B. SECTION COVERING PARTS OF THE PROJECT THAT REQUIRE WELDING, WELDING CODES, WELDING DOCUMENTATION, WELDING INSPECTION & NONDESTRUCTIVE TESTING REQUIREMENTS.
- SUBMITTALS
 - A. THE FOLLOWING SPECIFIC INFORMATION SHALL BE PROVIDED BY THE CONTRACTOR
 - WELDING PROCEDURE: CONTRACTOR SHALL SUBMIT ALL SHOP AND FIELD WELDING PROCEDURE SPECIFICATIONS AND SUPPORTING WEIDING PROCEFIDING PROCEDURE FOR REVIEW PRIOR TO ANY WELDING. WELDING DOCUMENTATION SHALL BE SUBMITTED ON APPROPRIATE FORMS FOUND IN THE APPENDIXES TO THE REFERENCED WELDING CODES.
 - 2. WELDER/WELDING OPERATOR QUALIFICATIONS: THE CONTRACTOR WELDER, WELDING OPERATOR QIALIFICATIONS: THE CONTRACTOR SHALL SUBMIT ALL SHOP AND FIELD WELDER OR WELDING OPERATOR PERFORMANCE QUALIFICATION RECORDS PRIOR TO ANY WELDING. DOCUMENTATION SHALL BE SUBMITTED ON APPROPRIATE FORMS FOUND IN THE APPENDIXES OF REFERENCED WELDING CODES.
 - WELDING INSPECTOR CREDENTIALS: IF SPECIFIED TO PROVIDE ON SITE WELDING INSPECTION, THE CONTRACTOR SHALL SUBMIT THE CREDENTIALS OF THE WELDING INSPECTOR TO BE EMPLOYED BY THE CONTRACTOR FOR REVIEW BY THE CONSTRUCTION BY THE CONTRACTOR FOR REVIEW BY THE CONSTRUCTION MANAGER PRIOR TO STARTING ANY WEDDING. THE CREDENTIALS SHALL INCLUDE, BUT NOT BE LIMITED TO, AMERICAN WELDING SOCIETY QCL CRITIFICATION. THE WELDING INSPECTOR SHALL HAVE PRIOR INSPECTION EXPERIENCE WITH ALL APPLICABLE WELDING COPES. THE WELDING COPETOR SHALL BE PRESENT WHENEVER ANY SHOP OR FIELD WELDING IS PERFORMED. THE DUTIES OF THE WELDING INSPECTOR SHALL INCLUDE, BUT NOT BE LIMITED TO, THE FOLLOWING:

 - VERIFYING JOB MATERIAL AND STORAGE MONITOR CONFORMANCE WITH APPROVED WELDING PROCEDURE SPECIFICATIONS CHECK WELDING AND WELDING OPERATOR QUALIFICATION

 - C. CHECK MEDING AND WELDING OF LINEATON
 SUPERVISE NONDESTRUCTIVE TESTING PERSONNEL AND
 EVALUATION OF TEST RESULTS
 MAINTAIN RECORDS AND PREPARE REPORTS

TESTING AGENCY CREDENTIALS: THE CONTRACTOR SHALL RETAIN A QUALIFIED TESTING AGENCY EMPLOYING PERSONNEL EXPERIENCED IN NONDESTRUCTURY TESTING. THE TESTING AGENCY SHALL PERFORM RADIOGRAPHY, ULTRASONIC, MAGNETIC PARTICLE, LIQUID FENETRANT, AND OTHER TESTING METHODS AS SPECIFIED. PERSONNEL EMPLOYER BY THE TESTING ACENCY SHALL BE CERTIFIED IN ACCORDANCE WITH THE CURRENT AMERICAN SOCIETY OF NON DESTRUCTURY TESTING (4153 ARLINGATE PLAZA, COLUMBUS, OH 43228) RECOMMENDED PRACTICE NO. SNT—TC—14 AND ALL SUPPLEMENTS, NOT LEVEL II. THE CONTRACTOR SHALL SUBMIT THE CREDENTIALS OF THE TESTING AGENCY AND PERSONNEL FOR REVIEW BY THE CONSTRUCTION MANAGER PRIOR TO ANY WELDING.

NONDESTRUCTIVE TESTING PROCEDURE SPECIFICATIONS: THE CONTRACTOR SHALL SUBMIT ALL NONDESTRUCTIVE TESTING PROCEDURE SPECIFICATIONS FOR REVIEW BY THE CONSTRUCTION

PART 2 - EXECUTION

- GENERAL
 - A. ALL WELDING AND FABRICATION BY WELDING SHALL CONFORM TO GOVERNING WELDING CODES.
- 2. NONDESTRUCTIVE WELD TESTING REQUIREMENTS
 - A. ALL WELDS
 - 1. PERFORM NONDESTRUCTIVE TESTING OF WELDS AS
 - a 10 PERCENT OF THE BUTT JOINT WELDS SHALL BE 1. 10 PERCENT OF THE BUTT JOINI WELDS SHALL BE RANDOMLY RADIOGRAPHICALLY TESTED AND REPAIRED IN ACCORDANCE WITH THE REFERENCED WELDING CODES. SELECTION OF THE WELDS TO BE TESTED SHALL BE AS AGREED UPON BETWEEN THE CONSTRUCTION MANAGER AND THE CONTRACTOR.
 - b. GROOVE WELDS SHALL BE 100 PERCENT ULTRASONICALLY TESTED AND REPAIRED IN ACCORDANCE WITH THE REFERENCED WELDING CODES. SELECTION OF THE WELDS TO BE TESTED SHALL BE AS AGREED UPON BETWEEN THE CONSTRUCTION MANAGER AND THE CONTRACTOR.
 - c. FILLET WELDS, SHALL BE 10 PERCENT RANDOMLY EXAMINED USING EITHER DYE PENETRANT OR MAGNETIC PARTICLE INSPECTION METHODS.
 - d. ALL WELDS SHALL BE VISUALLY INSPECTED IN ACCORDANCE WITH ANSI/AWS D1.1-92, PARAGRAPH
 - 2. UNLESS OTHERWISE SPECIFIED, ALL NONDESTRUCTIVE TESTING SHALL BE PERFORMED IN ACCORDANCE WITH CHAPTER 6 OF ANSI/AWS D1.1—92 AND THE FOLLOWING. THE STANDARDS FOR RADIOGRAPHIC ACCEPTANCE SHALL BE IN ACCORDANCE WITH ANSI/AWS D1.1, PARAGRAPH 8.15.3. THE STANDARDS FOR ULTRASONIC ACCEPTANCE SHALL BE CLASS B INDICATIONS IN ACCORDANCE WITH ANSI/AWS D1.1, PARAGRAPH 8.15.4 THE STANDARDS OF ACCEPTANCE SHALL BE CLASS B. SIDICATIONS IN ACCORDANCE WITH ANSI/AWS D1.1, PARAGRAPH 8.15.4 THE STANDARDS OF ACCEPTANCE FOR BOTH DYE PENETRANT AND MAGNETIC PARTICLE INSPECTION METHODS SHALL BE IN ACCORDANCE WITH ANSI/AWS D1.1-92, VISUAL INSPECTION, PARAGRAPH 8.15.5.
 - 3. WELD DEFECTS REPAIR
 - A. REJECTED WELDS SHALL BE REPAIRED AND RETESTED UNTIL SOUND WELD METAL HAS BEEN DEPOSITED IN ACCORDANCE WITH APPROPRIATE WELDING CODES. THE CONTRACTOR SHALL BEAR ALL COSTS FOR WELD REPAIR AND SUBSEQUENT RETESTING

TELCO SERVICE

- APPLICATION FOR TELEPHONE SERVICE WILL BE MADE BY THE SDM.
 THE CONTRACTOR IS RESPONSIBLE FOR PROVIDING ALL MATERIALS
 AND ASSOCIATED LABOR FOR CONNECTION FROM THE TELCO SOURCE TO
 THE SHELTER AS PER THE CONSTRUCTION PLANS.
- PROVIDE A 2 INCH DIAMETER SCHEDULE 40 PVC PIPE FROM THE EQUIPMENT SPACE TELCO ENTRY TO A LOCATION INDICATED ON THE CONSTRUCTION PLANS. PLUG OR CAP EACH END OF THE PIPE AND PROVIDE TWO SEPARATE PULL STRINGS, SECURELY FASTENED AT EACH END OF THE PIPE. PULL STRINGS SHALL BE 200 LB TEST
- PROVIDE TWO (2) POTS LINES, LOCATION AS DIRECTED BY NEXTEL SDM WILL INDICATE TELEPHONE SERVICES AND COORDINATE INSTALLATION OR TWO (2) POTS LINES TO TELCO BOARD.

SPECIAL CONSTRUCTIONS

SECTION INCLUDES

A. CABLE LADDER AND ACCESSORIES REQUIRED TO COMPLETE

A. CONTRACTOR SHALL PROVIDE A PRICE FOR ADDITIONAL CABLE LADDER ON A "PER LINEAR FOOT" BASIS IN THIS DID PROPOSAL.

SYSTEM DESCRIPTION

A. ALL CABLE LADDERS AND PORTIONS OF THEIR ASSEMBLIES SHALL BE CONSTRUCTED OF ROLL FORMED STEEL TO SUPPORT A CONCENTRATED LOAD OF 200 LBS WITH NO PERMANENT

A. CONTRACTOR SHALL SUBMIT SHOP DRAWINGS FOR EACH COMPONENT OF THE ASSEMBLY TO THE NEXTEL PROJECT MANAGER FOR APPROVAL PRIOR TO CONSTRUCTION OF CABLE LADDER ASSEMBLY.

5. DELIVERY, STORAGE AND HANDLING

A. TRANSPORT, HANDLE AND STORE ON—SITE ALL MATERIALS USED IN CONSTRUCTING CABLE LADDER ASSEMBLY IN SUCH A MANNER AS TO PROTECT THE MATERIAL AND THE ORIGINAL FINISHED FROM DAMAGE. NO DAMAGED MATERIAL WILL BE ACCEPTED.

- A. SUBJECT TO COMPLIANCE WITH REQUIREMENTS PROVIDE PRODUCTS BY ONE OF THE FOLLOWING MANUFACTURERS

 - CENTRAL STEEL FABRICATORS, INC. (708) 236-8725
 NEWION INSTRUMENTS (919) 575-6426
 SAUNDERS DROS. (310) 945-1038
 OWNER APPROVED FQUAL

A CABLE LADDERS; (SPECIFIED BY NEXTEL) INSTALL 12' WIDE CABLE LADDERS AS INDICATED ON THE TOWER DRAWNINGS.

1. CONSTRUCTION: TUBLICAR SIDE BAR 1-1/2" HIGH X 3/8" WIDE WITH CHANNEL TYPE RUNGS - 9" O.C.

2. FINISH: TELEPHONE COUPMENT GRAY.

B. THREADED ROD:

1. CONSTRUCTION: 5/8"- 11 STEEL THREADED RODS LENGTH
TO FIT APPLICATION.

2. FINISH: ZINC PLATED.

C. WALL INSULATORS: 1. UL 94 V-1, 1-1/2" X 3/8" THICK

D. THREADED ROD INSULATORS:
1. MOLDED POLYESTER — FIBERGLASS INSULATOR

2. COLOR: RED

E. ACCESSORIES: INSTALL ALL ACCESSORIES AND PARTS REQUIRED FOR A COMPLETE INSTALLATION. PARTS INCLUDE END SUPPORTS, EXTENSION CLAMPS, WALL CLAMPS, JUNCTION KITS, HANGER KITS, ROD CAPS, TERMINATION BARS, NUTS, LOCK WASHERS, FLAT WASHERS, FRAMING CUP. J-BOLTS, CORNER BRACKETS.

1. FINISH: ZINC PLATED

8 INSTALLATION

- VERIFY THAT BUILDING FRAMING COMPONENTS ARE READY TO RECEIVE WORK.
- B. ALL INSTALLATIONS SHALL BE PER MANUFACTURERS
- C. INSTALL THREADED ROD SUPPORT AT NO MORE THAN 5'-0" O.C. SECURELY INTO CEILING STRUCTURE.
- D. INSTALL THREADED ROD INSULATORS
- E. ALIGN THREADED ROD IN STRAIGHT ROWS.
- INSTALL CABLE TRAY USING 'C' CLAMPS AT A CONSISTENT HEIGHT AS SPECIFIED IN THE DRAWINGS.
- G. LEVEL ALL CABLE LADDER TO THE HEIGHT SPECIFIED ON THE
- H. RESEAL ANY DAMAGED FINISHES AND PAINT TO MATCH EXISTING CONDITIONS



6700 N. ANDREWS AVENUE SUITE 700 FT. LAUDERDALE, FLORIDA 33309 (954) 275-2400



Kimley-Horn and Associates, Inc. (C) 1998 KIMLEY-HORN AND ASSOCIATES, INC. 4431 EMBARCADERO DRIVE, WEST PALM BEACH, FL 33407 PHONE: (561) 845 0665

REGISTRATION NUMBERS

KIMLEY HORN & ASSOCS., INC. DAVID STEWART PE 31180 CHARLES CEER PE 31435 KIRK DROST RUSSELL MORRISON PE 51910 PE 51567



SEAL

	ISIONS	T
NO.	DATE	DESCRIPTION
	-	
	-	

APPROVALS	
PROJECT MANAGER	DATE:
NEXTEL RF:	DATE:
PROPERTY OWNER	DATE:

ANTENNA INSTALLATION AT WINSTON PARK SITE NUMBER: FL 3672A

DESIGNED BY: JBC DRAWN BY: AJD APPROVED BY: DWS DATE: JANUARY 2001


> KHA PROJECT NUMBER 044201071

> > G-3SHEET TITLE


GENERAL NOTES #3

SHEET NUMBER

5

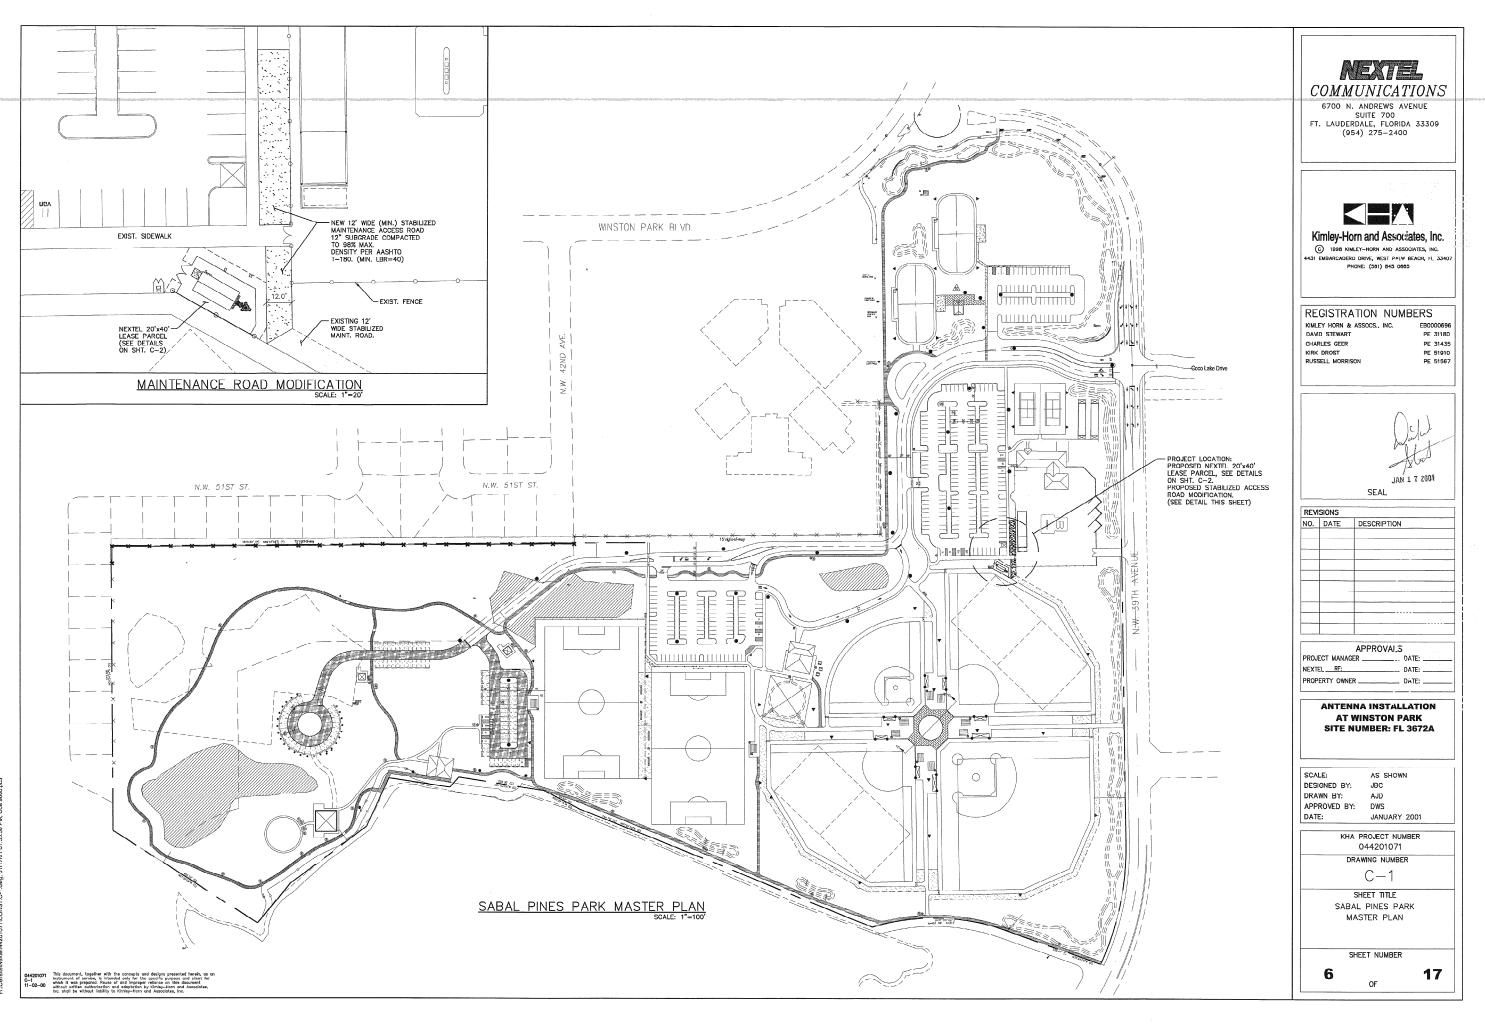

COOC AND CONTRACT AND A CONTRACT OF CONTRACT AND CONTRACT

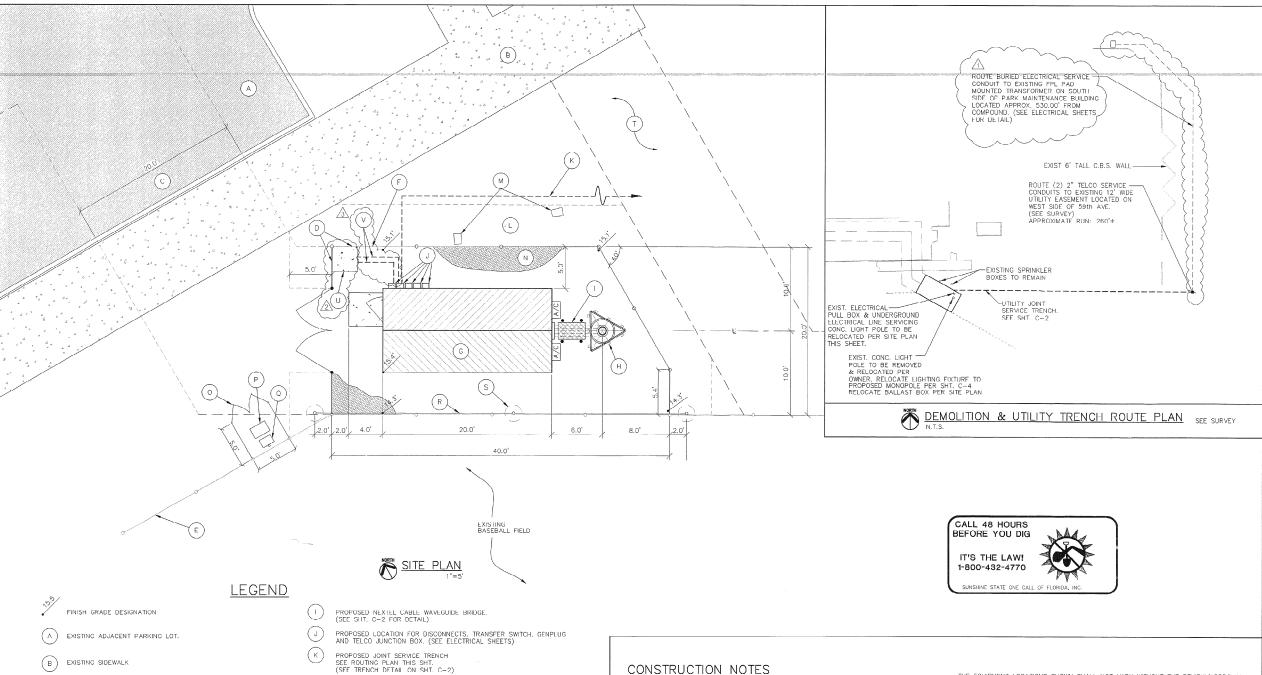

CONSTRUCTION NOTES

NEW COMMUNICATIONS ANTENNAS (TOTAL OF 9)

NEW 125' MONOPOLE (BY OTHERS) W/ NEW COMMUNICATIONS ANTENNA (BY OTHERS) NEW 10'x20' PRE-ENGINEERED EQUIPMENT SHELTER ON CONC. FOUNDATION

GENERAL NOTES

PROPOSED 5.0' WIDE LANDSCAPE BUFFER. (SEE LA-1 FOR DETAIL)

0.5' LAYER OF #57 STONE GRAVEL TO BE INSTALLED OVER SUB GRADE FILL (TYP)

PROPOSED 5'x5' FENCED IN AREA W/ LATCH & LOCKING DEVICE.

NEW LOCATION FOR BALLAST BOX FOR RELOCATED LIGHTING FIXTURE. (SEE SHT. E-1 FOR DETAIL)

SEE SHT. C-1 FOR STABILIZED MAINTENANCE ACCESS ROAD MODIFICATION.

ELECTRIC SERVICE TO/FROM TRANSFORMER

BALLPARK NETTING POST. 2'# CONC. FOOTING SHOWN DASHED (TYP. OF 3)

PROPOSED 3'x3'x4" THK. CONC. SLAB FOR NEW PAD MOUNTED TRANSFORMER. PROVIDE 6x6-W5.5xW5.5 WELDED WIRE FABRIC, AND MAKE T.O.C. SLAB 2" ABOVE FINISH GRADE.

NEW LOCATION FOR PULL BOX RELOCATED

LIGHTING FIXTURE.

(SEE SHT. E-1 FOR DETAIL)

EXISTING SPRINKLER BOXES TO REMAIN.

(M)

CONTRACTOR SHALL COMPLY WITH ALL APPLICABLE BUILDING CODE STANDARDS OF THE AUTHORITIES HAVING JURISDICTION OVER THE PROJECT AND MEET INDUSTRY STANDARDS FOR GOOD WORKMANSHIP.

NOTIFY THE PROPERTY OWNER, NEXTEL PROJECT MANAGER AND THE ARCHITECT/ENGINEER OF RECORD WELL IN ADVANCE AS TO WHEN CONSTRUCTION WILL COMMENCE.

COORDINATE THE LOCATION OF THE CONSTRUCTION STAGING AREA WITH THE PROPERTY OWNER BUILDING MANAGER AND THE ARCHITECT/ENGINEER OF RECORD WELL IN ADVANCE OF THE CONSTRUCTION START DATE.

PROTECT THE EXISTING FACILITIES AT ALL TIME: THE CONTRACTOR IS RESPONSIBLE FOR REPAIRING ANY DAMAGE CAUSED BY CONSTRUCTION OPERATIONS.

CONTRACTOR SHALL VERIFY THE EXACT LOCATION OF ALL EXISTING UTILITIES BY CALLING 1-800-439-4770 SINSHINF STATE AT LEAST 48 HOURS PRIOR TO COMMENCING WITH THE WORK.

CONTRACTOR SHALL FIELD VERIFY ALL EXISTING CONDITIONS AND PLAN DIMENSIONS AND NOTIFY THE ARCHITECT/ENGINEER OF RECORD OF ANY DESCREPANCIES.

THE CONTRACTOR SHALL REMOVE ALL TRASH AND DEBRIS FROM THE SITE ON A DAILY BASIS.

THE EQUIPMENT LOCATIONS SHOWN SHALL NOT VARY WITHOUT THE REVIEW/APPROVAL OF THE ARCHITECT/ENGINEER OF RECORD.

MAINTAIN A MINIMUM OF 3' WORKING CLEARANCE IN FRONT OF ALL ELECTRICAL

0.5' LAYER OF #57 STONE GRAVEL TO BE INSTALLED OVER SUB GRADE FILL

RESOD AND REPAIR ALL DISTURBED AREAS FROM CONSTRUCTION

NOTE: CONTRACTOR WILL PROVIDE SUFFICIENT SUBGRADE FILL MATERIAL COMPACTED TO MIN. OF 98% A ASHTO T-180 TO BRING FINISHED COMPOUND TO DESING ELEVATIONS.

THIS IS AN UNMANNED RESTRICTED SITE AND WILL BE USED FOR THE TRANSMISSION OF RADIO SIGNALS FOR THE PURPOSE OF PROVIDING PUBLIC CELLULAR SERVICE.

NEXTEL COMMUNICATIONS CERTIFIES THAT THIS FACILITY WILL BE SERVICED ONLY BY NEXTEL EMPLOYEES AND THE WORK ASSOCIATED WITH ANY EQUIPMENT CANNOT BE PERFORMED BY HANDICAPPED PERSONS, THIS FACILITY WILL BE FREQUENTED ONLY BY SERVICE PERSONNEL FOR REPAIR PURPOSES, PURSUANT TO CHAPTER #553, PART 50 OF THE FLORIDA STATUTES, THIS FACILITY IS EXEMPT FROM THE REQUIREMENTS OF THAT STATUTE, PURSUANT TO THE AMERICANS WITH DISABILITES ACT (ADA), APPENDIX B, SECTION 4.1.1.(5XB), THIS FACILITY IS EXEMPT FROM THAT ACT.

THIS FACILITY WILL CONSUME NO UNRECOVERABLE ENERGY AND IS EXEMT. FROM THE FLORIDA ENERGY REVIEW CODE.

NO POTABLE WATER SUPPLY IS TO BE PROVIDED AT THIS LOCATION.

NO WASTE WATER WILL BE GENERATED AT THIS LOCATION.

NO PARKING FACILITIES WILL BE PROVIDED WITHIN THE LEASE SITE.

COMMUNICATIONS

6700 N. ANDREWS AVENUE SUITE 700 FT. LAUDERDALE, FLORIDA 33309 (954) 275-2400



Kimley-Horn and Associates, Inc.

© 1998 KIMLEY-HORN AND ASSOCIATES, INC. 4431 EMBARCADERO DRIVE, WEST PALM BEACH, FL 3340 PHONE: (561) 845 0665

REGISTRATION NUMBERS

KIMLEY HORN & ASSOCS., INC. EB0000696 DAVID STEWART PE 31180 CHARLES GEER PF 31435 PE 51910 RUSSELL MORRISON PE 51567



FEB 2 6 2001

SEAL

1 2-26-01 ELEC, SOURCE REV 2-26-01 NFW TRANS CONC 3 2 26 01 SERVICE TO/FROM TRANSFORMER	. PAD
3 2 26 01 SERVICE TO/FROM	
TRANSFORMER	NEW

APPROVALS	;	
PROJECT MANAGER	DATE:	
NEXTEL RF:	DATE	
PROPERTY OWNER	DATE:	

ANTENNA INSTALLATION AT WINSTON PARK SITE NUMBER: FL 3672A

DESIGNED BY: DRAWN BY: AJD APPROVED BY: RCM DATE: FEBRUARY 2001

> KHA PROJECT NUMBER 044201071

DRAWING NUMBER

C-2

SHEET TITLE

NEXTEL SITE PLAN

SHEET NUMBER

7

17

0442010/1 C-2 instrument of service, is intended only for the specific purpose and of which it were prepared. Reuse of and improper reliance on this decount without written authorization and adoptation by Kimley-Horn, and Assigned the little and the control of the control of

C PROPOSED 20' WIDE ACCESS EASEMENT THRU ADJACENT PARKING LOT TO NW 39TH AVENUE. (SEE SURVEY)


LIMITS OF NEXTEL 20'x40' LEASE PARCEL. SEE SURVEY FOR LOCATION.

E EXISTING 8.0' TALL CHAIN LINK FENCE TO REMAIN.


PROPOSED 8.0' TALL CHAIN LINK FENCE & SERVICE GATE (SHOWN BOLD). TIE INTO EXISTING FENCE ON SOUTH SIDE OF PARCEI MATCH FXISTING. (SFE DETAIL ON SHT. C-3)

PROPOSED 10'x20' NEXTEL EQUIPMENT SHELTER BY ANDREW CORPORATION. MODEL: RCS 1020-355TIE. SHELTER EXTERIOR FINISH TO MATCH EXISTING PARK BUILDINGS. (SFF SHT. S-1 FOR FOR CONC. FOUNDATION)


H PROPOSED 125' TALL MULTI-CARRIER MONOPOLE BY OTHERS. (SEE MONOPOLE ELEVATION ON SHT. C-4)

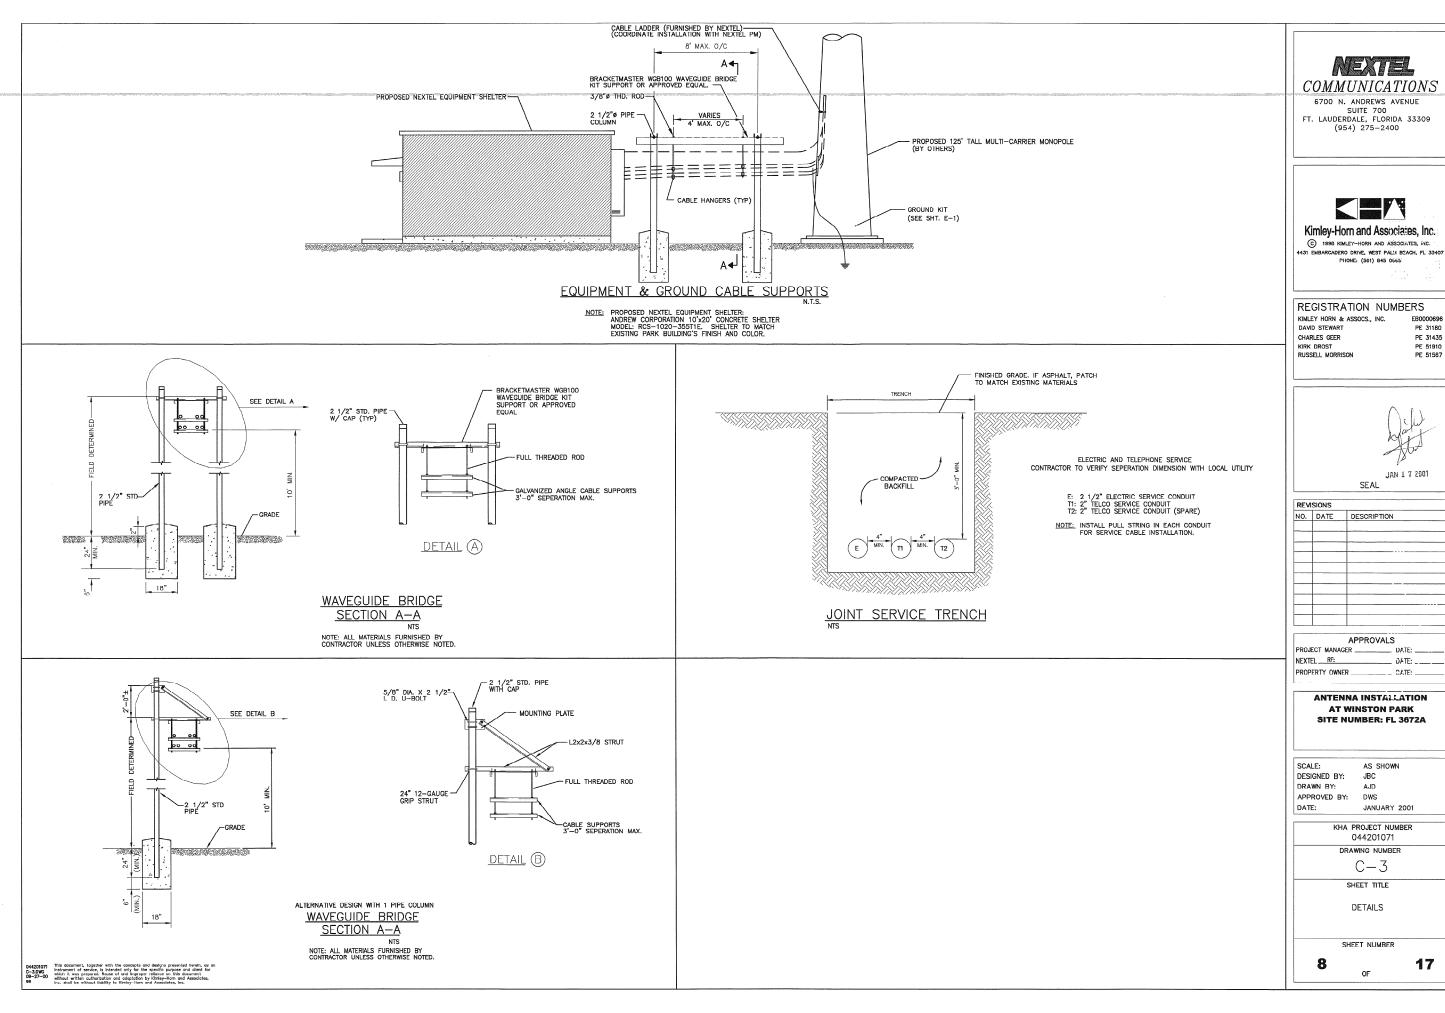

(Cellsite\Nextel\44201071\CONST\C-3.dwg, 01/17/01 01:38:27 PM, Oce 9600.pc3

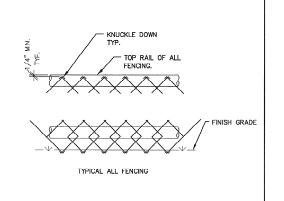

KNUCKLED DOWN DETAIL

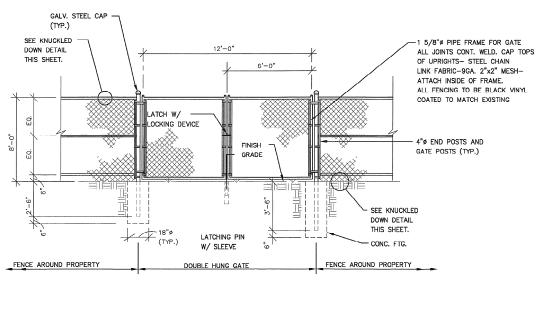

12' GATE ELEVATION

FENCING NOTES:

- ALL CHAIN LINK FENCE WALLS TO BE STRUNG THROUGH STRETCHER BARS AND ATTACHED TO END POST WITH CLIP.
- 2. ALL CHAIN LINK FENCE ALONG PIPE FRAME TO BE WIRE TIED. BI ACK VINYL COATED TO MATCH EXISTING FENCE.
- 3. ALL WELD POINTS SHALL BE CLEANED AND PAINTED WITH POWDERED ZINC PRIMER.
- 4. ALL STEEL PIPE TO BE A.S.A. SCH. 40. BLACK VINYL COATED TO MATCH EXISTING FENCE.
- 5. GATE SHALL HAVE HEAVY DUTY HINGES AND LOCKING DEVICE.
- 6. SPLICES SHOULD ONLY OCCUR AT CROSSRAILS.
- CAP TOPS OF UPRIGHTS SHALL EITHER HAVE A CONTINUOUS WELD OR HAVE "SET SCREWS" SO THEY CAN NOT BE REMOVED.
- 8. USE ONLY A HEAVY DUTY LATCH ON GATE.
- CONCRETE FOR FOOTINGS TO HAVE A MINIMUM 28 DAY COMPRESSIVE STRENGTH OF 3000 PSI.
- 10. FENCING TO HAVE TOP, BOTTOM AND MIDDLE RAILS.



6700 N. ANDREWS AVENUE SUITE 700 FT. LAUDERDALE, FLORIDA 33309 (954) 275–2400



Kimley-Horn and Associates, inc.

© 1998 KIMLEY-HORN AND ASSOCIATES, INC. 4431 EMBARCADERO DRIVE, WEST PALM BEACH, F. 33407

REGISTRATION NUMBERS

KIMLEY HORN & ASSOCS., INC. EB0000696 DAVID STEWART PE 31180 CHARLES GEER KIRK DROST RUSSELL MORRISON PE 31435 PE 51910 PE 51567



DESCRIPTION

APPROVALS		
PROJECT MANAGER	DATE:	
NEXTEL RF:	DATE:	
PROPERTY OWNER	DATE:	

ANTENNA INSTALLATION AT WINSTON PARK SITE NUMBER: FL 3672A

SCALE: AS SHOWN DESIGNED BY: JBC DRAWN BY: APPROVED BY: DWS DATE: JANUARY 2001


KHA PROJECT NUMBER	
044201071	
DRAWING NUMBER	
C-4	
SHEET TITLE	
SERVICE GATE	
AND FENCE DETAILS	

9

17

TYPICAL FENCE -POST EXTEND WEED BARRIER & STONE 12" BEYOND FENCE ON ALL SIDES. SLOPE EDGES OF PROPOSED GRAVEL TO MEET EXISTING GRADE. 12" SEE SITE PLAN FOR FINISH GRADE ELEVATION MIRAFI 60MIL WEED CLOTH SUB GRADE SEE SITE PLAN NO. 57 CRUSHED ROCK

FENCE POST DETAIL

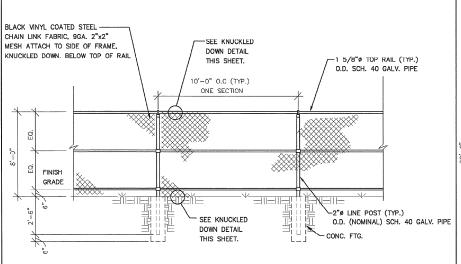


FENCE ELEVATION

TYPICAL BASEBALL NETTING
#K36 TREATED — 1 3/4" MESH (OR EQUAL)
THE NETHOUSE (COCOA, FL) (321) 631-6668
NETTING ATTACHMENT HARDWARE PER
MANUFACTURER'S SPECIFICATION -1/4"Ø STAINLESS STEEL AIRCRAFT CABLE @ TOP POSTS AND ALONG VERTICAL POSTS (TYP.) = -4"ø POST BLACK VINYL COATED (TYP.) SUB-GRADE -2'-0"ø x6'-6" CONC. FOOTING (TYP.)


BALL PARK NETTING (NORTH ELEVATION)

NOTE: ATTACH BOTTOM OF NETTING TO EXISTING FENCE TOP RAIL.

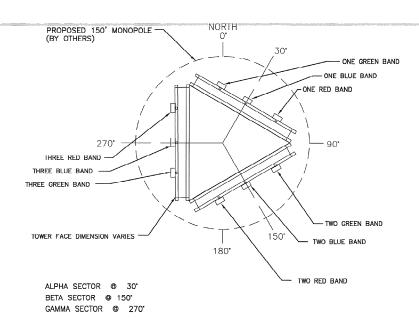


ANTENNA ORIENTATION DIAGRAM

(ORIENTATION DETERMINED BY NEXTEL RF ENGINEERS)

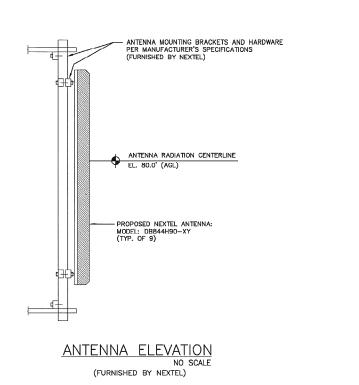

CABLE RUN TABLE				
 ANTENNA	CABLE DIAMETER	LENGTH	Commence of the Commence of th	
A1	7/8"	100'±	ANDREW CORP.	
A2	7/8"	100'±	ANDREW CORP.	
A3	7/8"	100'±	ANDREW CORP.	
B1	7/8"	100'±	ANDREW CORP.	
B2	7/8"	100°±	ANDREW CORP.	
B3	7/8"	100'±	ANDREW CORP.	
G1	7/8"	100'±	ANDREW CORP.	
G2	7/8"	100'±	ANDREW CORP.	
G3	7/8"	100'±	ANDREW CORP.	

CABLE RUN LENGTH TO BE VERIFIED BY CONTRACTOR PER NEXTEL RF ENGINEERING REQUIREMENTS.

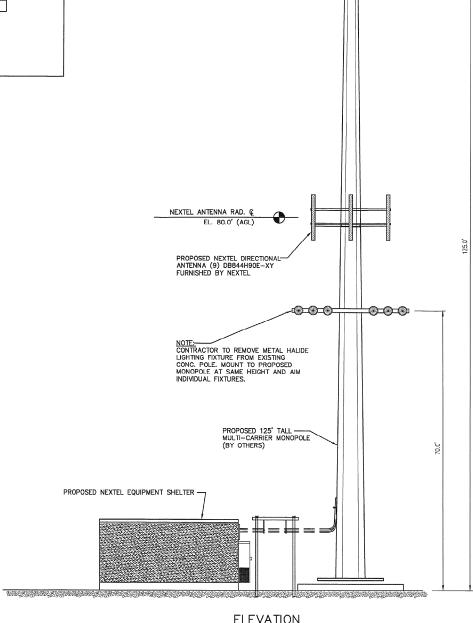

ELEVATION

- TOWER AND ALL PROPOSED EQUIPMENT MOUNTED ON TOWER BASED ON STRUCTURAL ANALYSIS BY OTHERS.
- 3. ANTENNA HEIGHTS SHOWN ARE BASED ON INFORMATION PROVIDED BY NEXTEL RF PERSONNEL.



6700 N. ANDREWS AVENUE SUITE 700 FT. LAUDERDALE, FLORIDA 33309 (954) 275-2400



Kimley-Horn and Associates, Inc.

© 1998 KIMLEY-HORN AND ASSOCIATES, INC. 4431 EMBARCADERO DRIVE, WEST PALM DEACH, FL 33407 PHONE: (561) 845 0665

REGISTRATION NUMBERS

DAVID STEWART PE 31180 CHARLES GEER PE 31435 KIRK DROST RUSSELL MORRISON PE 51910 PE 51567



REV	SIONS	
NO.	DATE	DESCRIPTION

APPROVALS	3
PROJECT MANAGER	DATE:
NEXTEL RF:	DATE:
PROPERTY OWNER	DATE:

ANTENNA INSTALLATION AT WINSTON PARK SITE NUMBER: FL 3672A

DESIGNED BY: JBC DRAWN BY: APPROVED BY: DWS DATE: JANUARY 2001

> KHA PROJECT NUMBER 044201071 DRAWING NUMBER


> > C-5

SHEET TITLE

MONOPOLE ELEVATION

SHEET NUMBER

10

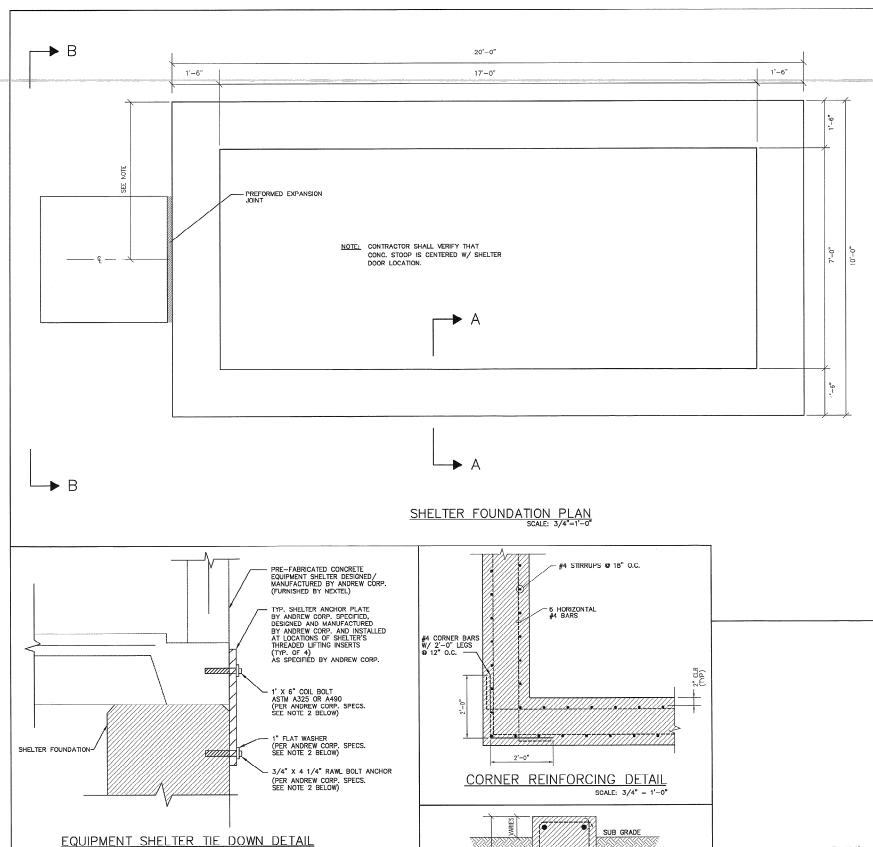

4 STIRRUPS @ 18" O.C.

6 HORIZONTAL

#4 BARS

1'-6"

SECTION A-A

GENERAL STRUCTURAL NOTES:

1999 SOUTH FLORIDA BUILDING CODE: BROWARD COUNTY EDITION FOUNDATION-DESIGN-IS-BASED-ON-A-RATIONAL-ANALYSIS-ASSUMING A MINIMUM SOIL BEARING CAPACITY OF 1500 PSF.

2. STRUCTURAL STEEL:

ALEXIAL:

CONFORM TO ASTM A36 GRADE. STD PIPE AND TUBING SHALL

CONFORM TO ASTM A501. ALL STD. PIPE SHALL BE SCHEDULE 40 UNIFSS OTHERWISE NOTED.

CONNECTIONS:
DESIGN, FABRICATION, AND CONSTRUCTION SHALL CONFORM TO AISC MANUAL OF STELL CONSTRUCTION.


PIELDING:

SHALL BE DONE BY AN AWS CERTIFIED WELDER AND IN COMPLIANCE
WITH AWS D1.1. ALL WELD SIZES SHALL BE THE MAXIMUM ALLOWED
BY THE MATERIAL BEING WELDED WITH E70XX ELECTRODES.

BOLTS: A325-X WITH WASHER, SIZE AS SHOWN ON DRAWINGS.

ANCHOR BOLTS: SHALL CONFORM TO ASTM A307, UNLESS NOTED OTHERWISE

- 3. HOT DIP GALVANIZE ALL STRUCTURAL STEEL. TOUCH UP ALL FIELD WELDS AND ABRADED AREAS WITH TWO COATS OF GALVANIZED PAINT. REPAIR OF ABRADED OR UNCOATED AREAS STALL CONFORM TO ASTM A780-93A.
- 4. CONTRACTOR/STEEL FABRICATOR SHALL LOCATE ANY REINFORCEMENT IN THE STRUCTURAL MEMBERS TO VERIEV THAT THEY WILL NOT CONFLICT WITH THE REINFORCEMENT WHEN INSTALLING ANCHORS. THE ANCHORS SHALL BE INSTALLED PER THE MANUFACTURERS INSTRUCTION.
- 5. CONTRACTOR/STEEL FABRICATOR SHALL CONFORM TO THE MINIMUM EDGE DISTANCE REQUIREMENTS IN ACCORDANCE WITH THE AISC MANUAL OF STEEL CONSTRUCTION.
- 6. ALL STRUCTURAL STEEL SHALL BE FABRICATED TO FIT BOLTED CONNECTIONS WITHIN 1/16 INCH TOLERANCE. STRUCTURAL STEEL SHALL NOT BE FLAME CUT UNDER ANY CIRCUMSTANCES WITHOUT APPROVAL OF THE SHALL NOT BE
- 7. CONTRACTOR/STEEL FABRICATOR SHALL CAP OR SEAL ALL PIPES AS REQUIRED TO PREVENT RAINWATER INTRUSION.
- CONTRACTOR/STEEL FABRICATOR SHALL SUBMIT SHOP DRAWINGS FOR REVIEW PRIOR TO ANY SIELL FABRICATION. AT THE CONTRACTOR'S OPTION, FIELD SPLICES MAY BE USED FOR ERECTION PURPOSES. IF FIELD SPLICES.
 THE PROPOSED FIELD SPLICES.
- 9. AT THE CONTRACTOR'S OPTION, SHOP WELDS MAY BE USED INSTEAD OF FIELD WELDS.
- 10. SUBMIT ORIGINAL SHOP DRAWINGS, INCLUDING COMPLETE DETAILS, SCHEDULES OF FABRICATION AND ASSEMBLY, PROCEDURES, AND DIAGRAMS. INCLUDE DETAILS OF CUTS, CONNECTIONS, CAMBER, HOLE, AND OTHER PERTINENT DATA. INDICATE WELDS BY STANDARD AWS A2.1 AND A2.4 SYMBOLS, AND SHOW SIZE, LENGTH, AND TYPE OF WELD, PROVIDE SETTING DRAWINGS, TEMPLATES, AND DIRECTIONS FOR INSTALLATION OF ANCHOR BOLTS AND OTHER ANCHORAGES TO BE INSTALLED AS WORK OF OTHERS' SECTIONS.
- 11. ALL CONCRETE SHALL HAVE A MINIMUM COMPRESSIVE STRENGTH OF 4000 PSI AT 28 DAYS.
- 12. REINFORCING STEEL: ASTM A615, 60 KSI YIELD GRADE, DEFORMED BILLET BARS, UNPROTECTED FINISH.
- 13. PROVIDE 3/4" CHAMFER ON ALL EXPOSED EDGES OF CONCRETE.
- 14. MINIMUM CONCRETE COVER FOR REINFORCEMENT SHALL BE 2" UNLESS NOTED OTHERWISE. CONCRETE CAST AGAINST AND PERMANENTLY EXPOSED TO EARTH SHALL HAVE A MINIMUM CONCRETE COVER OF 3".
- 15. CONTRACTOR SHALL COORDINATE ALL PENETRATIONS, CONDUIT, CHAMFERS, AND EMBEDDED ITEMS PRIOR TO CONCRETE PLACEMENT AND/OR STEEL ERECTION. CONTRACTOR SHALL VERIFY ALL SIZES AND LOCATIONS.
- 16. DO <u>NOT</u> IMPOSE SERVICE LOAD (i.e. FLOOR DEAD AND LIVE LOADS, BACKFILL, ETC.) UNTIL THE CONCRETE HAS REACHED ITS SPECIFIED MINIMUM COMPRESSIVE STRENGTH.
- 17. CLASS "B" BACKFILL: SHALL BE CLEAN SAND FILL APPROVED FOR USE BY THE ENGINEER. NO UNAPPROVED MATERIAL WILL BE ALLOWED. CLEAN SAND FILL SHALL BE FREE OF ALL MARL, ROOTS, BOULDERS OR OTHER DELETERIOUS MATERIAL.
- 18. CONTRACTOR SHALL VERIFY THE ABSENCE OF ALL MARL, ROOTS, BOULDERS OR OTHER DELETERIOUS MATERIAL TO A DEPTH BELOW THE FOOTING EQUAL TO TWICE THE FOOTING WIDTH. ANY DELETERIOUS MATERIALS ENCOUNTERED SHALL BE REMOVED AND BACKFILLED WITH CLEAN SAND. THE ENTIRE BUILDING AREA SHALL BE COMPACTED TO 95% AASHTO T-99 TO A DEPTH OF 18 INCHES.
- 19. CONTRACTOR SHALL RESTORE ALL DISTURBED AREA TO EQUAL OR BETTER CONDITION

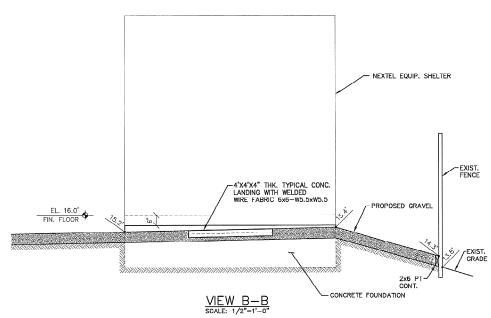



6700 N. ANDREWS AVENUE SHITE 700 FT. LAUDERDALE, FLORIDA 33309 (954) 275-2400



Kimley-Horn and Associates, Inc.

(C) 1998 KIMLEY-HORN AND ASSOCIATES, INC. RCADERO DRIVE, WEST PALM SEACH, FL 33407 PHONE: (561) 845 0065

REGISTRATION NUMBERS

DAVID STEWART PE 31180 CHARLES GEER PE 31435 PE 51910 KIRK DROST RUSSELL MORRISON PE 51567



-	NO	DATE	DECODIDETON
1	NO.	DATE	DESCRIPTION
1			
			, 11
1			
1			`
.			
1			
			1 2 2 2 2 2 2 2 2 2 2 2 2 2 2 2 2 2 2 2
1			1

APPROVALS:			
PROJECT MANAGER	DATE:		
NEXTELRF:	DATE:		
PROPERTY OWNER	DATE:		

ANTENNA INSTALLATION AT WINSTON PARK SITE NUMBER: FL 3672A

SCALE: AS SHOWN DESIGNED BY: JBC DRAWN BY: AJD APPROVED BY: DWS DATE: JANUARY 2001

KHA PROJECT NUMBER	
044201071	
DRAWING NUMBER	
S-1	
SHEET TITLE	
SHELTER FOUNDATION	
SHEET NUMBER	
11	17

OF


044201071
C-5 within the concepts and designs presented herein, or instrument of service, is intended only for the specific purpose and client which it was prepared. Reuse of and improper reliance on this document without written authorization and adoptation by Kimley-Horn and Associates, inc. shall be without liability to Kimley-Horn and Associates inc. shall be without liability to Kimley-Horn and Associates inc.

1. SHELTER SHOWN FOR DIAGRAMATIC PURPOSES ONLY.

2. SHELTER TIE DOWN PLATE AND HARDWARE SHOWN FOR REFERENCE PURPOSE ONLY. PLATE/HARDWARE SIZING, TYPE AND PLACEMENT LOCATIONS ARE BY THE MANUFACTURER (ANDREW CORP.) PER "IIE DOWN DETAILS RCS SHELTER SYSTEM" DATED 4/18/97. CONTRACTOR WILL VERIFY MOST CURRENT ATTACHMENT REQUIREMENTS WITH MANUFACTURER.

3. SIGNED/SEALED DESIGN DRAWNGS OF SHELTER TIE DOWN BY ANDREW CORP. TO BE SUBMITTED IN CONJUNCTION WITH SHOWN PLAN SHEET FOR REVIEW PERMITTING.

NOTES:

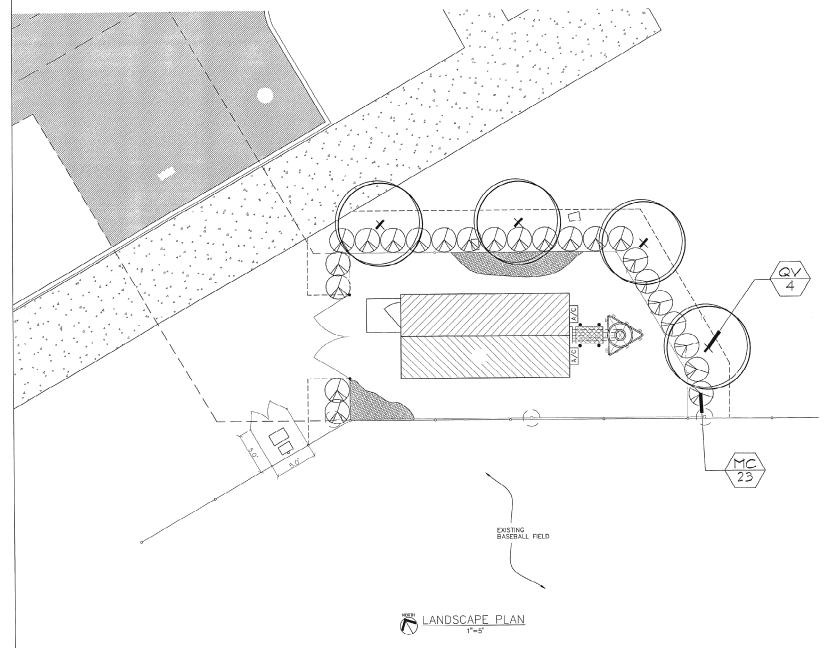



SUITE 700 FT. LAUDERDALE, FLORIDA 33309 (954) 275–2400



Kimley-Horn and Associates, Inc.

(C) 1998 KIMLEY-HORN AND ASSOCIATES, INC. 4431 EMBARCADERO DRIVE, WEST PALM BEACH, FL 33407 PHONE: (561) 845 0665

REGISTRATION NUMBERS

KIMLEY HORN & ASSOCS., INC. DAVID STEWART PE 31180 PE 31435 CHARLES GEER KIRK DROST RUSSELL MORRISON PE 51910 PE 51567



REVISIONS	1	
NO. DAT	E DESCRIPTION	

APPROVALS			
PROJECT MANAGER DATE:			
NEXTEL RF: DATE:			
PROPERTY OWNER DATE:			

ANTENNA INSTALLATION AT WINSTON PARK SITE NUMBER: FL 3672A

SCALE: DESIGNED BY: MDB DRAWN BY: MDB APPROVED BY: SEL JANUARY 2001

> KHA PROJECT NUMBER 044201071 DRAWING NUMBER

> > LA-1

SHEET TITLE

LANDSCAPE PLAN

SHEET NUMBER

17

PLANT MATERIAL

SYM. QTY. BOTANICAL NAME COMMON NAME SIZE/REMARKS

Quercus virginiana

45 gal. min., 12' height, 2.5" cal. min, 4' clear wood

SHRUBS AND GROUNDCOVERS

MC 23 Myrica cerifera

Wax Myrtle

Live Oak

3Gal., 30'x30', 30' O.C.

MISCELLANEOUS

Eucalyptus/Floramulch 3" layer

Mulch

As Needed Stenotaphrum secundatum

Floratam

Certified Sod, 100% insect/disease free, laid tight, rolled

CITY OF COCONUT CREEK LAND DEVELOPMENT CODES

ZONING DISTRICTS: RECREATIONAL

REQUIRED PROPOSED

100%

2.5

40% minimum native landscape requirement

A. A hedge landscape barrier of at least 2 feet height

PLANT LIST QUANTITIES ARE PROVIDED FOR CONVENIENCE. IN THE EVENT OF QUANTITY DISCREPANCIES, THE DRAWING SHALL TAKE PRECEDENCE. IT IS THE CONTRACTOR'S RESPONSIBILITY TO VERIFY PLANT MATERIAL QUANTITIES, INCLUDING SOD AND MULCH.

CONTRACTOR SHALL INSURE THAT ADEQUATE WATER IS SUPPLIED IN NECESSARY QUANTITIES TO ALL EXISTING AND NEWLY INSTALLED PLANTINGS.

ALL LANDSCAPING SHALL BE INSTALLED ACCORDING TO SOUND NURSERY PRACTICES AND SHALL BE FLORIDA NO. 1 OR BETTER AS GIVEN IN "GRADES AND STANDARDS FOR NURSERY PLANTS, FLORIDA DEPARTMENT OF AGRICULTURE AND CONSUMER SERVICES.

COMPLETELY REMOVE ALL SYNTHETIC NON-BIODEGRADABLE ROOTBALL WRAPPING MATERIAL PRIOR TO INSTALLATION.

NO SUBSTITUTIONS SHALL BE MADE WITHOUT WRITTEN AUTHORIZATION FROM THE OUNER OR LA. ALL PLANTING SHALL INCLUDE 3" LAYER OF FLORAMULCH.

NO SUBSTITUTIONS SHALL BE MADE WITHOUT WRITTEN AUTHORIZATION FROM THE LA OR CUNER. ALL LANDSCAPE AREAS SHALL BE FULLY IRRIGATED WITH AN AUTOMATIC IRRIGATION SYSTEM.

General Landscape Specifications and Notes

All existing buildings, walks, walks, powns, pipms, and other stems of construction and planting already completed on established shall be protected from damage by this Contractor unless otherwise

C. Protection of Existing Plant Materials Outside Limit of Work

The Controctor shall be repossible for all annuals rounder cutting or danage to trees and sinds enerting or colorvois, coused by carriess operation of exposent, steelphing of saternals, see. The shall stake conjection by driving or partial peak the drivine or the spifing of a geodies, or other discension supervised with the drivine. The shared shall be bread where the level of the control of the drivine of the state of the control of the Control of the Hardred Delons (\$100) per colors not on excellents code which dots on additional towns (\$20) per composer for other state of an one declarate code which dots on additional towns (\$20) per composer for other state of the control of the state of the control of the

D. Materials

Samples of materials as listed below shall be submetted for approval, on the site or as otherwise determined by the Owner. Upon approval of samples, delivery of materials may begin.

MATERIALS SAMPLES
Mulch one (I) cubic foot
Topsol one (I) cubic yard
Plants one (I) of each variety

2. Post. Neutrals on Post species and the American on the drouge. Moveochure shall conform to STANANGOZEP FLANT NATES, FAYE Schim. All arrany stack shall be in coordinar with COADES AND STANANDOSE FOR NEISSEY FLANTS FOR THE OIL, letter them published by the First Department of Agrantium and Consume Services. All placts shall be Farths Oroks No. 1 or better of determed by the First Donas of Posts believe. All placts shall be Farths Oroks No. 1 or better of determed by the First Donas of Posts believe. All placts shall be foreign cannot be the process of the consumers of the Consumer of the Consume

b. Heaversents: The height and/or with of trees shall be necessaril from the ground or across the normal speed of branches with the plants in their normal postons. The necessariest said not include the necessaries reported in the Plant Let may be used if approach given. Plants there in see than those specief in the Plant Let may be used if approach by the Owner. If the use of larger plants is approved, the bad of certain or speed of roots shall be increased in proportion to the sear of the plant.

c. Inspection: Plants shall be subject to expection and approval on the place of growth, or upon delivery to the star, or determined by the Ower, for quality, see, and worser, such approval shall not specified by the place of procession and rejection of the seat during process of the work or offer conjection for see and condamn of both or roots, black defects or nature. Rejected plants shall be reasonal manifoldary from the star. Hotter requesting respective shall be submitted in writing by the Contractor at least one (1) work prior to excepted date.

E. Topsel and Sand

Toposi for use in preparing sol for backfilling plant, pas shall be tierty procest. (30%) mask and sevency present. (70%) soul and be fertule, fruite, and of a bong clancuse, valuous mature of subsol materials and abouted from a vell-fraced crafter see. It shall contain three (3) to fire (5) percent decoupted organ settler and shall be free from heavy clay, coarse sand, stones, line, lapse, plants, rotos or other forespectures, or according to the solid to plant such parts and stones are such stones; such stones in the shall be founded to plant specific plant and the solid to plant specific plant shall be 50 to 10.0 to the solid to plant specific plants and solid to plant specific plants and solid to plant specific plants.

Sand shall be course, clean, well drawing notive sand. Contractor shall submit results of soil tests for topsoil and sand proposed for use under the Contract for approval by the Owner.

Vater necessary for plantag and mantenance shall be of satelloctory quality to section on obequete growth of plants and shall not contain harvilly, natural or non-mode delensing determined to plants. Water meeting before reactived shall be thousand on the sate from the Ower, of worlder, and the Contractor shall be responsible to make arrangements for its use by the tanks, losses, spraklers, etc. If such water to not consider out the state, the Constructor shall provide such setsofactory water from sources off the sea on a collaboration size to the Owers.

Connerval fertitiver shall be a complete formula; E shall be unform in composition, dry and free flowing. This fertitiver shall be delivered to the site in the original unopened containers, each bearing

Fifty percent (50%) of the atragem shall be derived from natural organic sources. The following fertilizers shall be used and applied at rates as suggested by manufacturer's specifications:

1. Shrubs and Trees - Miorganite, or approved equal

2. Annuals and anoundcovers - Osnocote/Serra Blend 14-14-14

In addition to surface applied ferritizers, all container grown and field grown plant maternal shall necessee "Agriform" planting tabless 24-10-5 formula, 21 grown or equal. These tabless shall be placed at a depth of root ball at the rate as specified by natural currer.

H. Mulch

I Protect roots or balls of plants of all tasts from our and dying winds, voter and firetain, or necessary and plants. Plant materials shall be obsquetely posted to permet brinding and dying out during intenses. Treat prospected airse than in (10) after or within one out planted with the (3) days of object to see shall be syroid with an anternospirous product ("Witput" or equal) to remove transportant product (witput" or equal) to remove

Bailed and burilapped plants (B&B) shall be dup with firm, natural balls of soil of sufficient, see to exceepess the libraries and feeding roots of the plants. No plants moved with a ball shall be planted if the ball is cracked or broken. Plants bailed and burilapped or container grown shall not be banded by

3. Plants marked "BR" in the Plant Let shall be duq with bare roots. The roots shall not be out within the minima spread specified in the Plant List. Care shall be exercised that the roots do not dry out in moving and prior to planting.

4. Protection of Palms (f applicable): Only a minimum of fronds shall be removed from the crown of the palm trees to facilitate moving and handling. Clear firms (CT) shall be as specified ofter the minimum of fronds have been removed. All palms shall be braced per detail.

5. Exception of tree pits shall be done using extreme care to avoid damage to surface and subsurface absents with as utilizes on hardscane elements. Factors and presoned sub- larges.

L. All container grown material shall be healthy, vigorous, well—rooted plants and established in the container in which they are sold. The plants shall have tops which are of good quality and are in a lealthy growing condition.

2. An established container grown plant shall be transplanted into a container and grown in that container sufficiently look for the new librour roots to hove developed so that the root was well retion as shape and hold together their resolved from the container. Container grown stack shall not be breided by their stees.

3. Plant roots bound in containers shall not be acceptable.

Substitution of non-container grown material for material explicitly specified to be container grown will not be permitted unless written approval is obtained from the owner and Landscape Architect.

K. Collected Stock

When the use of collected stock is permitted as indicated on the Plant Let Schedule, the amount sees of rootballs shall be equal to that specified for the next larger see of nursery grown stock of the same variety.

Plants collected from wild or notice stands shall be considered nursery grown when they have been successfully re-established in a nursery row and grown under require nursery cultural procraces for a manum of two (2) growing seasons and have octamed adequate root and top greath to indicate full necessary from transplantes; into the intravey row.

Guarties accessory to complete the work on the Drumone shall be farmeded. Quantity estimates have been made corellets, but the Landscape Archaect or Owner cassues on bothly far creasures or errors. Shadd a decrepancy access between the bidders take off and the plans but quantity, the Landscape Archaects shall be modified for clarication prior to the submession of bids.

All deventors and/or suce specified shall be the minimum acceptable suc.

I. Five grading under the Contract shall consist of final finehed grading of laws and planting areas that have been rough graded by others. Bersing as shown on the drawings shall be the responsibility of the Landscape Contractor, unless otherwise noted.

2. The Londscape Constructor shall five grade the low and planting arises to bring the rough grade up to final finished grade aloning for interiors of soil and/or which depth. The Constructor shall five grade by 1-nd and/or with all expression necessary including a grading tractor with front—and loader for transporting soil while the site.

 $3.\ All$ planting areas shall be graded and maintained to allow free flow of surface water. Areas adjacent to buildings shall slope away from the buildings.

L Chromin up before consenting work: The Contractor shall close up work and surrounding eroes of all tables or dijectionable entities. All mercur, censent, and tame surrout shall be reasoned from the surface of all fights beds. These needed shall not be sufficiently added the Contractor for such soll conductors besents the soll which will no your policy of such table factors from the substitute of the Londoccope Architect or Orient. Federa to do so before planting shall make the corrective securious the responsibility of the Contractors.

3. Subgrade Encourage: Size Contractor is responsible to remove all enseting and imported limented and limented, sub-times form all limediacipe planting ories to a resi- mus depth of 36°. Size Contractor is responsible to buddlist laters planting mosts to roudy finishing upde with allowing to firm an amount source or on apported source. It limented conductes occur in plantid areas often 36° deep excession by Size Contractor, and postere dividence on most be colleved, Louiscape Contractor shall statise planting detail that addresses poor crange.

4. Furnish nursery's certificate of couplance with all requirements as heren specified and required, hispect and select plant nationals before plants are duq at nursery or groung site.

5. Counts' Comply with applicable Frederid, State, County, and local regulations generates landscape nationals and work. Conform to accepted hericultural practices as used in the trade. Plants shall be protected upon armal at the sets by him throughly watered and properly nationated and planted. Plants shall not renon improveded for a period exceeding twenty-flow (24) hours. At all times varianched another contamery in qualifications.

7. All planting pas shall be reconstant to see and depth in accordance with the USA Standard for Nervey Stack 250LL starts show extensive on the drawing, and backfield with the proported Frusting Science Systematic Nerveshire (Science S). For all trave past with overshire Obserting Clearine S) reconstruction to condulate. No allowance will be used for lost plants due to purpose drawing. If poor drawing extress, utuler planting desired to the obsertion of conduct. Traces shall be set plant and client in position used the planting nature too been fluided as place with a slow, full lose stream. All planting shall be performed by percented feature with planting recorder and under the apparence of a qualified planting foreass. Proper "Setting of shall be construct to channess or proper security of the control of the contr

8. Take all necessary precautions to avoid danage to buildings and building structures while installing

9. Soi exture shall be as specified in Section E of these specifications. In addition, each planting pt shall receive 21-gram "Agriform" planting tablets per manufacturer's specifications or as follows:

- Two (2) toblets per 1 qd. plant
- Three (3) tublets per 3 qd. plant
- Four (4) tublets per 10 qd. plant
- Larger Material - two (2) tublets per 1/2° of trunk calper

10. Trees and shades shall be set straight and of such a level that after settlement, the plant arow will stand one (I) to two (2) trahes dove grade. Each plant shall be set in the creater of the ps. Plantag soil sacture shall be localised and thoroughly tamped around the hall and shall be settled by exter after tamping.

II. Fill hole with sol nature, adding certain oil sol to solurated. To do the, fill hole with water and olive to sola makes trenty (20) metter, string in necessary to get sol throughly wit. Pack highly with feet. Add more war sol enters. Do not cover you of boil with soil nature, only with midd. All buring, rope, wree, race, shall be removed from the sides and tops of hole, but no buring shall be placeful from sudements.

B. Sirubs and ground cover plants shall be evenly spaced a accordance with the drawings and as natured on the Plant Let. Cultivate all planting areas to a minus depth of 6°, resove and depose all debts. Till into top 4" the planting sold into as specified in Section F. Thoroughly vater all plants of the manafacture.

4. Tree aying and brown shall be installed by the Landscape Contractor in accordance with the plans to more stalling and innetion trees in an ignite posture. If the Landscape Contractor and Orme shall be suffered to wave the tree aging and browns, the Orient shall solidy the Landscape Profitator in writing of their instances of orien to hold brainless — the Landscape Profitator in the event only recept full down and disapper person or property.

15. Matching: Provide a three (3) nch annual layer of specified match over the entre area of each strub bed, around cover and was bed and time ne.

6. Heritade Weel Control: All plans holds stall be laps free of narraes weeds used final acceptance of work. If detected by the Owen, "Nourd-by" stall be applied for weel control by qualified personnel of all planting areas in pass applications periodicursely presention and applications. First to find important, troto oil planting beds with on approved pre-manifest. Incredit oil on application rate reconnected by the annaforcure.

L The work consists of lown bad preparation, sof preparation, and sodding complete, in strict accordance with the specifications and the applicable drawings to produce a grass lown acceptable to the Owner.

7. Lom Bed Preparation: All areas that are to be solded shall be chared of any rough grass, weeks, and debre, and the ground brought to an even grade. The shole surface shall be rolled with a roller verbigen active are time-exhaulted (100) most per fect of vide). Durns the rolled of depressions caused by settlement of rolling shall be filled into additional sold, and the surface shall be reproduced not related unt presenting a sound not even finish to the up to the required grade.

3. Sol Preparation Prepare losse bed four (4) notes deep. Apply fertilizer as rate of twenty (20) pounds per one thomous (1900) square feet. Application shall be usefue, suttens approved exchanced spreaders. The fertilizer thoroughly with the sol to a depth of three (3) notes. Head rate until all beaps and depressions are reasonal. West prepared area thoroughly.

The Contractor shall sed all areas that are not paved or planted as desepated on the drawings within
the contract limits, unless specifically noted otherwise.

The sod shall be certified to meet Florido State Plant Board Specifications, absolutely true to varietal type, and free from veeds, fungus, insects and disease of any kind.

Soil peach shall be last tainty tourther so on to make a soild sociated low area. Soil shall be last uniformly quests the edges of all curbs and other landstage elements, pound and planted areas. Adjacent to balakage, of a term kinds they tailed by provide how areas shall be railed with a low roller autocarpt; used for such purposes, and then thoroughly regard. It, is the opens of the Ower, trund-trusted peace and they are the soil peace and the throughly regard. It is the opens of the Ower, trund-trusted peace and the own of the throughly advantage of the soil of the works between the soil peace and to even not tomostances in the soil, clear soil on approved by the loundscape Autocatic or Ower shall be uniformly sproud over the enter surface of the soil and thoroughly submed in

5. During delivery, pror to and during the planting of the laws areas, the sod panels shall at all times be protected from excessive drying and unincossary exposure of the roots to the sun. "All sod shall be stacked so as not to be duringed by sweating or excessive heat and mosture.

a. Within the contract lines, the Contractor shall produce a dense, will established from. The Contractor shall be responsible for the report and re-solding of all entailed, sustem or have spots until Contractors of Acceptables for the Landscape Acuteurs or Comer. Reported sodding shall be accompleded so in the ormal work (include craydob of accessing).

Water every day for ten (10) successive days, then water three (3) times per veck (at even intervals) for two (2) additional weeks. All watering shall be of sufficient quantity to wet or restore water to depth of four (4) inches.

Upon completion of all planting work and buffers fivel acceptance, the Contractor shall revove all natural, expinent, and debre resulting from his work. All poved areas shall be brone cleaned and the size left in a neat and acceptable condition as approved by the Ovier's Authorized Representative.

All plants and planting included under the Couract shall be maintained by westernia, nativative, sproaps, and all other operations (such as re-stoking or reporting any supports) necessary to bear or beauthy conduction by the Couractive and Certification of Recognitable; by the Landscape Architect. Plantineases after the Certification of Recognitable; soil be in accordance with the specifications in the section. Contractors are requested to provide of destande to cover landscape and registration maintaincate for a proof of 90 calculator does connecting offer exceptance.

L Contractors are requested to provide a bid estimate for maintenance following the initial $90\text{--}\mathrm{day}$ maintenance period on a cost per month basis.

I. The life and sotofactory conduton of all 15 gallon and larger plant material naticaled by the Landscop Contractor shall be quaranteed by the Contractor for a namum of one (1) calendar year commencing at the two of Certification of Acceptability by the Landscape Architect or Owner.

The life and sateSactory condum of all other plant material (including sod) installed by the Landscape Contractor shall be guaranteed by the Contractor for a minimum of 90 calendar days, commencing at the time of Cortification of Acceptability by the Landscape Architect or Owner.

3. Replacement: Any plant nor found in a healthy growing conduces at the end of the quaranteer period draft her reasonal firms the size and replaced on soon on weather conduces permat. All replacements shall be plants of the some find and size on specified in the Plant Lats. They shall be furneshed planted and maked on specified under "Plantarity, at an additured costs to the Owner.

on names or species more 'restrat, of a discontance cost to the Owne.

A is the event the owner does not contact with the Contextor for landscape (and irregators) nontenence,
the Contractor is consumed to view the progest are periodicily during the one year so victorially proved in evaluate weathermore procedures home performed by the Owner, and shall notify
the more in vitrat of nontenence procedures for conductive which therein regards and health plant
quarks. It is suggested such ase visate shall be conducted a serious of once per north for a period of
twich (2) seadler from the date of ecosystem.


Find respection at the end of the quarantee prival shall be an planting, construction and oil other incidental work perturing to the Contract. Any replacement on the time shall be subject to the same over (1) year quarantee (or as specified by the Landscape Architect or Ower in virtual) beganing with the time of replacement and ending with the same respection and acceptance harm discorded.

GROUNDCOVER TO FACE FRONT OF PLANTING BED.

REFER TO PLANT-SCHEDULE FOR SPACING

MAINTAIN 12" DEAD ZONE

PLAN VIEW

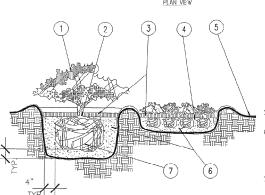

NOTES: I. TOP OF SHRUB
ROOTBALLS TO BE
PLANTED I' — 2" HCH
WITH SOIL MOUNDING UP
TO THE TOP OF
ROOTBALL.

A UNIFORM MASS/HEIGHT


COMPACTED OR AS SPECIFIED

FOR GRAIDCOVER BED 5. FINISHED GRADE (SEE GRADING

6. PREPARED PLANTING SOIL AS COVERS AND SHRUBS USED IN MASSES ENTIRE BED 10 BE AMENDED WITH PLANTING SOIL MIX AS SPECIFIED.

7. SCARIFY ROOTBALL SIDES

Shrub/Groundcover Planting Detail

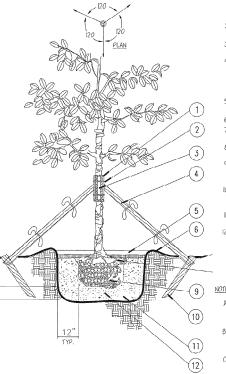

arge Tree Planting Detail

I. 5 LAYERS OF BURLAP TO PROTECT TRUNK

3. FIVE 2" X 4" X 18" WOOD BATTONS

4. 3-2" X 8" LODGE POLES, NALL (DRILL AND NAIL IF NECESSARY) TO BATTONS 2" X 4" STAKES, FLAG AT

MIDPOINT AND AT BASE. 5. 3" MINIMUM OF SPECIFIED MULCH COMPACTED OR AS SPECIFIED.

6. SOIL BERM TO HOLD WATER.

7. FINISHED GRADE (SEE GRADING PLAN) 8. TOP OF ROOTBALL MIN. I' ABOVE

FINISHED GRADE

9. B&B OR CONTANERIZED
(SEE SPECIFICATIONS FOR ROOT
BALL REQUIREMENTS).

IO. 2" x 4" x 3' (MIN), P.T. WOOD STAKES BURIED 3" BELOW

II. PREPARED PLANTING SOIL AS SPECIFIED. 12. ROOTBALLS GREATER THAN 24" PIAMETER SHALL BE PLACED ON MOUND OF UNDISTURBED SOIL TO PREVENT SETTLING.

A. CONTRACTOR SHALL ASSURE PERCOLATION OF ALL PLANTING PITS PRIOR TO INSTALLATION.

B. FINAL TREE STAKING DETAILS AND PLACEMENT TO BE APPROVED BY OWNER. C "TOPE SAVED"



6700 N. ANDREWS AVENUE SUITE 700 FT. LAUDERDALE, FLORIDA 33309 (954) 275-2400



Kimley-Horn and Associates, Inc.

(C) 1998 KIMLEY-HORN AND ASSOCIATES, INC. 4431 EMBARCADERO DRIVE WEST PAIM BEACH EL 33407

REGISTRATION NUMBERS

KIMLEY HORN & ASSOCS., INC. FROODOGGE PE 31180 CHARLES GEER PE 31435 KIRK DROST PF 51910 RUSSELL MORRISON



		25000000000
NO.	DATE	DESCRIPTION

	1	
		
		-
		-

APPROVALS				
PROJECT MANAGER	DATE:			
NEXTEL RF:	DATE:			
PROPERTY OWNER	DATE:			

ANTENNA INSTALLATION AT WINSTON PARK SITE NUMBER: FL 3672A

SCALE: AS SHOWN DESIGNED BY: MAB DRAWN BY: MAB APPROVED BY: SEL DATE: JANUARY 2001

> 044201071 DRAWING NUMBER


LA-2SHEET TITLE

LANDSCAPE DETAILS

SHEET NUMBER 13

17

044201071
C-1
minute of service, is intended only for the specific purpose and client for without written outbrokzedom and odpitation by Kimley-Horn and Associates, including the company of the specific purpose and client for which it was prepared, Reuse of an dimproper relaince on this document without written authorization and adaptation by Kimley-Horn and Associates, inc. shall be eithout it.libility to Kimley-Horn and Associates, inc.

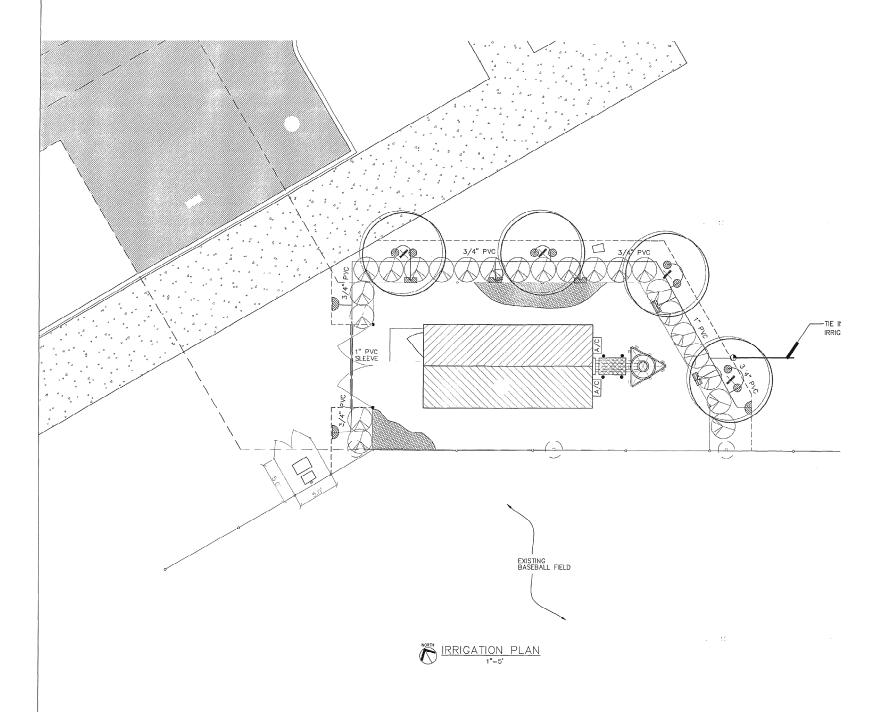

IRRIGATION SYSTEM

IRRIGATION IS TO BE COORDINATED WITH THE CITY.

IRRIGATION SHALL PROVIDE 100% COVERAGE WITH A 50 % OVERLAP.

IRRIGATION CONTRACTOR MUST EVALUATE EXISTING PARK IRRIGATION SYSTEM, AND DETERMINE IF THE NEAREST ZONE IS CAPABLE OF SUPPLYING AN ADDITIONAL 10.3 G.P.M. IF FOUND UNCAPABLE, A NEW ZONE MUST BE ADDED FROM THE EXISTING MAINLINE. WIRING AND A NEW CONTROL BOX MAY BE REQUIRE IF CURRENT SYSTEM IS INCAPABLE OF BEING UPGRADED.

SOURCE OF WATER FOR IRRIGATION SYSTEM WILL BE THE EXISTING PARK IRRIGATION SYSTEM.

INSTALLATION IS TO INCLUDE COMPLIANCE WITH APPLICABLE CODES, PRESSURE TESTING OF MAINLINE, AND HARDWIRE TO POWER SOURCE AT EQUIPMENT SHELTER. CONTRACTOR MAY USE ALTERNATE/NEARBY SOURCE IF FOUND ACCEPTABLE BY PROJECT MANAGER.

CONTRACTOR TO EVALULATE EXISTING SYSTEM AND PRODUCE IRRIGATION SHOP DRAWINGS PRIOR TO SUBMITTING FOR A BUILDING PERMIT.

THE CONTRACTOR SHALL BE REPONSIBLE OF CONTRACTING LOCAL UNDERGROUND UTILITIES TO VERIFY LOCATIONS. THE CONTRACTOR SHOULD VISIT THE SITE PRIOR TO INSTALLATION AND BECOME FIMILIAR WITH EXISTING CONDITIONS.

THE CONTRACTOR IS RESPONSIBLE FOR ALL MATERIAL REQUIRED TO MAKE THE SYSTEM FUNCTION PROPERTY. ALL IRRIGATION SHALL BE IN ACCORDANCE WITH MANUFACTURER'S SPECIFICATION AND COMPLY WITH XERISCAPE PRINCIPLES AS SPECIFIED BY THE SOUTH FLORIDA WATER MANAGEMENT DISTRICT.

ALL SLEEVING SHALL BE SCH 40 PVC TO SIZE INDICATED ON PLAN, OR IF NOT INDICATED, A MIN. OF 2 PIPE SIZES LARGER THAN THE SUPPLY LINE CONTAINED. ALL SLEEVES SHALL BE INSTALLED A MIN. OF 24" BELOW FINISHED GRADE.

WATERING TIME PER STATION WILL BE DETERMINED IN THE FIELD AND PER LOCAL REQUIREMENTS. REFER TO MANUFACTURE'S INSTUCTIONS FOR PRECIPITATION RATES OF SPRINKLERS SPECIFIED.

LEGEND

 QTY.
 9YM.

 (5)
 0
 TORO 570-6P- 4-99T
 1.41 GFM ● 30 P91

 (3)
 0
 TORO 570 MPR PLUS 5-Q
 .19 GFM ● 30 P91

 (8)
 0
 TORO 9B-360-PC2
 .46 GPM ● 30 P91

 CLA99 200 LATERAL

 PROPOSED IRRIGATION WIRING

 ====
 PVC 9LEEVE (9CH.40)

ZONES

6HRUB & TREE ZONE

:

Preferred irrigation specs: TORO 570 MPR PLUS SRAPY NOZZLES

HARDIE ELECTRIC VALVE (100-2)

XX ZONE #/GALLONAGE

 $\frac{|\text{RRIGATION CACULATION:}}{\text{FOR IRRIGATION DESIGN.}} \frac{|\text{ZONE 1 - 11.6 GAL PER MIN REQUIRED}}{\text{FOR IRRIGATION DESIGN.}}$



6700 N. ANDREWS AVENUE SUITE 700 FT. LAUDERDALE, FLORIDA 33309 (954) 275-2400



Kimley-Horn and Associates, Inc.

© 1998 KIMLEY-HORN AND ASSOCIATES, INC. 1431 EMBARCADERO DRIVE, WEST PALM BENCH, FL 3340: PHONE: (561) 845 0665

REGISTRATION NUMBERS

KIMLEY HORN & ASSOCS., INC. EE0000696

DAVID STEWART PE 31180

CHARLES GEER PE 31435

KIRK DROST PE 51910

RUSSELL MORRISON PE 51567



NO.	DATE	DESCRIPTION
-		
	1	
		<u> </u>
	ĺ	

1	APPROVAL	S
	PROJECT MANAGER	_ DATE:
	NEXTEL RF:	_ DATE:
	PROPERTY OWNER	DATE:

ANTENNA INSTALLATION AT WINSTON PARK SITE NUMBER: FL 3672A

SCALE: AS SHOWN
DESIGNED BY: MDB
DRAWN BY: MDB
APPROVED BY: SEL
DATE: JANUARY 2001

044201071

DRAWING NUMBER

IR—1

IRRIGATION PLAN

SHEET NUMBER

47

this document, logether with the concepts and designs presented herein, as instrument of service, is intended only for the specific purpose and client for which it was prepared. Reuse of not improper refined to the document without written authorization and adaptation by Kindey-Harn and Associates.

IRRIGATION SPECIFICATIONS SCALE: AS NOTED

A. EXTENT:

Includes furnishing all labor, materials and equipment for the proper installation of the Irriguition system. The work includes, but is not limited to the following: (1) Trenching and Backfill; (2) Automatically Controlled Irrigation System; (3) Test All Systems and Make Operative; (4) *As—Bulk* Drawlings.

B. GENERAL:

- 1. Permits and Fees: Obtain all permits and pay required fees to any governmental agency having jurisdiction over the work, inspections are considered to the properties of the properties of construction shall be arranged as required. On completion of the work, solistactory evidence whell be furnished to the Tenant's construction perpendicular to show that all work has been installed in accordance with the ordinances are coder requirements.
- Approval: Wherever the terms "approve" or "approved" are used in the specifications, they shall mean the approval of the tenant's construction representative in writing
- Before any work is started, a conference shall be held between the contractor and the Tenant's construction representative concerning the work under this Contract.
- Coordination: Coordinate and cooperate with other contractors to enable the work to proceed as rapidly and efficiently as possible
- Controctor and occupions himself with all site conditions.
 Submission of his proposal shall be considered evidence that the
 Submission of his proposal shall be considered evidence that the
 General during executions. Controctor shall promptly notify the tenon's
 construction representative for instuctions to further oction.
 Follurs to do so will make controctor liable for any and all dumoys
 thereto ording from his operations subsequent to discovery of such
 statistics and shall be proposed to the control of the control of the control
 statistics and shall be proposed to the control of the control of the control
 statistics and shall be proposed to the control of the control of the control
 statistics and shall be proposed to the control of the control
- untertaillate not atoms in plant.

 Don statistics not atoms in plant.

 Don statistics not accessory distincts in the loguet as may be necessary objects, should such state not be located exactly as shown, and as may be required to work oround exist work at no increase in cost to the Tenent's construction representative.

 Protection of Estating Plants and SIts Conditions: The Contractor shall take necessary precoutions to protect site conditions to remain. Should demange be incurred, this Contractor hall repair the damage to literary and this Contractor hall repair the damage to the original condition at his own expense.

 The owner reserves the right to substitute, add, or delete any material or work as the work progresses. Adjustments to the contract price shall be negoticed if deemed received by the these are a pie delimination.

- The Owner reserves the right to rejectaterial or work which does not conform to the Contract DocumeRejected work shall be removed or corrected at the earliest time possible.
- Work Schedule: Within 10 days after award of the Contract, the contractor shall submit to the Owner a workschedule.
- 10. "As-Bull" irrigotion Drawings: Prepare on "As-Bull" drawing on a bluerint which shall show devictions from the bid documents made during construction directing the mon line page, controller locations, remote the control of the page of the
- Final Acceptance: Final acceptance of the work may be obtained from the Tenant's construction representative upon the satisfactory completion of all work.
- completion of all work.

 2. Guarantees, All work shall be guaranteed for one year from date of occeptonce against all defects in material, equipment and workmanship. Cuarantee shall disc over report of Edimorp 60 to Composition of the elements of the composition of the compositi

C. MATERIALS:

- General: All materials throughout the system shall be new and in
- perfect consisting. All main lines shall be Class 200 o-ring polywhyl chloride (PVC) pipe and shall conform to ASTM D-2241 cc 200 with gaskets conforming to ASTM 1686-F477.
 All lateral piping shall be PVC Class 160 solvent weld conforming to ASTM D-2241
- Plastic Fittings: Sch. 40 solvent weld, polyvinyl chloride (PVC) standard weight as manufactured by Slagne, Lasco, or approved equal to the standard weight as manufactured by Slagne, Lasco, or approved equal to the standard weight as manufactured by Slagne, Lasco, or approved equal to the standard weight as the standard weight weight as the standard weight as the standard weight as the standard weight weight as the standard weight weigh 4. Solvent Cement: Compatible with PVC pipe, of proper consistency, and color.
- and color.

 Sprinker Head flaters: Sch. 40 PVC for farmer, Pips elid lit or, at large the sprinker of the post of the property of the sprinker of pips and clean oil rough edge or burns. Out all threads accurately with sharp dise. Not more than threa(3) full threads accurately with sharp dise. Not more than threa(3) full threads shall show beyond fittings when pips is made up.Assembiles shall be as detailed.

 Automatic Controllers:
 San Lagged
- 7. Remote Control Valves: See Legend
- Control Wiring: 24 volt solid UL approved for direct burial in ground.
 Minimum wire size: 12 guage.
- Steeves for Control Wiring: Under all walks and paved areas and where indicated on drawings. Minimum PVC 1220–160 psi plastic pipe. 10. Sprinkler Heads: See Legend
- 11. Quick Coupling Valves: Shall be noted on drawings.

NOTES:

DO NOT SCALE PLAN FOR EXACT HEAD LOCATION.

ALL RISERS SHALL BE PAINTED FLAT BLACK. THE CONTRACTOR SHALL MAKE ALL ADJUSTMENTS TO

THE IRRIGATION SYSTEM WHICH PROVIDES A MINIMUM IOUZ CONFRACE WITH SUZ OVERLAP.

TRACT B1: 10 WRES TRACT B2: 4 WRES

THE CONTRACTOR SHALL BE RESPONSIBLE FOR HARD WRING THE THE ELECTRICAL SERVICE CONNECTIONS.

THE FINAL LOCATION OF ALL COMPONENTS SHALL BE APPROVED

ALL MAIN LINE SLEEVE LOCATION ARE ACCOMPANIED WITH A 2" ELECTRICAL CHASE FOR THE CONTROL WIRING.

D. WORKMANSHIP:

- Lay out work as accurately as possible to the drawings. The drawings, though carefully drawn, are generally diagrammatic to the extent that swing joints, offsets, and all fittings are not shown.
- The Contractor shall be responsible for full and complete coverage of all irrigated areas and shall make any necessary minor adjustments at no additional cost to the Tenant's construction representative.

E. INSTALLATION:

- Execution and Trenching:
 Perform all excountions as required for the installation of the work installating who have a substitution of the work installating who have a substitution of the work installation who have a substitution of the excountions to an an an amoner approved by the Owner.
- b. Trenches shall be made wide enough to allow a minimum of 6 inches between parallel pipe lines. Trenches for pipe lines shall be made of sufficient depths to provide the minimum cover from finish grade as
 - ollows:
 1) 18" minimum cover over main lines
- 3) 12" minimum cover over lateral lines to heads.
- Maintain all warning signs, shoring, barricades, flares and red lanterne as required by the Safety Ordere of the Division of Industrial Safety and local ordinances. 2. Pipe Line Assembly:
- Install remote control valves where shown and group together where practical; place no closer than 12 inches to walk edges, buildings and walls.
- b. Plastic pipe and fittings shall be solvent welded using solvents and connections are required. Pipe and fitings shall be thoroughly cleaned of dirt, dust and moisture before applying solvent with a non-synthetic bristle brush.
- c. Pipe may be assembled and welded on the surface. Snake pipe
- d. Make all connections between plastic pipe and metal valves or steel pipe with threaded fittings using plastic male adapters.
 - 3. Sprinkler Heads:
- a. Install all sprinklers as detailed on drawings.
 b. Do not scale plans for exact head location.
- 4. Closing of Pipe and Flushing Lines:
- a. Cap or plug all openings as soon as lines have been installed to
- place until removal is necessary for completion of installation.

 b. Thoroughly flush out all water lines before installing heads, valves and other hydrants.

 c. Test in accordance with paragraph on Hydrostatic Tests.
- Upon completion of the testing, the contractor shall complete assembly and adjust sprinkler heads for proper distribution.
- 5. Hydrostatic Tests: Request the presence of the Owner in writing at least 48 hours in advance of testing.
- odvance of testing.

 b. lazting to be accomplished at the expense of the Contractor and in the presence of the Owner.


 c. Center load piping with small amount of backfill to prevent arching or slipping under pressure.
- d. Applying a continuous and static water pressure of 125 psi when wild-opported with the cured at least 3 hours and with the risers of 100 psi of the cure of the cured at least 3 hours and with the risers 10 miles and submains to be tested for 3 hours. For o-ring gasket pipe the allowable leakage shall not exceed the number of gallens per hour as determined by the following formula:
 - _L=SD(P) -5 133200 in which:
 L=Allowable leakage, in gallons per hour
 Sellength of pipe tested in feet
 D=Pipe dometer in inches
 P=Average test pressure in PSI guage
- f. Repair leaks resulting from tests. 6 Automatic Controllers
- Connect remate control valves to controller in a clockwise sequence to correspond with station setting beginning with Stations 1, 2, 3, etc. 7. Automatic Control Wiring:
- Install control wiring, sprinkler mains and laterals in common trenches wherever possible.
- wow.new preserver possible.


 Installic ontrol were at Least 15 below finish grade and lay to the side and below the main line. Provide looped slock of valves and and when the first the side of the first the side of the sid
- All wiring passing under existing or future poving, construction, etc., shall be encesed in plastic or galvanized steel conduit extending at least \$8 point edges of paving or construction. . Backfill and Compacting:
- After system is operating and required tests and inspections have been made, backfill excovations and trenches with clean soil, free of
- Backfill for all trenches, regardless of the type of pipe covered, shall be compacted to minimum 90% density.
- c. Compact trenches in areas to be planted by thoroughly flooding the backfill. Jetting process may be used in those areas.
 d. Dress off all areas to finish grades.


F. CLEAN-UP:


1. Remove from the site all debris resulting from work of this scotion.


HEAD DETAILS

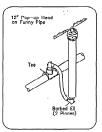

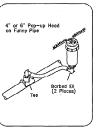

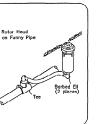


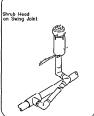

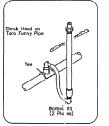

SLEEVE SIZE SCHEDULE

PIPE SIZE	SLEEVE SIZE
3/4"	1-1/4"
r	2*
1-1/4"	2-1/2"
1-1/2*	2-1/2"
2'	3'
2-1/2"	4"
3, 4"	6'

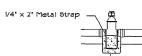






Valve Anchor

THRUST BLOCK DETAILS





NOTE: Min. thrust block size

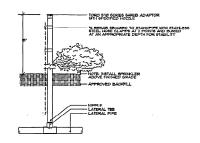

TORO SPRAY NOZZLE ON STAND-PIPE WITH SHRUB ADAPTOR

ANTENNA INSTALLATION AT WINSTON PARK SITE NUMBER: FL 3672A

APPROVALS

PROJECT MANAGER _____ DATE: ___

NEXTEL RF: DATE: ____

PROPERTY OWNER ______ DATE: ___

COMMUNICATIONS

6700 N. ANDREWS AVENUE SUITE 700 FT. LAUDERDALE, FLORIDA 33309

(954) 275-2400

Kimley-Horn and Associates, Inc.

(C) 1998 KIMLEY-HORN AND ASSOCIATES, INC.

REGISTRATION NUMBERS

SEAL

KIMLEY HORN & ASSOCS., INC.

DAVID STEWART

CHARLES CEER KIRK DROST RUSSELL MORRISON

REVISIONS

NO. DATE DESCRIPTION

ARCADERO DRIVE, WEST PALM BEACH, FL 3310 PHONE: (561) 845 0665

FR000069

PE 31180

PE 31435

PE 51910 PE 51567


MAB DESIGNED BY: DRAWN BY: APPROVED 3Y: SEL JANUARY 2001


> KHA PROJECT NUMBER 044201071

> > IR-2SHELL TITLE

IRRIGATION DETAILS

SHEET NUMBER

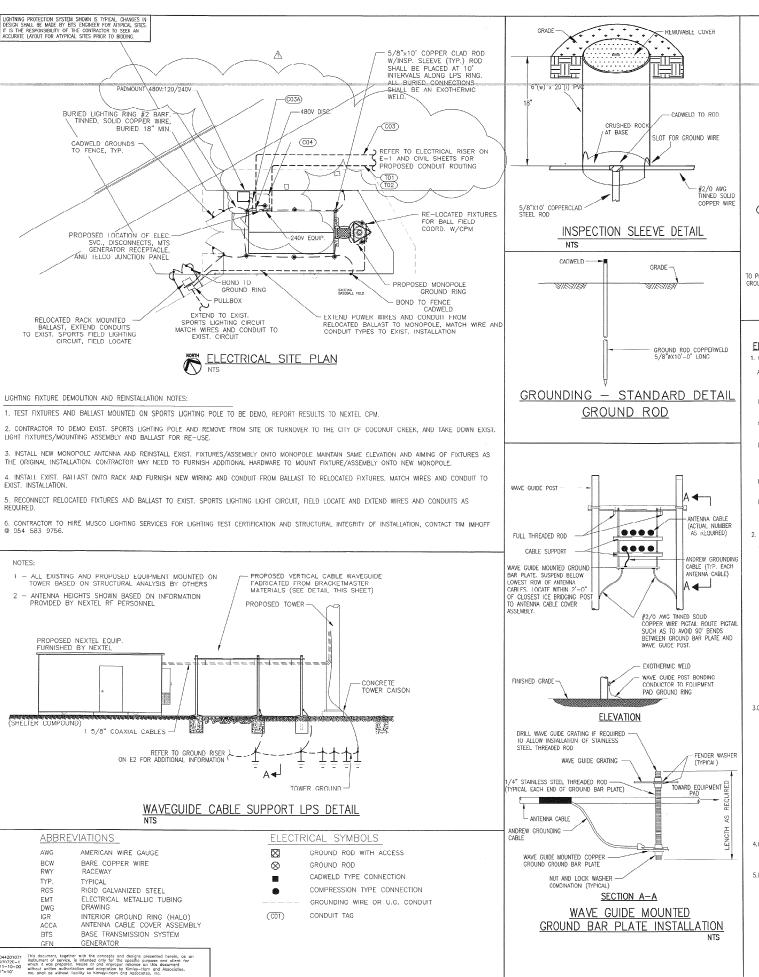

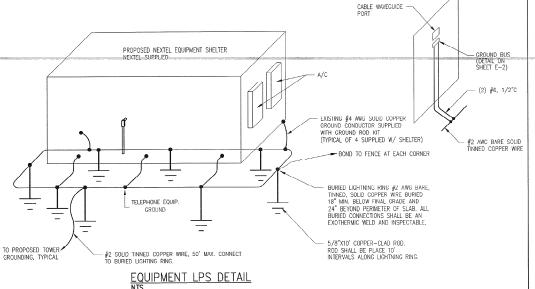

ELECTRICAL NOTES

1. CENERAL PROVISIONS

- A. THE CONTRACTOR SHALL PROVIDE ALL MATERIAL AND LABOR FOR A COMPLETE ELECTRICAL SYSTEM AS INDICATED ON THE DRAWINGS. ITEMS NOT SHOWN BUT OBVIOUSLY NECESSARY FOR A COMPLETE SYSTEM SHALL BE INCLUDED.
- D. THE CONTRACTOR SHALL OBTAIN ALL NECESSARY PERMITS, INSPECTIONS AND APPROVALS.
- C. ALL WORK SHALL CONFORM TO THE NATIONAL ELECTRICAL CODE AND THE LOCAL BUILDING CODES. ALL COMPONENTS SHALL BE U.L. APPROVED.
- D. THE CONTRACTOR SHALL BEFORE SUBMITTING HIS BID, WSIT THE SITE OF THE PROJECT AND BECOME FAMILIAR WITH THE CONDITIONS NO ALLOWANCE WILL BE MADE FOR EXISTING CONDITIONS OR FAILURE OF THE CONTRACTOR TO OBSERVE THEM.
- E. EXACT LOCATION OF ALL EQUIPMENT SHALL BE COORDINATED WITH NEXTEL, THE BUILDING OWNER AND OTHER TRADES.
- F. WHERE EQUIPMENT IS SPECIFIED BY MANUFACTURER AND TYPE, SUBSTITUTION SHALL ONLY BE MADE WITH THE APPROVAL OF THE ENGINEER. THE CONTRACTOR SHALL SUBMIT DETAILS OF PROPOSED MAIERIALS, REASON FOR CHANGE AND CHANGE IN CONTRACT AMOUNT.

2. SCOPE OF WORK

- A. THE CONTRACTOR SHALL PROVIDE ALL ELECTRICAL WIRING AND EQUIPMENT UNLESS OTHERWISE INDICATED, MAIN COMPONENTS ARE AS FOLLOWS:
- 1. PROVIDE ELECTRICAL SERVICE AS INDICATED ON THE DRAWINGS.
- PROVIDE ELECTRICAL SERVICE AS INDICATED ON THE DRAWINGS.
 PROVIDE SERVICE EQUIPMENT MOUNTED AS INDICATED ON DRAWINGS.
- Z. PROVIDE SERVICE EQUIPMENT MOUNTED AS INDICATED ON DRAWINGS.
- PROVIDE TELEPHONE CONDUIT WITH PULL WIRE AS INDICATED ON DRAWINGS.

 4. COORDINATE ELECTRICAL SERVICE WITH POWER CO. CONTACT REP. BEFORE STARTING
- 5. COORDINATE TELEPHONE SERVICE WITH LOCAL UTILITY PRIOR TO CONSTRUCTION.
- DEMO EXIST. LIGHT POLE AND RE-USE FIXTURES AS INDICATED IN DRAWINGS.
- 7. INSTALL WIRE AND CONDUIT AS INDICATED.
- 8. PROVIDE GROUNDING AND LPS AS INDICATED ON DRAWINGS.
- RESTORE ALL AREAS TO ORIGINAL CONDITION AFTER INSTALLATION OF CONDUIT. CUT AND PATCH CONCRETE AND/OR ASPHALT AS REQUIRED.
- CONTRACTOR SHALL CLEARLY LABEL DISCONNECTS, METERS, BREAKERS, TELEPHONE TERMINAL BOX AND OTHER RELATED CEAR.

3.0 CONDUIT

- A. CONDUIT SIZES AS SHOWN ON THE DRAWINGS ARE A MINIMUM. THE CONTRACTOR MAY INCREASE AS REQUIRED FOR EASE OF PULLING.
- B. CONDUIT TYPES AS FOLLOWS:
- 1. ALL ABOVE GRADE CONDUIT SHALL BE RIGID GALVANIZED STEEL.
- 2. ALL CONDUIT BELOW GRADE SHALL BE SCHEDULE 40 PVC.
- C. ALL EXPOSED CONDUIT SHALL BE NEATLY INSTALLED AND RUN PARALLEL OR PERPENDICULAR TO STRUCTURAL ELEMENTS. SUPPORTS AND MOUNTING HARDWARE SHALL BE HOT DIPPED GALVANIZED STELL CONDUITS SHALL HAVE BURRS REMOVED WITH A REAMER. CONDUITS ENTERING CABINETS SHALL HAVE LOCK NUTS INSIDE AND OUT UNLESS ENTRANCE IS THREADED. NYLON INSULATED BUSHINGS SHALL BE USED ON ALL CONDUIT TERMINATIONS.
- D. FLEX CONDUIT SHALL BE LIQUID TIGHT FLEXIBLE METALLIC CONDUIT.

4.0 CONDUCTORS


A. CONDUCTORS SHALL BE STRANDED COPPER TYPE THWN OR XHHW WITH 75 DEGREE C RISE INSULATION OR AS INDICATED ON DRAWINGS.

5.0 GROUNDING

- A. PROVIDE GROUND SYSTEM AS INDICATED ON THE DRAWINGS AND AS REQUIRED BY THE NATIONAL ELECTRIC CODE AND RADIO EQUIPMENT MANUFACTURER.
- D. ALL RACEWAYS REQUIRE GROUNDING CONDUCTORS. BONDING CONDUCTORS THROUGH THE RACEWAY SYSTEM SHALL BE CONTINUOUS FROM MAIN SWITCH GREININ BRISES TO PANNE GROUND BARS, AND FROM PANIE GROUNDING BARS TO BRANCH CIRCUIT OUTLETS, MOTORS, LIGHTS, ETC. THESE GROUND CONDUCTORS ARE REQUIRED THROUGHOUT THE PROJECT REGARDLESS OF WHETHER CONDUIT RUNS SHOW GROUND CONDUCTORS ON THE DRAWMOS.

LIGHTNING PROTECTION SYSTEM (LPS) NOTES:

- PROVIDE A LPS RING BURIED A MINIMUM OF 18" BELOW GRADE. THE LPS OTHERWISE RING SHALL BE INSTALLED 2"-0" AWAY FROM FOUNDATION (MINIMUM UNLESS SHOWN ON DRAWNO).
- 2. PROVIDED BRAIDED BONDING JUMPERS BETWEEN EACH GATE AND POST.
- BOND FENCE POST TO LPS RING USING AN EXOTHERMIC WELD. BOND FENCE GATE
 TO POST WITH A FLEXEUE COPPER JUMPER STRAP MECHANICALLY OR EXOTHERMICALL
 TYPICAL FOR ALL FENCE PLANES WITHIN 12 FEET OF TOWER FOUNDATION. FOR FENCE
 PLANES BEYOND 12', EXTEND 1#2 TO EACH FENCE PLANE TO ANY PLANES WITHIN 50'
- DISCONNECT SWITCH, METER, TELEPHONE CABINET AND SERVICE CONDUITS TO BE SEPARATELY BONDED TO 5/8" #x10"-0" LONG GROUND ROD
- 5. EACH LEG OF THE WAVEGUIDE STRUCTURE SHALL BE INDIVIDUALLY BONDED TO THE BURIED LPS RINGS AT THE TOWER AND SHELTER EXOTHERMICALLY WELD CONNECTIC AT POST FOR WAVEGUIDE STRUCTURE AND BURIED LPS RINGS. PLACE 5/8/X10' COPPERCIAD LPS ROD AT 10' INTERVALS ALONG WAVEGUIDE PATH.
- 6. BOND REBAR IN CONCRETE FOR COMMUNICATION STRUCTURE AND EQUIPMENT PAD TO BURIED LPS RING. EXOTHERMICALLY WELD A #2 AWG TINNED SOLID COPPER CONDUCTOR TO THE REBAR AND CONNECT TO THE BURIED LPS RING.
- PROVIDE INSPECTION SLEEVE AT EACH BURIED LPS RING/GROUND ROD FXOTHFRMIC CONNECTION AS SHOWN.
- 8. PROVIDE BONDING CONDUCTOR(S) FROM THE BURIED LPS RING TO THE ANTENNA CABLE BUS BAR AT POINT JUST INSIDE OF THE COMMUNICATION STRUCTURE EXTLY VERIEY FAACT I CACATION OF COPPER BUS BAR FOR PROPER CONDUCTOR LENGTH, FINAL EXOTHERMIC WELDS TO COPPER BUS BAR FOR PROPER CONDUCTOR LENGTH,
- EXCITERMICALLY WELD BONDING CONDUCTOR TO COMMUNICATION STRUCTURE LEG AT 1"-O" ADDREP ADD AND DOND TO BURIED LPS RINK, PROVIDE A 3/4" PVC SLEEVE WITH A CRADUAL BEND IN THE CONCRETE FOUNDATION.
- 5/8"X10'-0" LONG COPPER CLAD LPS ROD. 10' SPACING BETWEEN RODS (NON-LINEAR). TYPICAL FOR ALL LPS RODS SHOWN. USE STAINLESS STEEL HARDWARK WHERE APPLICABLE.
- ELECTRICAL CONTRACTOR SHALL TAKE MEGGER READINGS OF LPS. THE RESULTS SHALL NOT BE GREATER THAN 5 OHMS.
- ALL CONNECTIONS TO LPS SYSTEM SHALL BE MADE IN LINE WITH BENDS NOMINAL 12" RADIUS IN THE DIRECTION OF CURRENT FLOW. T-CONNECTIONS WILL NOT BE ALLOWED.
- 13. ALL BENDS IN LPS WIRES SHALL BE NOMINAL 12" RADIUS.
- 14. ANTENNA CABLES SHALL BE BONDED AT EACH END. RUNS GREATER THAN 150' SHALL BE BONDED TOWARDS MIDDLE OF LENGTH. COORDINATE LOCATION WITH NEXTEL'S PROJECT MANAGER.
- EXISTING TOWER GROUND RING EXACT LOCATION IS UNKNOWN. CONTRACTOR TO LOCATE AND IDENTIFY PRIOR TO CONNECTION OF BONDING CONDUCTORS. HANG DIG ONLY IN INVESTIGATION.

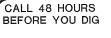

IT'S THE LAW! I-800-432-4770

SUNSHINE STATE ONE CALL OF FLORIDA, INC.

C&W engineering

ELECTRICAL CONSULTANTS
2326 S. CONGRESS AVE., SUITE 1F
WEST PALM BEACH, FL. 33406
(561) 642–5533

REGISTRATION NUMBERS

& W ENGINEERING EB000624:
ALE G. WALKER ELECTRICAL PE 3691HARLES DERI ELECTRICAL PE 1777-

NEXTEL COMMUNICATIONS

6700 N. ANDREWS AVENUE SUITE 700 FT. LAUDERDALE, FLORIDA 33309 (954) 275-2400



Kimley-Horn and Associates. Inc.

C) 1998 KIMLEY-HORN AND ASSOCIATES, INC. EMBARCADERO DRIVE, WEST PALM BEACH, FL 32407 PHONE: (561) 845 0665

REGISTRATION NUMBERS

 KIMLEY HORN & ASSOCS., INC.
 EB0000691

 DAVID STEWART
 PE 31180

 CHARLES GEER
 PE 31435

 KIRK DROST
 PE 51910

 RUSSELL MORRISON
 PE 51567



NO.	DATE	DESCRIPTION
Δ	2/19/01	480V SERVICE
-		

	APPROVALS	
	PROJECT MANAGER	DATE:
	NEXTEL RF:	DATE:
	PROPERTY OWNER	DATE:

ANTENNA INSTALLATION AT WINSTON PARK FL 3672A

SCALE: AS SHOWN
DESIGNED BY: JLR
DRAWN BY: GH
APPROVED BY: DGW
DATE: NOVEMBER 2000

KHA PROJECT NUMBER
044201071

DRAWING NUMBER


E — 1.

SHEET TITLE
ELETRICAL SITE PLAN

SHEET NUMBER

16

OF

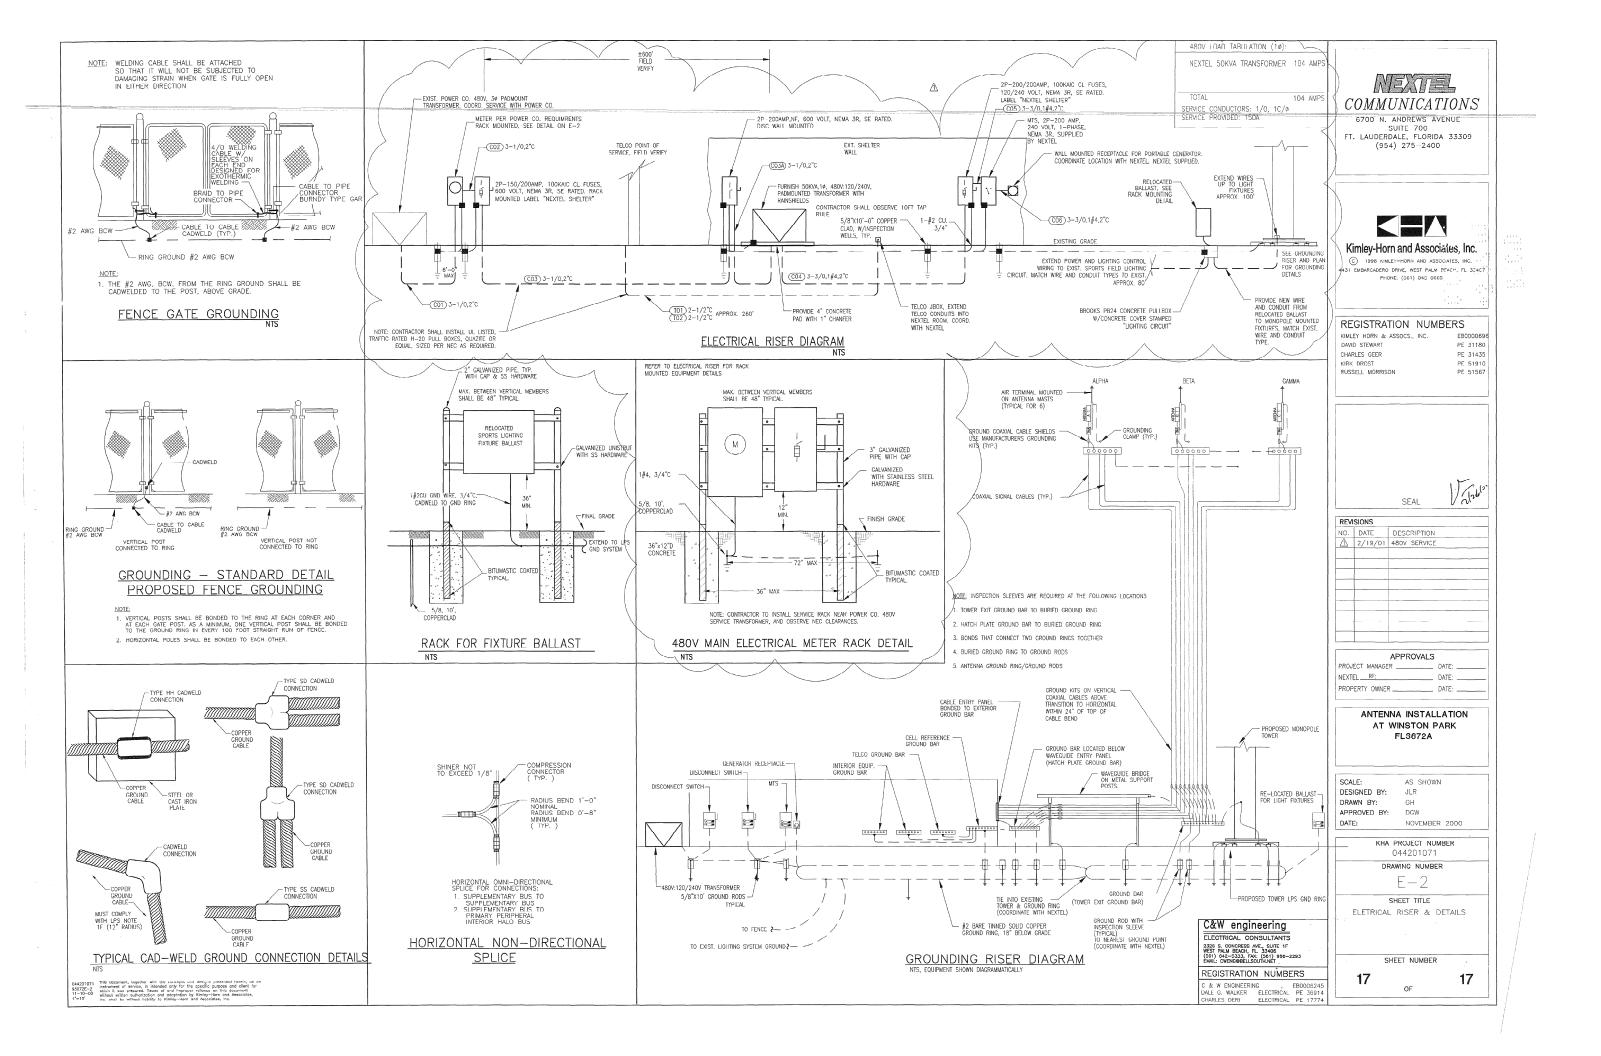

morepole (Cell Tower) Javal Park

DEFICE COPY

INSPECTIONS	APPROVAGEY	DATE	1
ZONING	1	141-5-1	
LANDSCAPING	1-112-		
ENGINEERING	The second secon		
FIRE		2-29-1	
STRUCTURAL	un	3-29-01	
ELECTRICAL	1	3 29 04	
PLUMBING			
MECHANICAL	1		
PERMIT #01-88	/ ne	1 4/13/01	
PERMIT # () 1 - 0 0			

01.881 BANYAN TRAILS
500S NW 39 AVENTE
SABAL PINES PARK
ENGINEERED ENVIROUENIS/ C.C.K
125MONOPOLE AND EQUIPSHELITER

B-

WARNING
THIS APPROVAL MUST BE ACCOMPANIED
BY A BODDEP DEVELOPMENT
REVIEW ENGCEDIRE FORM

\$\frac{25}{2}\frac{5}{2}\frac{1}

BROWARD COLNEY DEFAUTATION OF FLANNING AND ENVIRONMENTAL PROTECTION COMMISSION OF FLANNING AND ENVIRONMENTAL PROTECTION COMMISSION OF FLANNING AND ENVIRONMENTAL PROTECTION OF FLANNING ENVIRONMENT OF FLANNING ENVIRONMENTAL PROTECTION OF FLANNING ENVIRONMENTAL PROTECTION



COMMUNICATIONS

FT. LAUDERDALE MARKET

WINSTON PARK

NEW 125 FOOT MONOPOLE WITH NEW ANTENNAS AND NEW GROUND LEVEL EQUIPMENT SHELTER.

SITE NUMBER **FL 3672A**


NEXTEL LEASE PARCEL LEGAL DESCRIPTION:


COMMENCE AT THE NORTHEAST CORNER OF PARCEL "E" OF SAID BANYAN TRAILS;
THENCE SOUTH 00 50' 12" EAST, ALONG THE EAST LINE OF SAID PARCEL "E", SAID EAST LINE
ALSO BEING THE WEST RIGHT—OF—WAY LINE OF N.W. 39TH AVENUE, A DISTANCE OF 440.30 FEET;
THENCE SOUTH 89 09' 48" WEST, A DISTANCE OF 269.95 FEET, TO THE POINT OF BEGINNING
OF THE FOLLOWING DESCRIBED NEXTEL LEASE SITE:


THENCE NORTH 60 44' 49" WEST, A DISTANCE OF 48.00 FEET; THENCE NORTH 29 15' 11" EAST, A DISTANCE OF 14.34 FEET; THENCE NORTH 89 09' 42' EAST, A DISTANCE OF 11.28 FEET; THENCE SOUTH 60 44' 49" EAST, A DISTANCE OF 29.77 FEET; THENCE SOUTH 00 50' 18" EAST, A DISTANCE OF 16.88 FEET; THENCE SOUTH 29 15' 11" WEST, A DISTANCE OF 5.40 FEET, TO THE POINT OF BEGINNING.



W.L.FISH & COMPANY
PROFESSIONAL SURVEYORS AND MAPPERS

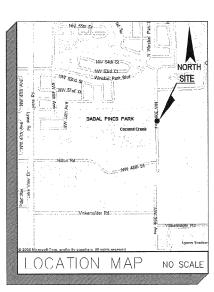

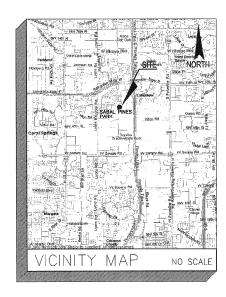

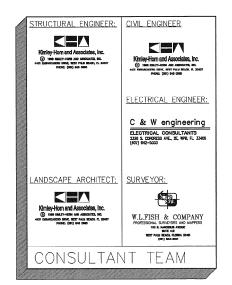

SITE ADDRESS:	SABAL PINES PARK 5005 NW 39TH AVENUE COCONUT CREEK, FL 33063
PROPERTY OWNER:	CITY OF COCONUT CREEK 4800 W. COPANS ROAD COCONUT CREEK, FL33063
CONTACT PERSON:	LARRY BROWN ENGINEERED ENVIRONMENTS 990 S. ROGERS CIR., SUITE 4 BOCA RATON, FL 33487 (561) 241-8403
APPLICANT:	NEXTEL 6700 N. ANDREWS AVENUE SUITE 700 FT. LAUDERDLE, FL 33309
CURRENT ZONING:	PUD
PROJECT	SUMMARY

WINSTON PARK

FL 3672A

SITE NAME:

SITE NUMBER:

SHT. NO.	DESCRIPTION
T-1	TITLE SHEET
	SURVEY
G-1	GENERAL NOTES #1
G-2	GENERAL NOTES #2
G-3	GENERAL NOTES #3
C-1	SABAL PINES PARK MASTER PLAN
C 2	NEXTEL SITE PLAN
C-3	DETAILS
C-4	SERVICE GATE AND FENCE DETAILS
C-5	MONOPOLE ELEVATION
S-1	SHELTER FOUNDATION
LA-1	LANDSCAPE PLAN
LA-2	LANDSCAPE DETAILS
IR-1	IRRIGATION PLAN
IR-2	IRRIGATION DETAILS
E-1	ELECTRICAL SITE PLAN
E-2	ELECTRICAL DETAILS
SHE	EET INDEX
SHE	EET INDEX

6700 N. ANDREWS AVENUE SUITE 700 FT. LAUDERDALE, FLORIDA 33309



Kimley-Horn and Associates, Inc.

C 1998 KIMLEY-HORN AND ASSOCIATES, INC. ARCADERO DRIVE, WEST PALM BEACH, FL 3340 PHONE: (561) 845 0665

REGISTRATION NUMBERS

EB000069 KIMLEY HORN & ASSOCS., INC. PE 31180 CHARLES GEER PE 31435 PE 51910 RUSSELL MORRISON PE 51567 ANGELINA G. FAIRCHILD SETH SCHMID PE 54640




		OL/ IL
REVISIONS		
NO.	DATE	DESCRIPTION
	1	

	APPROVALS	3
PROJECT MAN	AGER	DATE:
NEXTEL RF:		DATE:
PROPERTY OV	NER	DATE:

ANTENNA INSTALLATION AT WINSTON PARK SITE NUMBER: FL3672A

SCALE: AS SHOWN DESIGNED BY: DRAWN BY: APPROVED BY:

JAIL.	WAT 2001	
	KHA PROJECT NUMBER	
	044201071	
	DRAWING NUMBER	
	T-1	
	SHEET TITLE	
	TITLE SHEET	
	SHEET NUMBER	

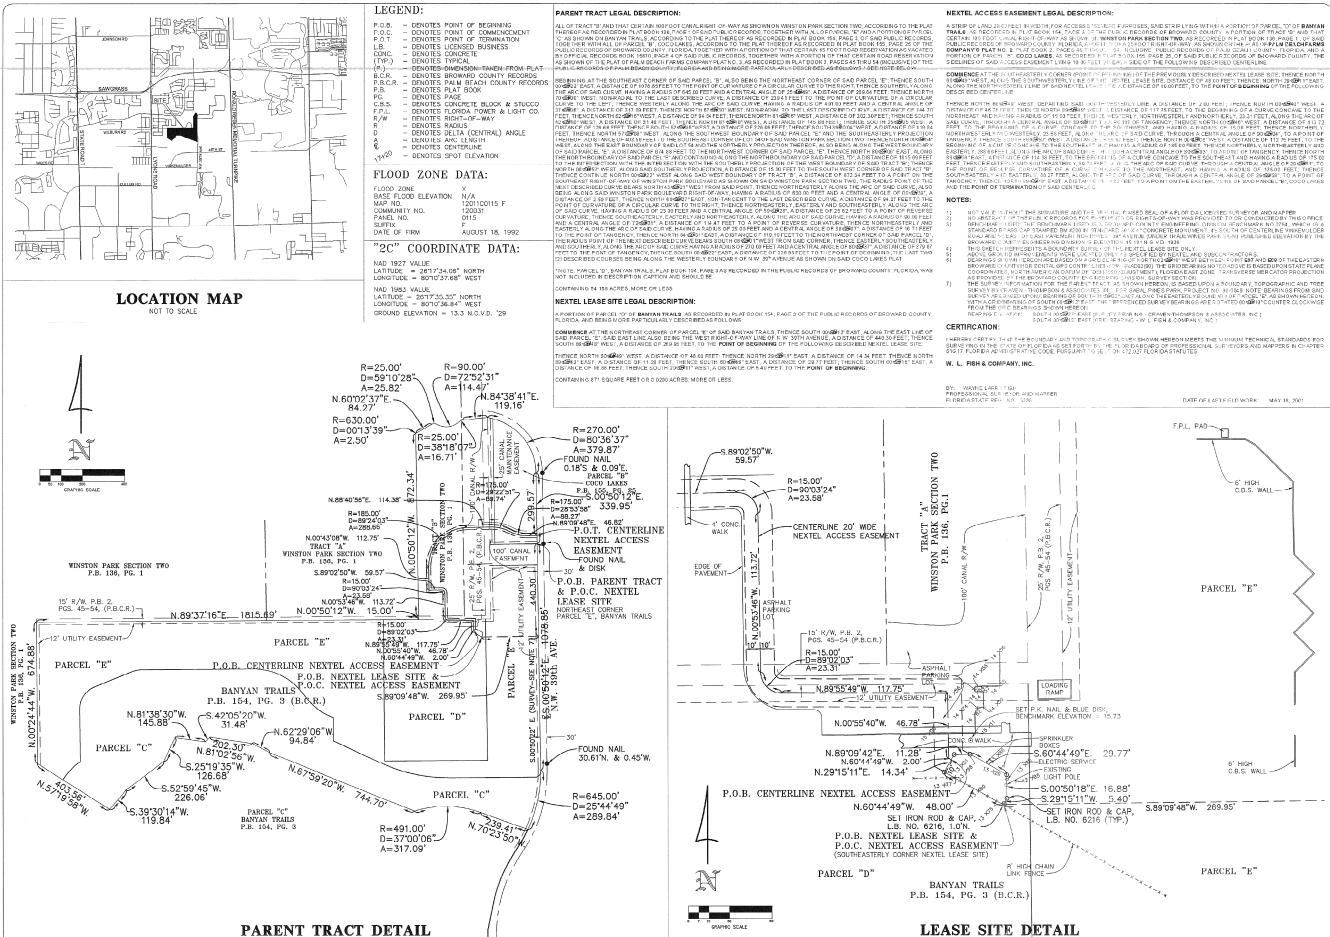

BOUNDARY AND TOPOGRAF LEASE SITE FOR: NEXTEL SITE TP/WINSTON BROWARD COUNTY, F $\begin{array}{c} A N Y_{s} \\ \text{MAPPERS} \\ \text{h. Floride } 33401 \\ \text{e1}) 659-6745 \end{array}$

 ∞

 \mathcal{O} OF

67

FL-36 PARK FLORIDA

SURVEY

MP AND N & CO RVEYORS W.L.FISH OF PROFESSIONAL SUR 7



DRAWN:

M. LA TOUR CHECKED:

W. L. FISH

05/18/2001

JOB NO.

2000-284A SHEET NO.

2 OF 17

INTENT

1-1.00 NEXTEL COMMUNICATIONS REPRESENTATIVE

A. THE NEXTEL COMMUNICATIONS SITE DEVELOPMENT MANAGER (HEREN AFTER SDM) OR HIS DESIGNEE (INCLUDING BUT NOT LIMITED TO THE ARCHITECT/ENGINEER, OR CONSTRUCTION MANAGER) SHALL SERVE AS THE SINGLE POINT OF CONTACT BETWEEN THE CONTRACTOR AND NEXTEL COMMUNICATIONS. NOT WITH STANDING THE REQUIREMENTS SPECIFIED HEREIN, THE SDM OR DESIGNATED REPRESENTATIVE IS EMPOWERED TO DIRECT THE CONTRACTOR TO VARY OR CHANGE FROM THE PLANS AND SPECIFICATIONS AS CIRCUMSTANCES OR CONDITIONS ARISE.

- A. THESE SPECIFICATIONS AND CONSTRUCTION DRAWINGS ACCOMPANYING THEM DESCRIBE THE WORK TO BE PERFORMED AND THE MATERIALS TO BE FURNISHED FOR THE CONSTRUCTION OF THE NEXTEL COMMUNICATIONS SITE NO. FLJ672B, WINSTON PARK
- B. THE DRAWINGS AND SPECIFICATIONS ARE INTENDED TO BE FULLY EXPLANATORY AND COMPLIMENTARY. HOWEVER, SHOULD ANYTHING BE SHOWN, INDICATED OR SPECIFIED ON ONE AND NOT THE OTHER, IT SHALL BE THE SAME AS IF SHOWN, INDICATED OR SPECIFIED ON BOTH.
- C. THE INTENTION OF THE DOCUMENTS IS TO INCLUDE ALL LABOR AND MATERIALS REASONABLY NECESSARY FOR THE PROPER EXECUTION AND COMPLETION OF THE WORK AS INDICATED IN
- D. THE PURPOSE OF THE SPECIFICATIONS IS TO SUPPLEMENT THE INTENT OF THE DRAWINGS AND TO DESIGNATE A PROCEDURE. TYPE OR QUALITY OF MATERIALS REQUIRED TO COMPLETE THE WORK.
- E. MINOR DEVIATIONS FROM THE DESIGN LAYOUT ARE ANTICIPATED AND SHALL BE CONSIDERED AS PART OF THE WORK HOWEVER, NO CHANCES THAT ALTER THE CHARACTER INTENT OF THE DESIGN WILL BE MADE OF PERMITTED BY NEXTEL, INC WITHOUT A

1-1.02 CONFLICTS

- A. THE CONTRACTOR AND EACH SUBCONTRACTOR SHALL BE RESPONSIBLE FOR VERHICATION OF ALL MEASUPEWENTS AT THE SITE BEFORE ORDERING ANY MATERIALS OR PERFORMING ANY WORK. NO EXTRA CHARGE OR COMPENSATION SHALL BE ALLOWED DUE TO DIFFERENCE BETWEEN ACTUAL DIMENSIONS AND DIMENSIONS INDICATED ON THE CONSTRUCTION DRAWNICS. ANY SUCH DISCREPANCY IN DIMENSION WHICH MAY INADVERTIENTLY OCCUR SHALL BE SUBMITTED TO THE NEXTEL COMMUNICATIONS SUM FOR CONSIDERATION BEFORE THE CONTRACTOR PROCEEDS WITH THE WORK IN THE AFFECTED AREA.
- THE CONTRACTOR, IF AWARDED THE CONTRACT, WILL NOT BE ALLOWED ANY EXTRA COMPENSATION BY REASON OF ANY MATTER OR THING WHICH SUCH THE CONTRACTOR MIGHT NOT HAVE FULLY INFORMED HIMSELF PRIOR TO BIDDING.
- NO PLEA OF IGNORANCE OF CONDITIONS THAT EXIST, OR OF DIFFICULTIES THAT MAY BE ENCOUNTERED OR OF ANY OTHER RELEVANT MATTER CONCERNING THE WORK TO BE PERFORME! WILL BE ACCEPTED AS A REASON FOR ANY FAILURE OR OMISSION ON PART OF THE CONTRACTOR TO FULFILL THE REQUIREMENTS OF THE CONTRACT DOCUMENTS.

A. BIDDING SCOPE

CONTRACTORS TO SUPPLY ALL MATERIALS AND PERFORM ALL LABOR AS SHOWN, AND PROVIDE ALL TOOLS, EQUIPMENT AND TRANSPORTATION NECESSARY TO COMPLETE THE WORK AS DESCRIBED IN THE DRAWNOS AND SPECIFICATIONS.

- ANTENNA CONSIST OF: (9) BASE STATION ANTENNAS FURNISHED BY NEXTEL COMMUNICATIONS.
- ALL ADDITIONAL ANTENNAS SUPPLIED BY: NEXTEL COMMUNICATIONS
- ALL FOAM DIELECTRIC COAXIAL CABLES AND JUMPER CABLES SUPPLIED BY NEXTEL COMMUNICATIONS
- 4. INTERCONNECTION METHOD: T-SPAN
- 5. RADIO EQUIPMENT (FNE) SUPPLIED BY NEXTEL COMMUNICATIONS AND IS INSTALLED BY: OTHERS
- COMMERCIAL POWER SURGE ARRESTOR SUPPLIED BY NEXTEL COMMUNICATIONS
- 7. TELEPHONE FACILITY SURGE ARRESTOR SUPPLIED BY NEXTEL COMMUNICATIONS

NOTE: GENERAL CONTRACTOR TO PICK UP FURNISHED MATERIALS AS DIRECTED BY SDM.

B. INSTRUCTIONS TO BIDDERS

NEXTEL COMMUNICATIONS REQUESTS A FIRM SUM BID FOR ALL WORK DESCRIBED IN THE CONTRACT AND AS INDICATED IN THESE CONSTRUCTION DRAWINGS AND SPECIFICATIONS.

BIDDERS WILL GUARANTEE BIDS FOR 60 DAYS FROM BID DUE DATE. BIDS SHALL INCLUDE ALL APPLICABLE STATE AND FEDERAL TAXES.

2. PROPOSAL: (AS OUTLINED IN BID DOCUMENTS)

IT IS UNDERSTOOD BY NEXTEL COMMUNICATIONS THAT THE BIDDER IN SUBMITTING HIS BID, WARRANTS THAT HE HAS: CAREFULLY EXAMINED THE SITE OF THE PROJECT TO ACQUAINT HIMSELF WITH:

- A. SURROUNDING PROPERTIES.
- B. MEANS OF APPROACH TO THE SITE.
- C. CONDITIONS OF THE ACTUAL JOB SITE.
- D. FACILITIES FOR DELIVERING, STORING, PLACING, HANDLING, AND REMOVAL OF MATERIALS AND EQUIPMENT.
- ANY AND ALL DIFFICULTIES THAT MAY BE ENCOUNTERED DURING THE EXECUTION OF ALL WORK IN ACCORD WITH THE CONTRACT DOCUMENTS.

1-1 04 CONTRACTS AND WARRANTIES

- A. "A1A DOCUMENT A107" ABBREVIATED FORM OF AGREEMENT BEIWEEN NEXIEL COMMUNICATIONS AND CONTRACTOR HAS BEEN MODIFIED AND WILL BE EMPLOYED FOR CONTRACT PURPOSES.
- B. EACH CONTRACTOR IS RESPONSIBLE FOR PULLING THE BUILDING PERMIT AT THE LOCAL JURISDICTION AS THE CONTRACTOR OF RECORD, AND PROVIDE JURISDICTION WITH ALL PROOF REQUIRED TO OPERATE AS A CONTRACTOR IN THAT JURISDICTION. THE CONTRACTOR SHALL BE REIMBURSED FOR THE AMOUNT OF ANY FEE PAID AS FOLLOWS:
 - PLAN REVIEW FEE. BUILDING PERMIT FEE.
 - CONNECTIONS AND INSPECTIONS FEE.
- C. EACH CONTRACTOR IS RESPONSIBLE FOR APPLICATION & PAYMENT OF CONTRACTOR LICENSES & BONDS.

- A. DO NOT USE THE EXISTING BUILDING SPACE FOR STORAGE OF TOOLS OR MATERIALS WITHOUT THE SDM AND/OR BUILDING OWNER APPROVAL.
- B. ALL MATERIALS MUST BE STORED IN A LEVEL AND DRY LOCATION AND IN A MANNER THAT WILL NOT OBSTRUCT THE FLOW OF OTHER WORK, ANY EQUIPMENT OR MATERIAL STORAGE METHOD MUST MEET ALL RECOMMENDATIONS OF THE

- A. PROTECT FINISHED SURFACES, INCLUDING JAMBS AND HEADS OF OPENINGS USED AS PASSAGEWAYS THROUGH WHICH EQUIPMENT AND MATERIALS WILL PASS.
- B. PROVIDE PROTECTION FOR EQUIPMENT ROOM SURFACES PRIOR TO ALLOWING EQUIPMENT OR MATERIALS TO BE MOVED OVER SUCH SURFACES.
- C. MAINTAIN FINISHED SURFACES CLEAN, UNMARRED AND SUITABLY PROTECTED UNTIL JOB SITE IS ACCEPTED BY SDM.

1-1.07 REPAIRS AND REPLACEMENTS:

- A. IN EVENT OF DAMAGE, THE CONTRACTOR SHALL PROMPTLY MAKE ALL REPLACEMENTS AND REPAIRS AND AT NO ADDITIONAL COST TO NEXTEL COMMUNICATIONS AND/OR BUILDING OWNER.
- B. ADDITIONAL TIME REQUIRED TO SECURE REPLACEMENTS AND TO MAKE REPAIRS WILL NOT BE CONSIDERED BY NEXTEL COMMUNICATIONS TO JUSTIFY AN EXTENSION IN THE CONTRACT TIME FOR COMPLETION.

1-1.08 TEMPORARY FACILITIES:

- A. WATER: WATER IS NOT AVAILABLE TO THE CONTRACTORS ON SITE.
- B. LIGHT AND POWER:
 - LIGHT AND POWER ARE NOT AVAILABLE ON SITE.

EACH CONTRACTOR TO PROVIDE HIS OWN TELEPHONE ACCESS IF REQUIRED.

CONTRACTORS ARE NOT TO USE NEXTEL COMMUNICATIONS

D. IF PERMANENT POWER IS COMPLETED, ALL CONTRACTORS MAY USE THE SERVICE CONNECTION FOR PRODUCTION WORK ONLY, PROVIDED THAT ELECTRICAL CORDS AND CONNECTIONS ARE FURNISHED BY 1HE CONTRACTIONS AND ARE DISCONNECTED AND PROPERLY STORED DURING NON-WORKING HOURS.

- THE CONTRACTORS SHALL AT ALL TIMES KEEP THE SITE FREE FROM ACCUMULATION OF WASTE MATERIALS OR RUBBISH CAUSED BY THEIR REMLOYESS AT WORK, AND AT THE COMPLETION OF THE WORK. THEY SHALL REMOVE ALL RUBBISH FROM AND ABOUT THE BUILDING, INCLUDING ALL TOOLS, SCAFFOLDING AND SURPLUS MATERIALS, AND SHALL LEAVE THE WORK CLEAN AND PREADLY FOR USE
- B. EXTERIOR: VISUALLY INSPECT EXTERIOR SURFACES AND REMOVE ALL TRACES OF SOIL, WATER MATERIALS, SMUDGES AND OTHER FORFIGN MATTER.
 - REMOVE ALL TRACES OF SPLASHED MATERIALS FROM ADJACENT SURFACES.
- INTERIOR: VISUALLY INSPECT INTERIOR SURFACE AND REMOVE ALL TRACES OF SOIL, WASTE MATERIALS, SMUDGES AND OTHER FOREIGN MATTER.
- REMOVE ALL TRACES OF SPLASHED MATERIAL FROM ADJACENT SURFACES.
- REMOVE PAINT DROPPINGS, SPOTS, STAINS AND DIRT FROM FINISHED SURFACES.
- CONTRACTOR SHALL WASH AND WAX FLOOR PRIOR TO FINAL ACCEPTANCE. FLOOR WAX SHALL BE OF THE ANTI-STATIC

1 1.10 CHANCE ORDER PROCEDURE:

- CHANGE ORDER MAY BE INITIATED BY THE SDM, AND/OR THE CONTRACTOR. THE CONTRACTOR, UPON VERBAL REQUEST FROM THE SDM SHALL PREPARE A WRITTEN PROPOSAL DESCRIBING THE CHANGE IN WORK OR MATERIALS AND ANY CHANGES IN THE CONTRACT AMOUNT AND PRESENT TO THE SDM FOR APPROVAL. CONTRACT AMOUNT AND PRESENT TO THE SDM FOR APPROVAL.
 SUBMIT REQUESTS FOR SUBSTITUTIONS IN THE FORM AND IN
 ACCORDANCE WITH PROCEDURES REQUIRED FOR CHANGE ORDER
 PROPOSALS. ANY CHANGES THE SCOPE OF WORK OR MATERIALS
 WHICH ARE PERFORMED BY THE CONTRACTOR WITHOUT A WRITTEN
 CHANGE ORDER AS DESCRIBED AND APPROVED BY THE SDM.
 SHALL BECOME THE SOLE RESPONSIBILITY OF THE CONTRACTOR.
- RELATED DOCUMENTS AND COORDINATION:
- GENERAL CARPENTRY, ELECTRICAL, AND ANTENNA DRAWINGS ARE INTERRELATED. IN PERFORMANCE OF THE WORK, EACH CONTRACTOR MUST REFER TO ALL DRAWINGS. ALL COORDINATION TO BE THE RESPONSIBILITY OF THE GENERAL CONTRACTOR.

1-1.12 SHOP DRAWINGS:

- A. CONTRACTORS TO SUBMIT SHOP DRAWINGS AS REQUIRED AND LISTED IN THESE SPECIFICATIONS THROUGH THE GENERAL CONTRACTOR TO THE SDM, FOR APPROVAL.
- B. ALL SHOP DRAWINGS TO BE REVIEWED, CHECKED AND CORRECTED BY GENERAL CONTRACTOR PRIOR TO SUBMITTAL TO THE SDM.

1-113 PRODUCTS AND SUBSTITUTIONS:

- SUBMIT 3 COPIES OF EACH REQUEST FOR SUBSTITUTION. IN EACH REQUEST IDENTIFY THE PRODUCT FABRICATION OR INSTALLATION-METHOD-TO-DE-REPLACED-BY-THE-SUBSTITUTION. INCLUDE RELATED SPECIFICATION SECTION AND DRAWING
- ALL NECESSARY PRODUCT DATA AND CUT SHEET WHICH PROPERLY INDICATE AND DESCRIBE THE ITEMS, PRODUCTS, AND MATERIALS BEING INSTALLED. THE CONTRACTOR SHALL, IF DEEMED NECESSARY BY THE SOM, SUBMIT ACTUAL SAMPLES TO THE SDM FOR APPROVAL IN LIEU OF CUT SHEETS.

1-1 14 COMPLIANCE

REFERENCE TO ANY STANDARD OR CODE OF PRACTICE IN THIS REFERENCE TO ANY STANDARD OR CODE OF PRACTICE IN THIS SPECIFICATION SHALL BE DEFINED TO MEAN THE EDITION CURRENT AT THE TIME OF AWARD OF THE CONTRACT.

THE CONTRACTOR SHALL STIPULATIONS AS OUTLINED IN THE JOB SPECIFICATIONS, OR AS DIRECTED BY THE SDM.

> ANSI/EIA - 222 - E STANDARD BUILDING CODE STANDARD BOTEDING CODE
> BUILDING OFFICIALS & CODE ADMINISTRATORS (BOCA)
> NATIONAL ELECTRICAL CODE (NEC) WITH LOCAL AMENDMENTS
> UNDERWRITERS LABORATORIES APPROVED ELECTRICAL PRODUCTS

1-1.15 ADMINISTRATION

- A. THE CONTRACTOR SHALL FURNISH TO THE SDM WITH THE NAME AND CONTACT TELEPHONE NUMBERS (MOBILE, PAGER, AND RESIDENCE/HOTEL) OF THE NEXTEL APPROVED ON—SITE SUPERVISION. ANY CHANGES IN SUPERVISION MUST BE REPORTED TO THE SDM IMMEDIATELY AND ARE SUBJECT TO NEXTEL APPROVAL.
- B. PERMITS AND LICENSES

THE CONTRACTOR SHALL OBTAIN, AT HIS OWN EXPENSE, ALL REQUIRED LOCAL, STATE, AND/OR COUNTY CONSTRUCTION PERMITS AND LICENSES. COPIES OF ALL PERMITS SHALL BE SENT TO SOM. APPROVALS FROM RELEVANT PLANNING BOARDS ENURONMENTAL BOARDS, AND/OR OTHER COMMITTERS WILL BE SUPPLIED BY OTHERS, BUT MUST BE CONFIRMED BY THE CONTRACTOR PRIOR TO THE APPLICATION FOR CONSTRUCTION

FAA APPROVAL WILL BE SUPPLIED BY OTHERS, BUT MUST BE

SUBMIT A BAR CHART TYPE PROGRESS SCHEDULE NOT MORE THAN 3 DAYS AFTER THE DATE ESTABLISHED FOR COMMENCEMENT OF THE WORK ON THE SCHEDULE. INDICATE A TIME BAR FOR EACH MAJOR CATEGORY OR UNIT OF WORK TO BE PERFORMED AT SITE, PROPERLY SEQUENCED AND COORDINATED WITH OTHER ELEMENTS OF WORK. SHOW COMPLETION OF THE WORK SUFFICIENTLY IN ADVANCE OF THE DATE ESTABLISHED FOR SUBSTANTIAL COMPLETION OF THE WORK. THE SCHEDULE SHALL INCLUDE START AND FINISH DATES FOR THE FOLLOWING ITEMS:

BUILDING PERMIT
FINISH CARPEN IRY
INSPECTIONS
GROUNDING SYSTEM
COMMERCIAL AC POWER
ANTENNA INSTALLATION

- PRIOR TO COMMENCING THE WORK, THE GENERAL CONTRACTOR SHALL SCHEDULE AN ON-SITE MEETING WITH ALL MAJOR PARTIES TO THE PROJECT. THIS WOULD INCLUDE (THOUGH NOT LIMITED TO) THE DESIGNATED ELECTRICIAN, LOCAL TELEPHONE COMPANY, CARPENTRY FOREMAN (IF SUBCONTRACTED), A REPRESENTATIVE FROM THE LOCAL SPECIFIED WAREHOUSE AND SDM OR HIS DESIGNATED REPRESENTATIVE.
- CONTRACTOR SHALL FIELD VERIFY ALL EXISTING UTILITIES BOTH HORIZONTALLY AND VERIFICALLY PHIOR TO START OF THE INTERPRETATION OF PLANS SHOULD BE IMMEDIATELY REPORTED TO THE ARCHITECT/ENGINEER FOR RESOLUTION AND INSTRUCTION AND MO FURTHER WORK SHALL BE PERFORMED UNTIL DISOREPANCY IS CHECKED AND CORRECTED BY THE ARCHITECT/ENGINEER. FAILURE TO SECURE SUCH INSTRUCTION MEANS CONTRACTOR WILL HAVE WORKED AT HIS OWN RISK AND
- THE CONTRACTOR SHALL BE EQUIPPED WITH A MEANS OF CONSTANT COMMUNICATIONS, SUCH AS A CELLULAR PHONE OR A PAGER. THIS EQUIPMENT WILL NOT BE SUPPLIED BY NEXTEL COMMUNICATIONS NOR WILL SERVICE BE ARRANGED.
- THE CONTRACTOR IS RESPONSIBLE FOR ALL SAFETY INCLUDING BUT NOT LIMITED TO PROTECTION OF ALL SITE PERSONNEL AND THE GENERAL PUBLIC DURING THE ENTIRE SITE PERSONNEL AND PERIOD. HE SHALL TAKE ALL REASONABLE PRECAUTIONS TO PLACE AND MAINTAIN BARRICAUES, LAMPS, SIGNS, AND THE LIKE IN ACCORDANCE WITH OSHA SAFETY ACT AND ANSI OCCUPATIONAL GUIDELINES.
- PROVIDE DAILY UPDATES ON SITE PROGRESS, EITHER VERBAL OR WRITTEN TO SDM.
- COMPLETE INVENTORY OF CONSTRUCTION MATERIALS AND EQUIPMENT IS REQUIRED PRIOR TO START OF CONSTRUCTION.
- J NOTICES UNDER THE CONTRACT

ALL NOTICES, APPLICATIONS, INSTRUCTIONS AND REQUESTS TO BE GIVEN TO THE CONTRACT MAY DE GIVEN VERBALLY OR IN WRITING, AT HIS OWN DISCRETION, THE CONTRACTOR SHALL FORWARD TO THE SDM A LETTER CONFORMING HIS VERBALL AGREMENT.

COORDINATION WITH PUBLIC UTILITY AUTHORITIES

THE CONTRACTOR SHALL COORDINATE WITH RELEVANT AUTHORITES THE WORKS THEY ARE TO BE CARRIED OUT. SHALL COMDUCT HIS OPERATIONS SO AS TO NOT INTERFERE WITH THE OPERATIONS OF PUBLIC AND/OR PRIVATE UTILITY AUTHORITIES, INSTALLING SERVICES ON THE SITE.

THE CONTRACTOR WILL BE RESPONSIBLE FOR THE PROTECTION OF SUCH FACILITIES AND STRUCTURES DURING CONSTRUCTION OF THIS SITE.

THE CONTRACTOR SHALL NOTIFY THE SDM AT LEAST 24 HOURS IN ADVANCE OF REQUIRED INSPECTIONS. INSPECTIONS THAT WILL BE REQUIRED BY THE SDM OR OTHER DESIGNATED NEXTEL REPRESENTATIVE ARE:

1. INSPECTION OF GROUNDING SYSTEM

THE CONTRACTOR SHALL BE SOLELY RESPONSIBLE FOR ENSURING THAT ALL RELEVANT AUTHORITY INSPECTIONS ARE CARRIED OUT IN A TIMELY MANNER. THE CONTRACTOR SHALL PROVIDE DOCUMENTATION OF ALL INSPECTIONS.

THE CONTRACTOR IS RESPONSIBLE FOR COORDINATING WITH NEXTEL'S DESIGNATED ENGINEERING FIRM TO OBTAIN ALL REQUIRED INSPECTIONS AND TESTING. THE CONTRACTOR SHALL PROVIDE DOCUMENTATION OF ALL INSPECTIONS.

M. ENVIRONMENTAL PROTECTION

INSPECTIONS

NOISE LEVEL: THE CONTRACTOR SHALL ENSURE THAT STATE AND LOCAL REGULATIONS ARE COMPLIED WITH IN REGARD TO NOISE LEVELS PRODUCED BY HIS OR HIS SUB-CONTRACTOR'S EQUIPMENT OR METHODS OF CONSTRUCTION

DUST CONTROL: THE CONTRACTOR SHALL TAKE ALL NECESSARY STEPS TO LIMIT THE CREATION OF ANY DUST NUISANCE THAT MIGHT ARISE DURING CONSTRUCTION TO THE SATISFACTION OF THE LOCAL AUTHORITES AND THE BUILDING OWNER. THE SDM MAY DIRECT THAT WORK CEASE UNITL SUCH TIME AS ANY PARTICULAR DUST NUISANCE IS CONTROLLED TO THE SATISFACTION OF THE SDM, LOCAL AUTHORITES, AND BUILDING OWNERS.

ANY PAVEMENT, FOOTPATH, CURB, CUTTERS, WALLS, FLOORS, SERVICES, AND SUSSING FEATURES OR OTHER PROPERTIES. DISTURBED OR DESTROYED DURING CONSTRUCTION SHALL BE REINSTATED TO A COUNTION AT LEAST LOUAL TO THAT LISTING BUFORE COMMENCEMENT OF OPERATIONS.

O AS-BUILTS DRAWINGS

AS-BULLIS DRAWINGS
THE CONTRACTOR SHALL PREPARE A RED LINED SET OF ASBUILT DRAWINGS. THE FORM OF MARKED UP CONSTRUCTION
PLANS SHALL BE STANDARD ACCEPTABLE TO THE SDM. SUCH
DRAWINGS SHALL BE SUBMITTED TO THE SDM. WITHIN TWO WEEKS
FROM PRACTICAL COMPLETION AND PRIOR TO APPROVAL OF THE
CONTRACTOR'S FINAL INVOICE.

DOCUMENTATION BY NEXTEL BEFORE COMPLETION CAN BE ISSUED

- ALL QUALITY ASSURANCE CHECKLISTS AS OUTLINED IN THE PREVIOUS SECTIONS
- 2. WARRANTIES AND MAINTENANCE MANUALS, IF APPLICABLE
- 3. GROUND SYSTEM RESISTANCE TEST 4. CERTIFICATE OF OCCUPANCY

MARKED UP DRAWINGS SUITABLE TO PRODUCE AS-BUILTS WILL BE REQUIRED WITHIN TWO WEEKS FOLLOWING PRACTICAL COMPLETION AND BEFORE FINAL PAYMENT. THESE DRAWINGS SHALL BE SUBMITTED TO THE SOM FOR APPROVAL AND FURTHER

LINE WAIVERS AS OUTLINED IN THE PAYMENT TERMS OF THE CONTRACT WILL BE REQUIRED PRIOR TO APPROVAL OF FINAL PAYMENT.

1 - 1.16 INSURANCE AND BONDS:

- A. EACH CONTRACTOR SHALL AT HIS OWN EXPENSE CARRY AND MAINTAIN FOR THE DURATION OF THE PROJECT ALL INSURANCE AS REQUIRED AND LISTED AND SHALL NOT COMMENCE WITH HIS WORK UNTIL HE HAS PRESENTED A CERTIFICATE OF INSURANCE STATING ALL COVERAGES TO THE GENERAL CONTRACTOR WHO SHALL, IN TURN, FORWARD A COPY OF ALL CERTIFICATES TO THE SDM.
- NEXTEL COMMUNICATIONS SITE NO. FL3672D, WINSTON PARK SHALL BE NAMED AS ADDITIONAL INSURED ON ALL
- THE FOLLOWING ITEMS ARE QUALIFICATIONS THAT NEXTEL COMMUNICATIONS WILL REQUIRE FROM THE CONTRACTOR WHO IS AWARDED THE CONTRACT.
- CONTRACTOR MUST PROVIDE PROOF OF INSURANCE MEETING NEXTEL COMMUNICATIONS INSURANCE REQUIREMENTS. THE FOLLOWING IS A LIST OF MINIMUM INSURANCE REQUIREMENTS REQUIRED BY NEXTEL COMMUNICATIONS:

STATUTORY WORKERS' COMPENSATIONS, INCLUDING \$500,000.00 EMPLOYERS' LIABILITY.

- 2. COMPREHENSIVE CENERAL LIABILITY INCLUDING PERSONAL INJURY, BROAD FORM PROPERTY DAMAGE, INDEPENDENT CONTRACTOR, "XCU", AND PRODUCTS/COMPLETED OPERATIONS, WITH LIMITS NOT LESS "HAN \$2,000,000 PER OGCURRENGE.
- 3. ADDITIONAL INSURED ENDORSEMENT NAMING NEXTEL COMMUNICATIONS AND KIMLEY-HORN AND ASSOCIATES, INC. ON THE LIABILITY POLICIES OF THE CONTRACTOR.
- 4. AUTOMOBILE LIABILITY NOT LESS THAN \$1,000,000.00 PER OCCURRENCE.
- 5. EXCESS LIABILITY "UMBRELLA" POLICY OF \$5,000,000,000 PER OCCURRENCE.

NEXTE **COMMUNICATIONS**

6700 N. ANDREWS AVENUE SUITE 700 FT. LAUDERDALE, FLORIDA 33309 (954) 275-2400



(C) 1998 KIMLEY-HORN AND ASSOCIATES, INC.

4431 EMBARCADERO DRIVE, WEST PALM BEACH, FL 33407

PHONE: (561) 845 0665

REGISTRATION NUMBERS

DAVID STEWART PE 31180 CHARLES GEER PE 31435 PE 51910 RUSSELL MORRISON PE 51567



NO.	DATE	DESCRIPTION

APPROVALS		
PROJECT MANAGER	DATE:	
NEXTEL RF:	DATE:	
PROPERTY OWNER	DATE:	

ANTENNA INSTALLATION AT WINSTON PARK SITE NUMBER: FL 3672A

DESIGNED BY: JBC DRAWN BY AJD APPROVED BY: DWS DATE: MAY 2001

KHA PROJECT NUMBER
044201071
DRAWING NUMBER
G-1
SHEET TITLE

SHEET NUMBER

3

GENERAL NOTES #1

OF

17

NUMBERS, AND COMPLETE DOCUMENTATION SHOWING COMPLIANCE WITH THE REQUIREMENTS FOR SUBSTITUTIONS.

COMPLANCE
ALL MATERIALS, DESIGN, AND WORKMANSHIP SHALL BE IN
ACCORDANCE WITH ALL APPLICABLE CODES (SOME OF WHICH ARE
LISTED BELOW), ORDINANCES, AND AUTHORITIES HAVING
JURISDICTION OVER THE WORK. UPON THE COMPLETION OF THE
WORK, THE CONTINATOROTS SHALL PROVIDE NEXTEL WITH A
CERTIFICATE OF OCCUPANCY (IF REOURED) AND OTHER LEGAL
DOCUMENTS TO KERTEY SUCH COMPLIANCE. WHERE NO CODES
EXIST, THE WORK SHALL CONFORM WITH THE STRADARD
BUILDING CODE, AND/OR THE
SPECIFICATIONS HEREIN, WHICHEVER IS MORE STRINGENT, AND
A DOCUMENT STATEMENT SHALL BE FURNISHED TO THIS EFFECT.

IT IS THE CONTRACTOR'S RESPONSIBILITY TO VERIFY COMPLIANCE WITH THE GOVERNING CODES AND TO NOTIFY THE SDM OF ANY DISCREPANCIES PRIOR TO PERFORMING WORK.

AMERICAN INSTITUTE OF STEEL CONSTRUCTION SPECIFICATIONS (AISC)
LIFE SAFETY CODE NFPA — 101
FEDERAL AVIATION REGUIATIONS

- CONTRACTOR SHALL FIELD VERIFY ALL EXISTING UTILITIES

- CONTRACTOR SHALL PERFORM ALL VERIFICATION
 OBSERVATIONS TESTS, AND EXAMINATION WORK PRIOR—TO
 THE ORDERING OF THE ELECTRICAL COUPMENT AND THE
 ACTUAL CONSTRUCTION. CONTRACTOR SHALL ISSUE A
 WRITTEN NOTICE OF ALL FINDINGS TO THE ARCHITECT
 LISTING ALL MALFUNCTIONS, FAULTY EQUIPMENT AND
- HEIGHTS SHALL BE VERIFIED WITH OWNER PRIOR TO INSTALLATION.
- THESE PLANS ARE DIAGRAMMATIC ONLY, FOLLOW AS CLOSELY AS POSSIBLE.
- EACH CONDUCTOR OF EVERY SYSTEM SHALL BE PERMANENTLY TAGGED IN EACH PANEL BOARD. PULLBOX, J-BOX, SWITCH BOX, ETC., IN COMPULANCE WITH UCCUPATIONAL SAFETY AND HEALTH ADMINISTRATION (O.S.H.A.)
- CONTRACTOR SHALL PROVIDE ALL LABOR, MATERIALS, INSURANCE, EQUIPMENT, INSTALLATION, CONSTRUCTION TOOLS, TRANSPORTATION, ETC. FOR A COMPLETE AND PRUPERLY OPERATIVE SYSTEM ENERGIZED THROUGHOUT AND AS INDICATED ON DRAWINGS, AS SPECIFIED HEREIN AND/OR AS OTHERWISE REQUIRED.
- 8. ALL MATERIALS AND EQUIPMENT SHALL BE NEW AND IN ALL MATERIALS AND EQUIPMENT SHALL BE NEW AND IN PERFECT CONDITION WHEN INSTAILED AND SHALL BE OF THE BEST GRADE AND OF THE SAME MANUFACTURER THROUGHOUT FOR EACH CLASS OR GROUP OF EQUIPMENT. MATERIALS SHALL BE LISTED "J" WHERE SUBJECT TO SUCH APPROVAL. MATERIALS SHALL MEET WITH APPROVAL OF THE DIVISION OF INDUSTRIAL SAFETY AND ALL GOVERNING BODIES HAVING JURISDICTION. MATERIALS SHALL BE MANUFACTURED IN ACCORDANCE WITH APPLICABLE STANDARDS ESTABLISHED BY ANSI, NEMA, NERLI AND "ILI" I I I STEP NBFU AND "UL" LISTED.
- CONTRACTOR SHALL PERFORM HIS WORK IN ACCORDANCE WITH ALL GOVERNING STATE, SBC, NEC, COUNTY AND LOCAL CODES AND O.S.H.A.
- 10. CONTRACTOR SHALL SECURE ALL NECESSARY BUILDING PERMITS AND PAY ALL REQUIRED FEES PURSUANT TO THE
- 11. COMPLETE JOB SHALL BE GUARANTEED FOR A PERIOD OF ONE (1) YEAR AFTER THE DATE OF JOB ACCEPTANCE BY OWNER. ANY WORK, MATERIAL OR EQUIPMENT FOUND TO BE FAULTY DURING THAT PERIOD SHALL BE CORRECTED AT ONCE, UPON WRITTEN NOTIFICATION, AT THE EXPENSE OF THE CONTRACTOR.
- 12. ALL CONDUIT SHALL HAVE A PULL WIRE OR ROPE.
- PROVIDE SDM WITH ONE SET ON COMPLETE ELECTRICAL "AS INSTALLED" DRAWINGS AT THE COMPLETION OF THE JOB, SHOWING ACTUAL DIMENSIONS, ROUTINGS, AND CIRCUITS.
- ALL BROCHURES, OPERATING MANUALS, CATALOGS, SHOP DRAWINGS, ETC. SHALL BE TURNED OVER TO SDM AT JOB COMPLETION.
- 15. USE T-TAP CONNECTIONS ON ALL MULTI-CIRCUITS WITH COMMON NEUTRAL CONDUCTOR FOR LIGHTING FIXTURE.
- 16. ALL CIRCUIT BREAKERS, FUSES AND ELECTRICAL EQUIPMENT SHALL HAVE AN INTERRUPTING SHORT CIRCUIT CURRENT TO WHICH THEY MAY BE SUBJECTED. AND A MINIMUM OF 10,000 A.I.C.
- GROUNDED AS REQUIRED BY SBC, NEC AND ALL APPLICABLE CODES.
- PATCH, REPAIR AND PAINT ANY AREA THAT HAS BEEN DAMAGED IN THE COURSE OF THE ELECTRICAL WORK.
- PENETRATIONS IN FIRE RATED WALLS SHALL BE FIRE STOPPED IN ACCORDANCE WITH APPLICABLE LOCAL BUILDING CODES.
- 20. RECEPTACLES SHALL BE 20 AMPERE, 125 VOLT A.C., HUDDELL #5362, WHITE. MOUNT ALL RECEPTACLES AT 18" A.F.F. OR AS REQUIRED BY THE SDM, OR APPROVED FOLLA
- WALL SWITCHES SHALL BE 15 AMPERE, 120 VOLT AC, SINGLE—POLE, HUBBELL #1201, WHITE OR AS REQUIRED BY THE SDM.
- 22. PLASTIC PLATES FOR ALL SWITCHES, RECEPTACLES, TELEPHONE AND BLANKED OUTLETS. SHALL HAVE ENGRAVED LETTERING WHERE INDICATED ON THE DRAWNGS.
 WEATHERPROOF RECEPTACLES SHALL HAVE SIERRA #WPD-8 LIFT COVERPLATES.
- 23. WIRE AND CABLE CONDUCTORS SHALL BE COPPER, 600V, TYPE THHN OR THWN, WITH A MINIMUM SIZE OF #12 AWG, COLOR CODES. ALL RECTRIFER PORPS SHALL BE STRANDED TO ACCEPT CRIMP CONNECTORS.
- 24. GROUNDING CONDUCTORS SHALL BE SOLID TINNED COPPER AND ANNEALED #2.
- 25. ALL CONDUCTORS SHALL BE COPPER
- 26. ALL MATERIALS SHALL BE "UL" APPROVED.
- 27. METER SOCKET AMPERES, VOLTAGE, NUMBER OF PHASES STALL DE AS NOTED ON THE DRAWINGS. MANUFACTURED BY SQUARF "D" COMPANY OR APPROVED EQUAL.
- 28. CONDUIT:
- A.RIGID CONDUIT SHALL BE U.L. LABEL GALVANIZED ZING COATED WITH ZING INTERIOR AND SHALL BE USED WHEN INSTALLED IN OR UNDER CONCRETE SLABS, IN CONTACT WITH THE EARTH, UNDER PUBLIC ROADWAYS, IN MASONRY WALLS OR EXPOSED ON BUILDING EXTERIOR. RIGID CONDUIT IN CONTACT WITH EARTH SHALL BE 1/2 LAPPED WRAPPED WITH HUNTS WRAP PROCESS NO. 3.
- B ELECTRICAL METALLIC TUBING SHALL HAVE U.L. LISTED LABEL, FITTING SHALL BE GLAND RING COMPRESSION TYPE. EMT SHALL BE USED ONLY FOR INTERIOR RUNS.

- C.FLEXIBLE METALLIC CONDUIT SHALL HAVE U.L.
 LISTED LABEL AND MAY BE USED WHERE PERMITTED BY
 CODE. FITTINGS SHALL BE "JAKE" OR "SQUEEZE"
 TYPE, SEAL TIGHT FLEXIBLE CONDUIT. ALL CONDUIT
 IN EXCESS OF SIX FEET IN LENGTH SHALL HAVE FULL
 SIZE GENUINT—WARE
- CONDUIT RUNN MAY BE SURFACE MOUNTED IN CELLING OR WALLS UNLESS INDICATED OTHERWISE. CONDUIT INDICATED SHALL RUN PARALLEL OR AT RIGHT ANGLES TO CEILING, FLOOR OR BEAMS. VERIFY EXACT ROUTING OF ALL EXPOSED CONDUIT WITH ARCHITECT
- E.ALL ALARMS SHALL BE (2) #22 AWG AND BE RUN FROM EACH OF THE ITEMS AS INDICATED ON DRAWINGS. THE ALARM WIRES SHALL HAVE AN ADDITIONAL LENGTH REACHING TO THE FLOOR, TAGGED AND LABELED WITH HE APPROPHIAL E. ALARM IHLM. ALL CONTACTS WILL BE NORMALLY CLOSED, DRY AND ISOLATED FROM GROUND. ALARM WILL BE NEATLY RUN AND SECURED EVERY THREE FEET TO WALLS AND EXISTING CABLE TRAY.
- 29. CONTRACTOR TO COORDINATE WITH UTILITY COMPANY FOR CONNECTION OF TEMPORARY AND PERMANENT POWER TO THE SITE. THE TEMPORARY POWER AND ALL HOOKUP COSTS TO BE PAID BY CONTRACTOR.
- 30. ALL ELECTRICAL EQUIPMENT SHALL BE LABELED WITH PERMANENT ENGRAVED PLASTIC LABELS.
- 31. UPON COMPLETION OF WORK, CONDUCT CONTINUITY, SHORT CIRCUIT, AND FALL POTENTIAL GROUNDING TESTS FOR APPROVAL. SUBMIT TEST REPORTS TO SDM. CLEAN PREMISES OF ALL DEBRIS RESULTING FROM WORK AND LEAVE WORK IN A COMPLETE AND LINDAMAGED CONDITION
- 32. GROUNDING ELECTRODE SYSTEM
 - A. PREPARATION

1 SURFACE PREPARATION:

ALL CONNECTIONS SHALL BE MADE TO BARE METAL.
ALL PAINTED SURFACES SHALL BE FIELD INSPECTED
TO ENSURE PROPER CONTACT. NO WASHERS ARE
ALLOWED BETWEEN THE ITEMS BEING GROUNDED. ALL
CONNECTIONS ARE TO HAVE A NON-OXIDIZING AGENT
APPLIED PRIOR TO INSTALLATION.

2. GROUND BAR PREPARATION: ALL COPPER GROUND BARS SHALL BE CLEANED, POLISHED AND A NON-OXIDIZING AGENT APPLIED. NO FINGERPRINTS OR DISCOLORED COPPER WILL BE

ALL GROUNDING CONDUCTORS SHALL RUN THROUGH PVC SLEEVES WHEREVER CONDUCTORS RUN THROUGH WALLS, FLOORS OR CELLINGS. IF CONDUCTORS MUST RUN THROUGH EMT, BOTH ENDS OF CONDUIT SHALL BE GROUNDED, SEAL BOTH ENDS OF CONDUIT WITH SILICONE CAULK.

B.GROUND BARS

1. ALL INTERIOR NON-ELECTRICAL MATERIALS, I.E.
HVAC GRILLES, HOLLOW METAL DOOR FRAMES/DOORS,
CABLE TRAYS, TELCO ENTRANCE CONDUIT (EMT
ONLY), ETC. SHALL BE GROUNDED WITH 6 GREEN
CROUND WIRES OR JUMPERS WITH SINCLE HOME RUNS
BACK TO THE MASTER GROUND BAR (THE CABLE
TRAY, DOOR/FRAME AND STEEL CHANNEL MAY BE
JUMPED LOGE-HER AND HAVE A SINGLE GROUND WIRE
CONNECTION TO THE MASTER GROUND BAR). ALL
PAINT OR DEI FIFFICIUS MATERIAL SHAIL BE
REMOVED AT THE POINT OF ATTACHMENT OF ALL
GROUND JUMPERS, ALL SINGLE LUG CONNECTORS
MUST BE BOLT-THRU USING STAR AND LOCK
WASHERS, DOUBLE LUG CONNECTORS MAY BE
SCREWED WITH START WASHERS.

- 1.ALL GROUNDING CONNECTIONS SHALL BE MADE BY IHL "CADWELD" PROCESS. CONNECTIONS SHALL INCLUDE ALL CABLE TO CABLE. SPLICES, TEL'S X'S FTC. ALL CABLE TO GROUND RODS, GROUND ROD SPLICES AND LIGHTNING PROTECTION SYSTEM AS INDICATED. ALL MATERIALS USED (MOLDS, WELDING METAL, TOOLS, ETC.) SHALL BE BY "CADWELD" AND INSTALLED PER MANUFACTURER'S DECOMMENDATIONS AND DOCCEMENTAL SHALL BE BY "CADWELD" AND INSTALLED PER MANUFACTURER'S DECOMMENDATIONS AND DOCCEMENT. RECOMMENDATIONS AND PROCEDURES.
- 2.ALL GROUNDING AND BONDING CONDUCTORS SHALL BE CONNECTED BY TWO HOLES GRIMP TYPE
 (COMPRESSION) CONNECTIONS (EXCEPT FOR THE
 ACEG AND GROUND ROD) MECHANICAL CONNECTIONS,
 HITING OR CONNECTIONS HAT DEPEND SOLELY ON
 SOLDER SHALL NOT BE USED.
- 3.INTERIOR WAVEGUIDE PORT SHALL BE GROUNDED TO THE INTERIOR MASTER GROUND BAR LOCATED BELOW THE WAVEGUIDE ENTRY PORT, WITH 6 SOLD WRE. THESE CONNECTIONS SHALL BE DOUBLE LUG-BOLTED,

ALL GROUND CABLES SHALL BE STANDARD TIND SOLID BARE COPPER AND OF SIZE INDICATED ON DRAWINGS UNLESS INDICATED OTHERWISE

LUGS SHALL BE 2-HOLE, SHORT BARREL, STRAND COPPER UNLESS OTHERWISE SPECIFIED IN THIS DOCUMENT. LUGS SHALL BE THOMAS AND BETTS SERIES 548 BE OR EQUIVALENT.

535 MCM DLO 262 MCM DLO #1/0 DLO #4/0 THWN AND BARE #2/0 THWN #2 THHN #6 DLO

54872BE 54862BE 54866BE 54862BE 54207BE 54205BE

2. WHEN THE DIRECTION OF THE CONDUCTOR MUST CHANGE, IT SHALL BE DONE GRADUALLY. THE CURVATURE OF THE TURN SHALL BE DONE IN ACCORDANCE WITH THE FOLLOWING CHART:

GROUND CONDUCTOR SIZE

NO. 6 AWG TO NO. 4 AWG NO. 2 AWG TO NO., 1/0 AWG NO. 2/0 AWG TO 750 MCM 8 INCHES 1 FOOT NO RESTRICTIONS

33. ASTM FALL POTENTIAL TESTS

1. FOR TENANT IMPROVEMENT SITES, TESTING CAN BE DONE USING THE AEMC MODEL #3700 TESTER TEST THE INTERACE BETWEEN THE ANTENNA GROUNDING CONDUITS AND BUILDING STEEL, THE SITE GROUND BUSS CONDUCTOR AND BUILDING STEEL, AND THE CONDUICTOR BETWEEN THE MASTER GROUND BAR (MGB)

COAXIAL CABLE

3-1.01 GENERAL

- ALL MATERIALS, PRODUCTS OR PROCEDURES INCORPORATED INTO WORK SHALL BE NEW AND OF STANDARD COMMERCIAL QUALITY.
- B CERTAIN MATERIALS AND PRODUCTS WILL BE SUPPLIED BY CERTIAIN MATERIALS AND PRODUCTS WILL BE SUPPLIED BY INCENTED COMMUNICATIONS (REFER TO THE INDEX FOR THE "LIST OF NEXTEL COMMUNICATIONS TURNISHED EQUIPMENT, MATERIALS AND SUPPLIES" FOR THESE ITEMS). THE CONTRACTOR IS RESPONSIBLE FOR PICK-UP AND DELIVERY TO SITE ALL NEXTEL COMMUNICATIONS FURNISHED MATERIALS.
- ALL OTHER MATERIALS AND PRODUCTS SHOWN IN THE SPECIFICATIONS SKETCHES, DRAWINGS, GENERAL CONTRACT DOCUMENTS, ADDENDUMS, AMENDMENTS AND/OR INSTRUCTION SHALL BE SUPPLIED BY THE CONTRACTOR.

ANTENNAS:

INSTALLATION OF ANTENNAS AND ASSOCIATED MOUNTINGS SHALL USE HARDWARE PER MANUFACTURES RECOMMENDED STANDARDS OF PRACTICE.

INSTALLATION OF COAXIAL CABLE AND TERMINATIONS BETWEEN INSTALLATION OF COMANEL AGREE AND TEACHMINIATIONS BETWEEN ANTENNAS AND EQUIPMENT ROOM, ELECTRONICS PER MANUFACTURE RECOMMENDED STANDARDS OF PRACTICE. ALL COUNCECTORS BETWEEN THE ANTENNA AND EQUIPMENT SPACE ENTRY PORT SHALL BE WEATHER PROOFER WITH A WEATHER PROOFING WITH A WEATHER PROOFING WITH A WEATHER PROOFING WITH A WEATHER PROOFING AND ANTENDED BY THE CONTRACTOR ALL COOK TO TERMINATE ONE FOOT INSIDE CONFINENT SPACE OR DUILDING UNLESS OTHERWISE STATED.

- 1 CARLE SPECIFICATION:
 - A. 15/8" DIA COAXIAL CABLE ANDREW LDF 7-50A B. 11/4" DIA COAXIAL CABLE ANDREW LDF 6-60 C. 7/8" DIA COAXIAL CABLE ANDREW LDF 5-50 D. 1/2" DIA COAXIAL CABLE ANDREW LDF 4-75A
- 2. HOISTING GRIP
- A. FOR 1 5/8" DIA COAXIAL CABLE USE ANDREW 24312A B. FOR 1/1/4" DIA COAXIAL CABLE - USE ANDREW 19961 FOR 7/8" DIA COAXIAL CABLE - USE ANDREW 19256B
- D. FOR 1/2" DIA COAXIAL CABLE USE ANDREW 43094
- 3-202 ANTENNA AND COAXIAL CABLE GROUNDING
- A. IHE DIRECTIONAL ANTENNA COAX CABLES ARE TO HAVE AS A MINIMUM OF TWO GROUND KITS INSTALLED, ONE AT THE ANTENNA JUMPER CONNECTION AND ONE AT THE WAVEGUIDE ENTRY PORT
- B. ALL EXTERIOR #6 GREEN GROUND WIRE DAISY CHAIN CONNECTIONS ARE TO BE WEATHER SEALED WITH ANDREWS CONNECTOR/SPLICE WEATHERPROOFING KIT TYPE #221213 OR
- C. ALL COAXIAL CABLE GROUNDING KITS ARE TO BE INSTALLED ON STRAIGHT RUNS (NOT WITHIN BENDS) OF COAX CABLE.
 - FOR 1 5/8" DIA COAXIAL CABLE USE ANDREW 241088—4 FOR 1 1/4" DIA COAXIAL CABLE USE ANDREW 241088—3 FOR 7/8" DIA COAXIAL CABLE USE ANDREW 241088—2 FOR 1/2" DIA COAXIAL CABLE USE ANDREW 241088—2
- A. TO PROVIDE EASY IDENTIFICATION AND UNIFORM MARKING OF ANTENNA CABLING, THE FOLLOWING SHALL APPLY:
 - LOCATION: MARKINGS SHALL DE MADE DY USE OF 3M COLORFD, 1—INCH WIDE TAPE AFFIXED AT THREE PLACES ON THE COAX CABLE RUN AS FOLLOWS:
 - a. FIRST LOCATION IS AT THE END OF THE COAX NEAREST THE ANTENNA (WHERE THE COAXIAL CABLE AND JUMPER ARE CONNECTED).
 - b. SECOND, AT A POINT OUTSIDE THE WAVEGUIDE ENTRY PRIOR ENTERING THE BUILDING
 - c. THIRD, INSIDE THE EQUIPMENT SPACE, AT A POINT ON THE COAXIAL CABLE, APPROXIMATELY 10 INCHES FROM THE WAVEGUIDE ENTRY PORT.
 - SECTOR IDENTIFICATION: NORMALLY A SITE WILL HAVE UP TO THREE SECTORS. SECTORS SHALL BE DESIGNATED BY NUMBERING CACH IN A CLOCKWISE MANNER. THE FIRST SECTOR IS THE ONE CLOSEST TO (MEASURING CLOCKWISE) ZERO DECREES (TRUE, NORTH). THE SECOND AND IHIND FOLLOW CLOCKWISE IN SEQUENCE. THEREFORE, THE MARKING OF ANTENNA CABLING IS AS FOLLOWS.
 - a SECTOR #1 COAXIAL CARLE WILL HAVE ONE BAND OF A . SECTOR #1 COAXIAL CABLE WILL HAVE ONE BAIND OF PRE-SELECTED COLORED TAPE (REFER TO 3-204) FOR EACH COAXIAL RUN. NORMALLY SITES WILL INITIALLY GO ON THE AIR WITH AS FEW AS TWO ANTENNAS PER SECTOR AND AS THE SYSTEM GROWS, AN ADDITIONAL ONE TO TWO ANTENNAS MAY BE ADDED.
 - c. SECTOR #3 COAXIAL CABLE WILL HAVE THREE BANDS

A COLOR CODE

THE RULE IS TO FACE THE SECTOR UNDER OBSERVATION WHEN DETERMINING THE POSITIONING OF THE COAXIAL CABLE RUN AND ANTENNA ON THE BUILDING STRUCTURE.

- RED IS THE DESIGNATED COLOR TAPE TO BE AFFIXED TO THE COAXIAL CABLE FOR THE MUN (ANTENNA) AT THE EXTREME LEFT.
- GREEN IS THE DESIGNATED COLOR TAPE TO BE AFFIXED TO THE COAXIAL CABLE FOR THE RUN (ANTENNA) AT THE EXTREME RIGHT. AS A MEMORY AID, WHEN FACING (LOOKING) AT THE SPECIFIC SECTOR, THE LEFT HAND SIDE (RED) AND RIGHT HAND SIDE (GREEN) CORRESPONDS TO THE MARTIME "GREEN" FOR STATBOARD AND "RED" FOR PORTSIDE. THESE TWO COLORS DENOTE THE ANTENNAS AND COAXIAL CABLE AT THE EXTREME ENDS OF THE BUILDING STRUCTURE.
- BLUE IS THE DESIGNATED COLOR TAPE TO BE AFFIXED TO THE COAXIAL CABLE FOR THE THIRD ANTENNA/COAXIAL CABLE RUN AND ANTENNA/COAXIAL CABLE RUN AND ANTENNA (MIDDLE). AS A MEMORY AID, RIN THE COAXIAL CABLE COLOPS WITH THE FLAG IN MIND, RED, GREEN AND BLUE. THIS WILL ASSIST IN REMEMBERING THE COLORS FOR THE TWO INSIDE COAXIAL CABLE (ANTENNA).

- 3. TWO BANDS OF BLUE TAPE DESIGNATE SECTOR TWO, FOR THE THIRD ANTENNA/COAXIAL CABLE RUN (MIDDLE).
- TRIPLE BANDS OF RED, CREEN, AND BILIE TAPE DESIGNATES SECTOR THREE (FRMEMBER THE RULE IS TO FACE THE SECTOR UNDER OBSERVATION RED IS EXTREME LEFT, GREEN IS EXTREME RIGHT AND BLUE IS MIDDLE).

3-206 TESTING:

PROVIDE FOUR (4) SETS OF SWEEP TEST AND T.D.R. TEST RESULTS TO THE SDM. SWEEP TESTS SHALL BE AS PER ATTACHED ANDREW "MINIMUM FIELD TESTING RECOMMENDED FOR ANTENNA AND HELIAX COAXIAL CABLE SYSTEMS" DATE 10-5-93. DOCUMENTS ARE TO BE BOUND AND SUBMITTED WITHIN ONE WEEK OF WORK COMPLETION.

3-207 COAXIAL CABLE LIGHTNING SURGE PROTECTION

- A. INSTALLATION AND GROUNDING OF THE FOLLOWING OWNER FURNISHED CONTRACTOR INSTALLED MATERIAL:
 - ONE POLY-PHASER (REFERENCED ATTACHED CATALOG CUT)
 PER TRANSMISSION CABLE RUN.
- ONE TRI-LEVEL POLY-PHASER TRAPEZE HANGING ASSEMBLY (KIT TO BE ASSEMBLED).

THE POLY PHASER AND ASSOCIATED TRAPEZE HANGING ASSEMBLY SHOULD BE MOUNTED 1'-0' INSIDE THE WAYEQUIDE ENTRY PORT AT 2-0' AFF. A MINIMUM #6 GROUND WIRE SHOULD BE RUN FROM EACH LEVEL OF THE TRAPEZE HANGING ASSEMBLY TO THE MAIN GROUND DUSS BAR.



6700 N. ANDREWS AVENUE SUITE 700 FT. LAUDERDALE, FLORIDA 33309 (954) 275-2400



Kimley-Horn and Associates, Inc. C) 1998 KIMLEY-HORN AND ASSOCIATES, INC.

BARCADERO DRIVE, WEST PALM BEACH, FL 33407 PHONE: (561) 845 0865

REGISTRATION NUMBERS

KIMLEY HORN & ASSOCS.. INC. FROCOCO PE 31180 DAVID STEWART CHARLES GEER PE 31435 KIRK DROST PE 51910 RUSSELL MORRISON PE 51567

SEAL

REVISIONS NO. DATE DESCRIPTION

> PROJECT MANAGER ___ DATE NEXTEL RF: . DATE: PROPERTY OWNER __

ANTENNA INSTALLATION AT WINSTON PARK SITE NUMBER: FL 3672A

SCALE: AS SHOWN DESIGNED BY: JBC DRAWN BY: AJD APPROVED BY: DGW DATE: MAY 2001

KHA PROJECT NUMBER 044201071 DRAWING NUMBER G-2SHEET TITLE

GENERAL NOTES #2

SHEET NUMBER

OF

04201071
C-2-dwg
MAY 2001
**"-1"
challenge of the concepts and designs presented her instrument of service, is intended only for the specific purpose and cl which it was prepared. Reuse of and improper reliance on this docum without written authorization and adoptation by Kimley-Horn and Association, each all one without tibelity to kimley-Horn and Association, each all one without tibelity to kimley-Horn and Association.

C & W engineering

(407) 642-5333

ELECTRICAL CONSULTANTS 2326 S. CONGRESS AVE., 2E, WPB, FL. 33406

4

STRUCTURAL STEEL FRAMING MEMBERS, BASE PLATES, PLATES, BARS

AND GROUTING UNDER BASE PLATES. SUBMITTALS:

SHOP DRAWINGS: INDICATE SIZES, SPACING, AND LOCATIONS OF STRUCTURAL MEMBERS, OPENINGS, CONNECTIONS, CAMBERS, LOADS, AND WELDED SECTIONS.

3 QUALITY ASSURANCE

- A. FABRICATE STRUCTURAL STEEL MEMBERS IN ACCORDANCE WITH AISC SPECIFICATIONS FOR THE DESIGN, FABRICATION AND ERECTION OF STRUCTURAL STEEL FOR BUILDINGS.
- B. PERFORM DESIGN UNDER DIRECT SUPERVISION OF A PROFESSIONAL STRUCTURAL ENGINEER LICENSED IN THE STATE.

PART 2 - PRODUCTS

1. MATERIALS:

STRUCTURAL STEEL MEMBERS: ASTM A36
STRUCTURAL TUBING: ASTM A501, GRADE B
PIPE: ASTM A533, TYPE E OR S, GRADE B

GALVANIZING
BOLTS, NUTS AND WASHERS
ANCHOR BOLTS
WELDING MATERIALS
GROUT

ASTM A53, TYPE E OR S, GRADE B
ASTM A36
ASTM A326
ASTM A325
ASTM A327
AWS D1.1, TYPE REQUIRED FOR MATERIALS BEING WELDED
NON-SHRINK TYPE, PREMIXED COMPOUND CONSISTING OF
NONMETALLIC AGGREGATE, CEMENT, WATER REDUCING
AND PLASTICIZING ADDITIVES, CAPABLE OF DEVELOPING
A MINIMUM COMPRESSIVE STRENGTH OF 7000 PSI AT 28
DAYS.

I. SHOP AND TOUCH-UP PRIMER
J. TOUCH-UP PRIMER FOR GALV. SPC 15, TYPE 1, RED OXIDE ZINC RICH TYPE SURFACES

FABRICATION

CONTINUOUSLY SEAL JOINTED MEMBERS BY CONTINUOUS WEIDS.
GRIND EXPOSED WELDS SMOOTH.

FINISH

- A. PREPARE STRUCTURAL COMPONENT SURFACES IN ACCORDANCE WITH SSPC SP-1 TO SP-10 PROCEDURES.
- B. SHOP PRIME STRUCTURAL STEEL MEMBERS. DO NOT PRIME SURFACES THAT WILL BE FIELD WELDED, IN CONTACT WITH CONCRETE, OR HIGH STRENGTH BOLTED.

1. EXAMINATION AND PREPARATION

VERIFY THAT THE FIELD CONDITIONS ARE ACCEPTABLE

ERECTION

- A. ALLOW FOR ERECTION LOADS. PROVIDE TEMPORARY BRACING TO MAINTAIN FRAMING IN ALIGNMENT UNTIL COMPLETION OF ERECTION AND INSTALLATION OF PERMANENT BRIDGING AND BRACING.
- B. FIELD WELD COMPONENTS INDICATED ON SHOP DRAWINGS.
- C. DO NOT FIELD CUT OR ALTER STRUCTURAL MEMBERS WITHOUT APPROVAL OF THE ARCHITECT/ENGINEER.
- D. AFTER ERECTION, PRIME WELDS, ABRASIONS, AND SURFACES NOT SHOP PRIMED OR GALVANIZED EXCEPT SURFACES TO BE IN CONTACT WITH CONCRETE.
- 3. FIELD QUALITY CONTROL

FIELD INSPECTION OF MEMBERS, CONNECTIONS, WELDS AND TORQUING.

SCOPE

- A. GENERAL WELDING REQUIREMENTS FOR ALL PORTIONS OF THE PROJECT (FIELD & SHOP).
- B. SECTION COVERING PARTS OF THE PROJECT THAT REQUIRE WELDING, WELDING CODES, WELDING DOCUMENTATION, WELDING INSPECTION & NONDESTRUCTIVE TESTING REQUIREMENTS.
- SUBMITTALS
 - A. THE FOLLOWING SPECIFIC INFORMATION SHALL BE PROVIDED BY THE CONTRACTOR
 - WELDING PROCEDURE: CONTRACTOR SHALL SUBMIT ALL SHOP AND FIELD WELDING PROCEDURE SPECIFICATIONS AND SUPPORTING WELDING PROCEDURE QUALIFICATION RECORDS FOR REVIEW PRIOR TO ANY WELDING. WELDING DOCUMENTATION SHALL BE SUBMITTED ON APPROPRIATE FORMS FOUND IN THE APPENDIXES TO THE REFERENCED WELDING CODES.
 - 2. WELDER/WELDING OPERATOR QUALIFICATIONS: THE CONTRACTOR WEIDER, WELDING OPERATOR OUALIFICATIONS: THE CONTRACTOR SHALL SUBMIT ALL SHOP AND FIELD WEIDER OR WELDING OPERATOR PERFORMANCE QUALIFICATION RECORDS PRIOR TO ANY WELDING. WELDING DOCUMENTATION SHALL BE SUBMITTED ON APPROPRIATE FORMS FOUND IN THE APPENDIXES OF REFERENCED WELDING CODES.
 - WELDING INSPECTOR CREDENTIALS: IF SPECIFIED TO PROVIDE ON SITE WELDING INSPECTION. THE CONTRACTOR SHALL SUBMIT THE CREDENTIALS OF THE WELDING INSPECTOR TO BE EMPLOYED BY THE CONTRACTOR FOR REVIEW BY THE CONSTRUCTION BY THE CONTRACTOR FOR REVIEW BY THE CONSTRUCTION MANAGER PION TO STARTING ANY WELDING. THE GREDENTIALS SHALL INCLUDE, BLIT NOT BE LIMITED TO, AMERICAN WFI DING SOCIETY QCL CERTIFICATION. THE WELDING INSPECTOR SHALL HAVE PRIOR INSPECTION EXPERIENCE WITH ALL APPLICABLE WELDING CODES. THE WELDING COSPOSES THE WELDING CODES. THE WELDING COSPOSE SHALL INCLUDE, BUT NOT BE LIMITED TO, THE WELDING INSPECTOR SHALL INCLUDE, BUT NOT BE LIMITED TO, THE FOLLOWING:
 - VERIFYING JOB MATERIAL AND STORAGE MONITOR CONFORMANCE WITH APPROVED WELDING PROCEDURE SPECIFICATIONS
 - FRUCEDURE SPECIFICATIONS
 CHECK WELDING AND WELDING OPERATOR QUALIFICATION
 SUPERVISE NONDESTRUCTIVE TESTING PERSONNEL AND
 FVALUATION OF TEST RESULTS
 MAINTAIN RECORDS AND PREPARE REPORTS

- TESTING ACENCY CREDENTIALS: THE CONTRACTOR SHALL RETAIN A QUALIFIED TESTING ACENCY EMPLOYING PERSONNEL EXPERIENCED IN NONDESTRUCTIVE TESTING. THE TESTING ACENCY-SHALE PERFORM "RADIOGRAPHY"—ULTRASONIC," MAGNETIC—PARTICLE, LIQUID PENETRANT, AND OTHER TESTING METHODS AS SPECIED PERSONNEL EMPLOYED BY THE TESTING AGENCY SHALL BE CERTIFIED IN ACCORDANCE WITH THE CURRENT AMERICAN SOCIETY OF NON DESTRUCTIVE TESTING (4153 ARLINGATE PLAZA, COLUMBUS, OH 43228) RECOMMENDED PRACTICE NO. SNT—TC-14 AND ALL SUPPLEMENTS, NOT LEVEL II. THE CONTRACTOR SHALL SUBMIT THE CREDENTIALS OF THE TESTING AGENCY AND PERSONNEL FOR REVIEW BY THE CONSTRUCTION MANAGER PRIOR TO ANY WELDING.
- 5. NONDESTRUCTIVE TESTING PROCEDURE SPECIFICATIONS: THE CONTRACTOR SHALL SUBMIT ALL NONDESTRUCTIVE TESTING PROCEDURE SPECIFICATIONS FOR REVIEW BY THE CONSTRUCTION MANAGER PRIOR TO ANY WELDING.

PART 2 - EXECUTION

GENERAL

- 2. NONDESTRUCTIVE WELD TESTING REQUIREMENTS
 - A. ALL WELDS
 - PERFORM NONDESTRUCTIVE TESTING OF WELDS AS FOLLOWS:
 - O. 10 PERCENT OF THE BUTT JOINT WELDS SHALL BE RANDOMLY RADIOGRAPHICALLY TESTED AND REPAIRED IN ACCORDANCE WITH THE REFERENCED WELDING CODES. SELECTION OF THE WELDS TO BE TESTED SHALL BE AS AGREED UPON BETWEEN THE CONSTRUCTION MANAGER AND THE CONTRACTOR.
 - b. GROOVE WELDS SHALL BE 100 PERCENT ULTRASONICALLY TESTED AND REPAIRED IN ACCORDANCE WITH THE REFERENCE WELDING CODES. SELECTION OF THE WELDS TO BE TESTED SHALL BE AS AGREED JUPON BETWEEN THE CONSTRUCTION MANAGER AND THE CONTRACTOR.
 - c. FILLET WELDS, SHALL BE 10 PERCENT RANDOMLY EXAMINED USING EITHER DYE PENETRANT OR MAGNETIC PARTICLE INSPECTION METHODS.
 - d. ALL WELDS SHALL BE VISUALLY INSPECTED IN ACCORDANCE WITH ANSI/AWS D1.1-92, PARAGRAPH 8.15.1.
 - UNLESS OTHERWISE SPECIFIED, ALL NONDESTRUCTIVE TESTING SHALL BE PERFORMED IN ACCORDANCE WITH CHAPTER 6 OF ANS/AWS DI.1—92 AND THE FOLLOWING, THE STANDARDS FOR RADIOGRAPHIC ACCEPTANCE SHALL BE IN ACCORDANCE WITH ANS/AWS DI.1, PARAGRAPH 8.15.3. THE STANDARDS FOR ULTRASONIC ACCEPTANCE SHALL BE CLASS B INDICATIONS IN ACCORDANCE WITH ANS/AWS DI.7, PARAGRAPH 8.15.4 THE STANDARDS OF ACCEPTANCE FOR BOTH DYE PENETRANT AND MAGNETIC PARTICLE INSPECTION METHODS SHALL BE IN ACCORDANCE WITH ANS/AWS DI.1—92, VISUAL INSPECTION, PARAGRAPH 8.15.5.
 - 3. WELD DEFECTS REPAIR
 - A. REJECTED WELDS SHALL BE REPAIRED AND RETESTED UNTIL SOUND WELD METAL HAS BEEN DEPOSITED IN ACCORDANCE WITH APPROPRIATE WELDING CODES. THE CONTRACTOR SHALL BEAR ALL COSTS FOR WELD REPAIR AND SUBSEQUENT RETESTING.

TELCO SERVICE

- APPLICATION FOR TELEPHONE SERVICE WILL BE MADE BY THE SDM.
 THE CONTRACTOR IS RESPONSIBLE FOR PROVIDING ALL MATERIALS
 AND ASSOCIATED LABOR FOR CONNECTION FROM THE TELCO SOURCE TO
 THE SHELTER AS PER THE CONSTRUCTION PLANS.
- PROVIDE A 2 INCH DIAMETER SCHEDULE 40 PVC PIPE FROM THE EQUIPMENT SPACE TELOO ENTRY TO A LOCATION INDICATED ON THE CONSTRUCTION PLANS. PLUG OR CAP EACH END OF THE PIPE AND PROVIDE TWO SEPARATE PULL STRINGS, SECURELY FASTENED AT EACH END OF THE PIPE. PULL STRINGS SHALL BE 200 LB TEST POLYETHYLENE CORD.
- PROVIDE TWO (2) POTS LINES, LOCATION AS DIRECTED BY NEXTEL SDM WILL INDICATE TELEPHONE SERVICES AND COORDINATE INSTALLATION OF TWO (2) POTS LINES TO TELCO BOARD.

SPECIAL CONSTRUCTIONS

1. SECTION INCLUDES

CABLE LADDER AND ACCESSORIES REQUIRED TO COMPLETE INSTALLATION.

2. UNIT PRICES

CONTRACTOR SHALL PROVIDE A PRICE FOR ADDITIONAL CABLE LADDER ON A "PER LINEAR FOOT" BASIS IN HIS BID

A. ALL CABLE LADDERS AND PORTIONS OF THEIR ASSEMBLIES SHALL BE CONSTRUCTED OF ROLL FORMED STEEL TO SUPPORT A CONCENTRATED LOAD OF 200 LBS WITH NO PERMANENT DEFORMATION.

SUBMITTALS

A. CONTRACTOR SHALL SUBMIT SHOP DRAWINGS FOR EACH
COMPONENT OF THE ASSEMBLY TO THE NEXTEL PROJECT MANAGER
FOR APPROVAL PRIOR TO CONSTRUCTION OF CABLE LADDER
ASSEMBLY.

5. DELIVERY, STORAGE AND HANDLING

A. TRANSPORT, HANDLE AND STORE ON—SITE ALL MATERIALS USED IN CONSTRUCTING CABLE LADDER ASSEMBLY IN SUCH A MANNER AS TO PROTECT THE MATERIAL AND THE ORIGINAL FINISHES ROM DAMAGE. NO DAMAGED MATERIAL WILL BE ACCEPTED MANUFACTURERS

SUBJECT TO COMPLIANCE WITH REQUIREMENTS PROVIDE
 PRODUCTS BY ONE OF THE FOLLOWING MANUFACTURERS:

1. CENTRAL STEEL FABRICATORS, INC. (708) 236-8725 2. NEWTON INSTRUMENTS (919) 575-6426 3. SAUNDERS BROS. (310) 945-1038 4. OWNER APPROVED EQUAL

7. MATERIALS

A. CABLE LADDERS; (SPECIFIED BY NEXTEL) INSTALL 12' WIDE CABLE LADDERS AS INDICATED ON THE TOWER DRAWINGS.

1. CONSTRUCTION: IUBULAR SIDE BAR 1-1/2" HIGH X 3/8"
WOE WITH CHAINEL TYPE RUNCS - 5" O.C.

2. FINISH: TELEPHONE COUPMENT GRAY.

B. THREADED ROD:

1. CONSTRUCTION: 5/6"- 11 STEEL THREADED RODS LENGTH
TO FIT APPLICATION
2. FINISH: ZINC PLATED.

WALL INSULATORS:
 1. UL 94 V-1, 1-1/2" X 3/8" THICK

D. THREADED ROD INSULATORS:
1. MOLDED POLYESTER — FIBERGLASS INSULATOR
2. COLOR: RED

E. ACCESSORIES: INSTALL ALL ACCESSORIES AND PARTS
REQUIRED FOR A COMPLETE INSTALLATION. PARTS INCLUDE
END SUPPORTS, EXTENSION CLAMPS, WALL CLAMPS, JUNCTION
KITS, HANGER KITS, ROD CAPS, TERMINATION BARS, NUTS,
LOCK WASHERS, FLAT WASHERS, FRAMING CLIP. J-BOLTS, CORNER BRACKLIS FINISH: ZINC PLATED

8. INSTALLATION

A. VERIFY THAT BUILDING FRAMING COMPONENTS ARE READY TO RECEIVE WORK.

B. ALL INSTALLATIONS SHALL BE PER MANUFACTURERS
RECOMMENDATIONS

C. INSTALL THREADED ROD SUPPORT AT NO MORE THAN 5'-0" O.C. SECURELY INTO CEILING STRUCTURE.

D. INSTALL THREADED ROD INSULATORS

E. ALIGN THREADED ROD IN STRAIGHT ROWS.

F. INSTALL CABLE TRAY USING 'C' CLAMPS AT A CONSISTENT HEIGHT AS SPECIFIED IN THE DRAWINGS. G. LEVEL ALL CABLE LADDER TO THE HEIGHT SPECIFIED ON THE DRAWINGS.

RESEAL ANY DAMAGED FINISHES AND PAINT TO MATCH EXISTING CONDITIONS.



6700 N. ANDREWS AVENUE SUITE 700 FT. LAUDERDALE, FLORIDA 33309 (954) 275-2400



Kimley-Horn and Associates, Inc. (C) 1998 KIMLEY-HORN AND ASSOCIATES, INC.

4431 EMBARCADERO DRIVE, WEST PALM BEACH, FL 33407 PHONE: (501) 845 0665

REGISTRATION NUMBERS KIMLEY HORN & ASSOCS., INC. FB0000696 PE 31180 CHARLES GEER

KIRK DROST

PE 31435 PE 51910 RUSSELL MORRISON PE 51567

> Alv SEAL MAY 3 0 2001

REVISIONS NO. DATE DESCRIPTION

APPR	OVALS
PROJECT MANAGER	DATE:
NEXTEL RF:	DATE:
PROPERTY OWNER	DATE:

ANTENNA INSTALLATION AT WINSTON PARK SITE NUMBER: FL 3672A

SCALF: AS SHOWN DESIGNED BY: JBC DRAWN BY: AJD APPROVED BY: DWS DATE: MAY 2001

KHA PROJECT NUMBER 044201071 DRAWING NUMBER G-3SHEET TITLE


GENERAL NOTES #3

OF


5

17

044201071
This document, together with the concepts and designs presented herein, us an instrument of service, is intended only for the specific purpose and client for which it was prepared. Reuse of and Improper relance on this document without written outhor/station and adoptation by Kimley-Horn and Associates,

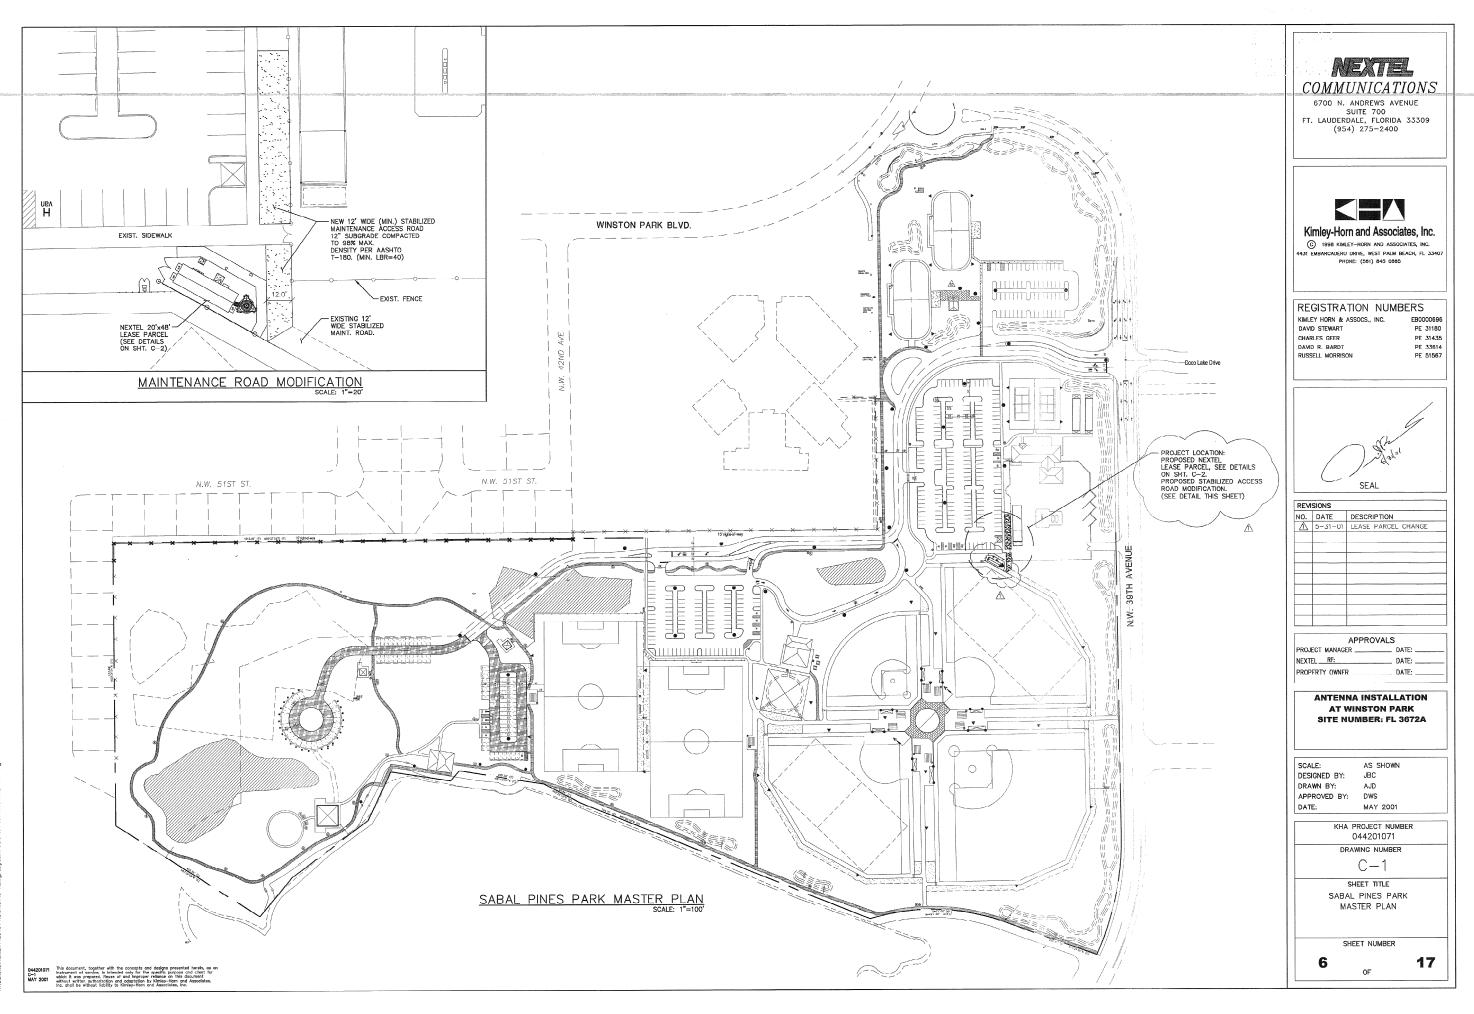

IllsifeiNexte\44201071\CONST\C-1 dwg | avout1 05/31/01 09:44:38 AM. Alex. Delgado

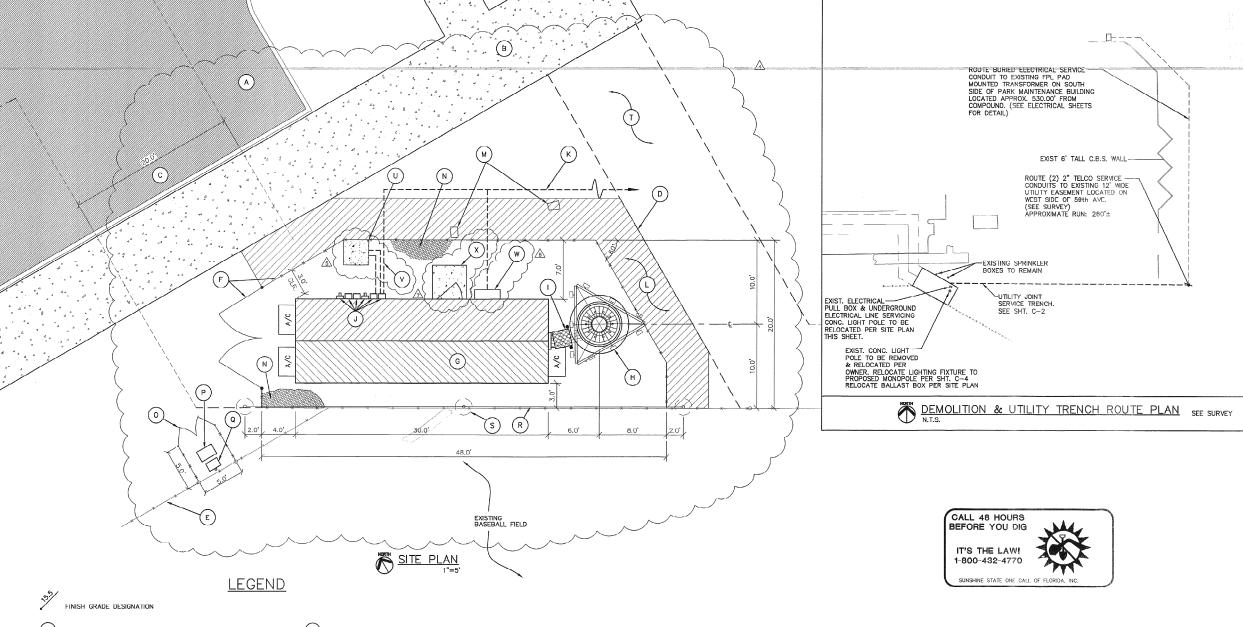

(A) EXISTING ADJACENT PARKING LOT.

(B) EXISTING SIDEWALK

PROPOSED 20' WIDE ACCESS EASEMENT THRU ADJACENT PARKING LOT TO NW 39TH AVENUE. (SEE SURVEY)

LIMITS OF NEXTEL LEASE PARCEL. SEE SURVEY FOR LOCATION.

E EXISTING BALL PARK 8.0' TALL CHAIN LINK FENCE TO REMAIN.

PROPOSED 8.0' TALL CHAIN LINK FENCE & 12.0' WIDE SERVICE GATE (SHOWN BOLD). TIE INTO EXISTING BALL PARK FENCE OF PARCEL MATCH EXISTING. (SEE DETAIL ON SHT. C-3) PROPOSED 10'x30' NEXTEL EQUIPMENT SHELTER BY ANDREW CORPORATION. MODEL: RCS 1030-115F-95R. SHELTER EXTERIOR FINISH TO MATCH EXISTING PARK BUILDING (SEE SHT. S-1 FOR FOR CONC. FOUNDATION) (G)

PROPOSED 125' TALL MULTI-CARRIER MONOPOLE BY OTHERS. (SEE MONOPOLE ELEVATION ON SHT. C-4)

PROPOSED NEXTEL CABLE WAVEGUIDE BRIDGE. (SEE SHT. C-2 FOR DETAIL)

PROPOSED LOCATION FOR DISCONNECTS, TRANSFER SWITCH AND GENPLUGS. (SEE ELECTRICAL SHEETS)

PROPOSED JOINT SERVICE TRENCH (SEE ROUTING PLAN THIS SHT.) (SEE TRENCH DETAIL ON SHT. C-2)

PROPOSED 5.0' WIDE LANDSCAPE BUFFER AROUND PERIMETER OF COMPOUND. (SEE LA-1 FOR DETAIL)

EXISTING SPRINKLER BOXES TO REMAIN.

 \bigcirc N 0.5' LAYER OF #57 STONE GRAVEL TO BE INSTALLED OVER SUB GRADE FILL. (TYP)

 \odot PROPOSED 5'x5' FENCED IN AREA W/ LATCH

NEW LOCATION FOR PULL BOX RELOCATED LIGHTING FIXTURE. (SEE SHI. E-1 FOR DETAIL)

NEW LOCATION FOR BALLAST BOX FOR RELOCATED LIGHTING FIXTURE.
(SEE SHT. E-1 FOR DETAIL)

20' TALL BALL PARK NETTING. SEE DETAIL ON SHT. C-3

BALLPARK NETTING POST. 2'Ø CONC. FOOTING SHOWN DASHED (TYP. OF 3)

SEE SHT. C-1 FOR STABILIZED MAINTENANCE

PROPOSED 3'x3'x4" THK. CONC. SLAB FOR NEW PAD MOUNTED TRANSFORMER. PROVIDE 6x6-W5.5xW5.5 WELDED WIRE FABRIC, AND MAKE T.O.C. SLAB 2" ABOVE FINISH GRADE.

ACCESS ROAD MODIFICATION. ELECTRIC SERVICE TO/FROM TRANSFORMER

PROPOSED NEMA RATED TELCO SVC.
JUNCTION BOX LOCATION.

A(X)4'x4'x4" CONC. STOOP. (SEE DETAIL ON SHT. S-1)

CONSTRUCTION NOTES

NEW COMMUNICATIONS ANTENNAS (TOTAL OF 9)

NEW 125' MONOPOLE (BY OTHERS) W/ NEW COMMUNICATIONS ANTENNA (BY OTHERS) NEW 10'x30' PRE-ENGINEERED EQUIPMENT SHELTER ON CONC. FOUNDATION

GENERAL NOTES

CONTRACTOR SHALL COMPLY WITH ALL APPLICABLE BUILDING CODE STANDARDS OF THE AUTHORITIES HAVING JURISDICTION OVER THE PROJECT AND MEET INDUSTRY STANDARDS FOR GOOD WORKMANSHIP.

NOTIFY THE PROPERTY OWNER, NEXTEL PROJECT MANAGER AND THE ARCHITECT/ENGINEER OF RECORD WELL IN ADVANCE AS TO WHEN CONSTRUCTION WILL COMMENCE.

COORDINATE THE LOCATION OF THE CONSTRUCTION STAGING AREA WITH THE PROPERTY OWNER DUILDING MANAGER AND THE ARCHITECT/ENGINEER OF RECORD WELL IN ADVANCE OF THE CONSTRUCTION START DATE.

PROTECT THE EXISTING FACILITIES AT ALL TIME: THE CONTRACTOR IS RESPONSIBLE FOR REPAIRING ANY DAMAGE CAUSED BY CONSTRUCTION OPERATIONS.

CONTRACTOR SHALL VERIFY THE EXACT LOCATION OF ALL EXISTING UTILITIES BY CALLING 1-800-432-4770 SUNSHINE STATE AT LEAST 48 HOURS PRIOR TO COMMENCING WITH THE WORK.

CONTRACTOR SHALL FIELD VERIFY ALL EXISTING CONDITIONS AND PLAN DIMENSIONS AND NOTIFY THE ARCHITECT/ENGINEER OF RECORD OF ANY DESCREPANCIES.

THE CONTRACTOR SHALL REMOVE ALL TRASH AND DEBRIS FROM THE SITE ON A DAILY BASIS.

THE EQUIPMENT LOCATIONS SHOWN SHALL NOT VARY WITHOUT THE REVIEW/APPROVAL OF THE ARCHITECT/ENGINEER OF RECORD.

MAINTAIN A MINIMUM OF 3' WORKING CLEARANCE IN FRONT OF ALL ELECTRICAL FOUIPMENT:

0.5' LAYER OF #57 STONE GRAVEL TO BE INSTALLED OVER SUB GRADE FILL

RESOD AND REPAIR ALL DISTURBED AREAS FROM CONSTRUCTION

NOTE: CONTRACTOR WILL PROVIDE SUFFICIENT SUBGRADE FILL MATERIAL COMPACTED TO MIN. OF 98% A ASHTO T-180 TO BRING FINISHED COMPOUND TO DESING ELEVATIONS.

NOTES

THIS IS AN UNMANNED RESTRICTED SITE AND WILL BE USED FOR THE TRANSMISSION OF RADIO SIGNALS FOR THE PURPOSE OF PROVIDING PUBLIC CELLULAR SERVICE.

NEXTEL COMMUNICATIONS CERTIFIES THAT THIS FACILITY WILL BE SERVICED ONLY BY NEXTEL EMPLOYEES AND THE WORK ASSOCIATED WITH ANY EQUIPMENT CANNOT BE PERFORMED BY HANDICAPPED PERSONS. THIS FACILITY WILL BE FREQUENTED ONLY BY SERVICE PERSONNEL FOR REPAIR PURPOSES. PURSULANT TO CHAPTER #553, PART 5A OF THE FLORIDA STATUTES, THIS FACILITY IS EXEMPT FROM THE REQUIREMENTS OF THAT STATUE. PURSUANT TO THE AMERICANS WITH DISABILITIES ACT (ADA), APPENDIX B, SECTION 4.1.1.(5XB), THIS FACILITY IS EXEMPT FROM THAT ACT.

THIS FACILITY WILL CONSUME NO UNRECOVERABLE ENERGY AND IS EXEMT. FROM THE FLORIDA ENERGY REVIEW CODE.

NO POTABLE WATER SUPPLY IS TO BE PROVIDED AT THIS LOCATION.

NO WASTE WATER WILL BE GENERATED AT THIS LOCATION.

NO PARKING FACILITIES WILL BE PROVIDED WITHIN THE LEASE SITE.

MEXTIEL COMMUNICATIONS

6700 N. ANDREWS AVENUE SUITE 700 FT. LAUDERDALE, FLORIDA 33309 (954) 275-2400



Kimley-Horn and Associates, Inc.

(C) 1998 KIMLEY-HORN AND ASSOCIATES, INC. 1431 EMBARCADERO DRIVE, WEST PALM BEACH, FL 33407 PHONE: (561) 845 0665

REGISTRATION NUMBERS

KIMLEY HORN & ASSOCS., INC. DAVID STEWART PE 31180 CHARLES GEER PE 31435 DAVID R BARDT PF 33614 RUSSELL MORRISON PE 51567



REV	ISIONS	
NO.	DATE	DESCRIPTION
Λ	2-26-01	ELEC. SOURCE REVISION
2	2-26-01	NEW TRANS. CONC. PAD
A	2-26-01	SERVICE TO/FROM NEW
		TRANSFORMER
4	5-31-01	SHELTER/ LEASE PARCEL SIZ
<u></u>	5-31-01	TRANSFORMER
<u>6</u>	5-31-01	TELCO SERVICE
A	5-31-01	CONCRETE PAD
	T	

	APPROVALS	i
	PROJECT MANAGER	DATE:
	NEXTEL RF:	DATE:
	PROPERTY OWNER	DATE:

ANTENNA INSTALLATION AT WINSTON PARK SITE NUMBER: FL 3672A


SCALE: AS SHOWN DESIGNED BY: JBC DRAWN BY: AJD. APPROVED BY: RCM DATE: MAY 2001

> KHA PROJECT NUMBER 044201071 DRAWING NUMBER C-2

SHEET TITLE

NEXTEL SITE PLAN

SHEET NUMBER

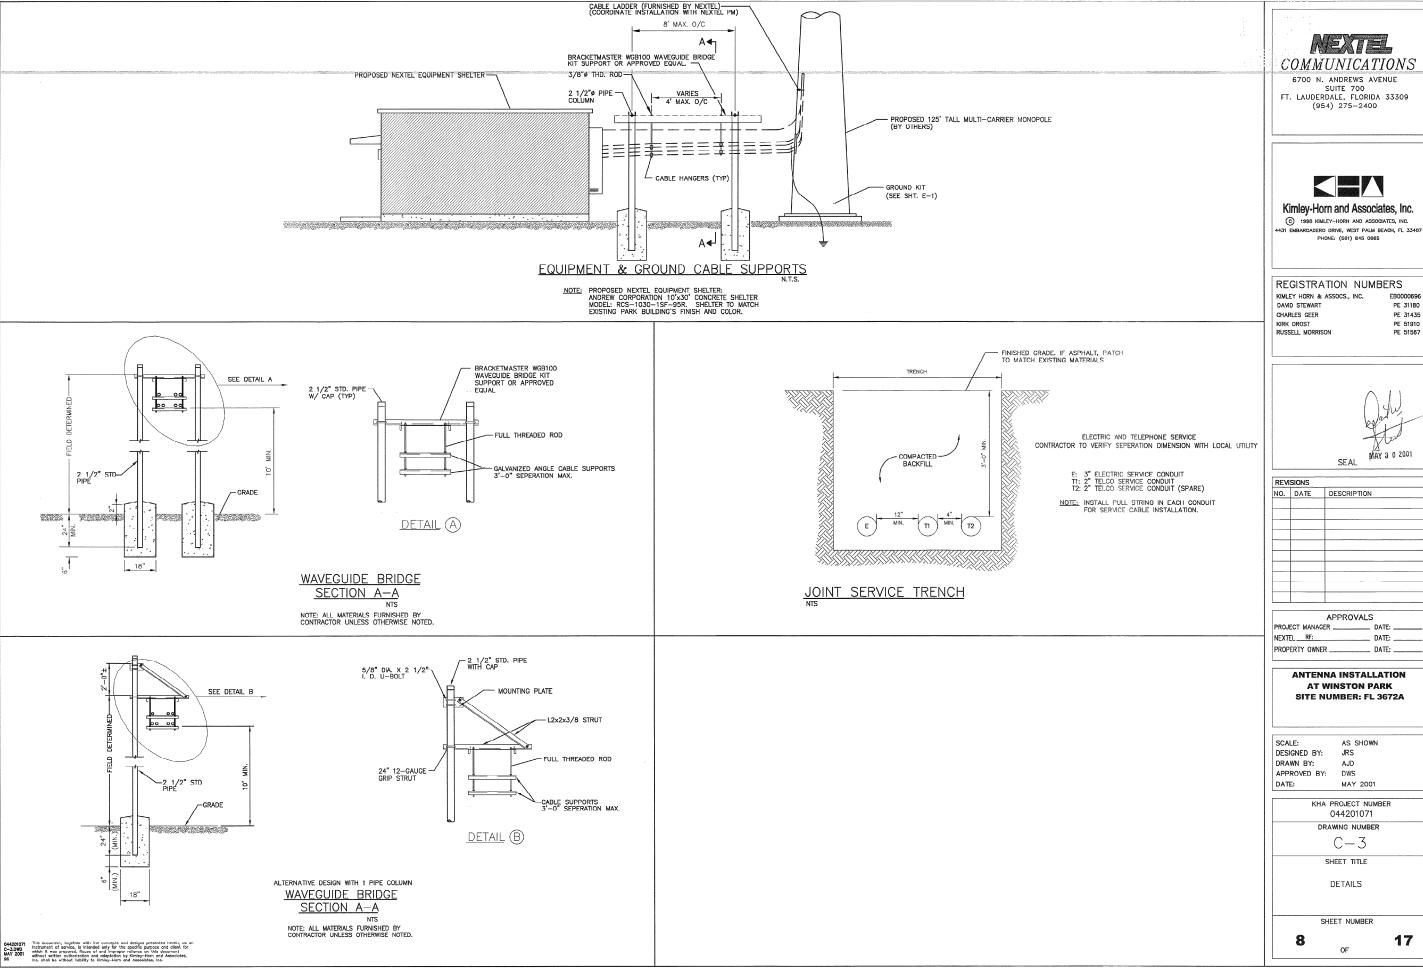

COMMUNICATIONS

© 1998 KIMLEY-HORN AND ASSOCIATES, INC. 4431 EMBARCADERO DRIVE, WEST PALM BEACH, FL 33407 PHONE: (581) 845 0665


PE 31180 PE 31435 PE 51910 PE 51567




NO. DATE	DESCRIPTION	
1101 57112	DEGGINI HON	
	1	
	1	

APPROVALS	3
PROJECT MANAGER	DATE:
NEXTEL RF:	DATE:
PROPERTY OWNER	DATE:

KHA PROJECT NUMBER 044201071
DRAWING NUMBER
C-3
SHEET TITLE
DETAILS

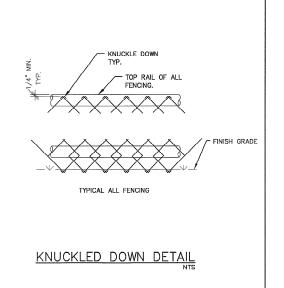

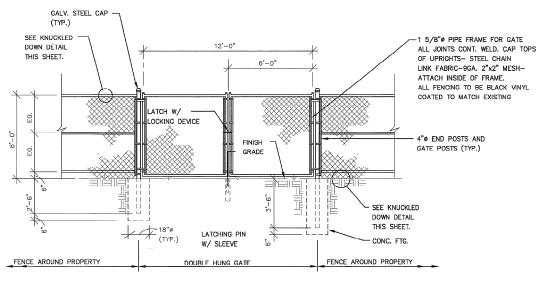

12' GATE ELEVATION

FENCING NOTES:

- ALL CHAIN LINK FENCE WALLS TO BE STRUNG THROUGH STRETCHER BARS AND ATTACHED TO END POST WITH CLIP.
- 2. ALL CHAIN LINK FENCE ALONG PIPE FRAME TO BE WIRE TIED. BLACK VINYL COATED TO MATCH EXISTING FENCE.
- 3. ALL WELD POINTS SHALL BE CLEANED AND PAINTED WITH POWDERED ZINC PRIMER.
- 4. ALL STEEL PIPE TO BE A.S.A. SCH. 40.
 BLACK VINYL COATED TO MATCH EXISTING FENCE.
- 5. GATE SHALL HAVE HEAVY DUTY HINGES AND LOCKING DEVICE.
- 6. SPLICES SHOULD ONLY OCCUR AT CROSSRAILS.
- 7. CAP TOPS OF UPRIGHTS SHALL EITHER HAVE A CONTINUOUS WELD OR HAVE "SET SCREWS" SO THEY CAN NOT BE REMOVED.
- 8. USE ONLY A HEAVY DUTY LATCH ON GATE.
- CONCRETE FOR FOOTINGS TO HAVE A MINIMUM 28 DAY COMPRESSIVE STRENGTH OF 3000 PSI.
- 10. FENCING TO HAVE TOP, BOTTOM AND MIDDLE RAILS.



6700 N. ANDREWS AVENUE SUITE 700 FT. LAUDERDALE, FLORIDA 33309 (954) 275–2400



Kimley-Horn and Associates, Inc.

© 1998 KIMLEY-HORN AND ASSOCIATES, INC. H-31 EMBARCADERO DRIVE, WEST PALM BEACH, FL 33407 PHONE: (561) 845 0665

REGISTRATION NUMBERS

 KIMLEY HORN & ASSOCS., INC.
 EB0000696

 DAVID STEWART
 PE 31180


 CHARLES GEER
 PE 31435

 KIRK DROST
 PE 51910


 RUSSELL MORRISON
 PE 51567




SEAL MAY 3 0 2001

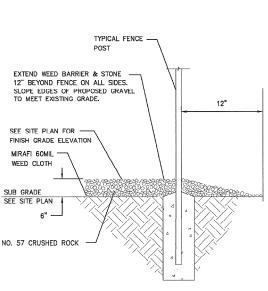

FENCE POST DETAIL

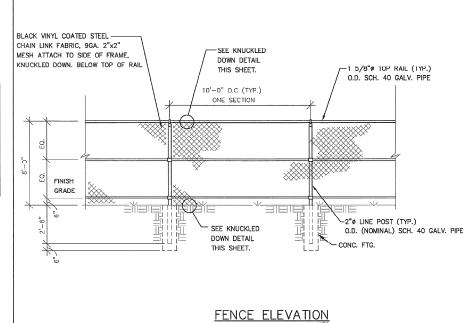

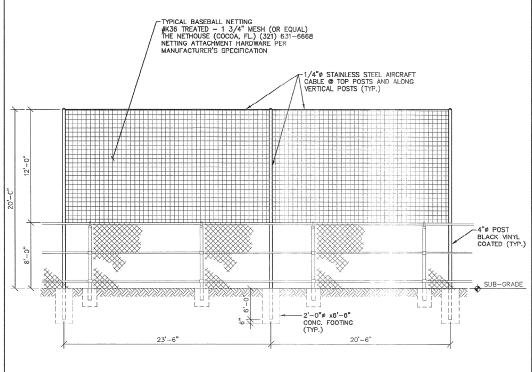

BALL PARK NETTING (NORTH ELEVATION)

NOTE: ATTACH BOTTOM OF NETTING TO EXISTING FENCE TOP RAIL.

REVISIONS				
NO.	DATE	DESCRIPTION		

	APPROVALS	5
	PROJECT MANAGER	DATE:
	NEXTEL RF:	DATE:
	PROPERTY OWNER	DATE:
į		

ANTENNA INSTALLATION AT WINSTON PARK SITE NUMBER: FL 3672A

SCALE: AS SHOWN
DESIGNED BY: JBC
DRAWN BY: AJD
APPROVED BY: DWS
DATE: MAY 2001

SHEET TITLE SERVICE GATE AND FENCE DETAILS

SHEET NUMBER


9

17

elisite\nextel\44201071\CONST\C-4.dwg. Model, 05/30/01 04:13:58 PM, Alex.Delgado


ANTENNA ORIENTATION DIAGRAM

(ORIENTATION DETERMINED BY NEXTEL RF ENGINEERS)

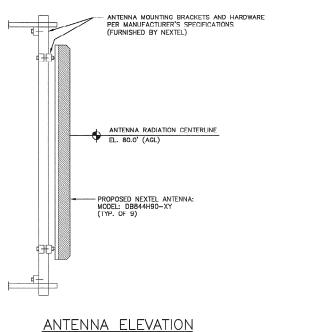

	CABLE	RUN TABI	_E
 ANTENNA	CABLE DIAMETER	LENGTH	3-33-4-1-32-1-3-32-1-3-3-3-3-3-3-3-3-3-3-3-3-3
A1	7/8"	100'±	ANDREW CORP.
A2	7/8"	100°±	ANDREW CORP.
A3	7/8"	100'±	ANDREW CORP.
B1	7/8"	100'±	ANDREW CORP.
B2	7/8"	100°±	ANDREW CORP.
В3	7/8"	100°±	ANDREW CORP.
G1	7/8"	100'±	ANDREW CORP.
G2	7/8"	100'±	ANDREW CORP.
G3	7/8"	100'±	ANDREW CORP.

CABLE RUN LENGTH TO BE VERIFIED BY CONTRACTOR PER NEXTEL RF ENGINEERING REQUIREMENTS.

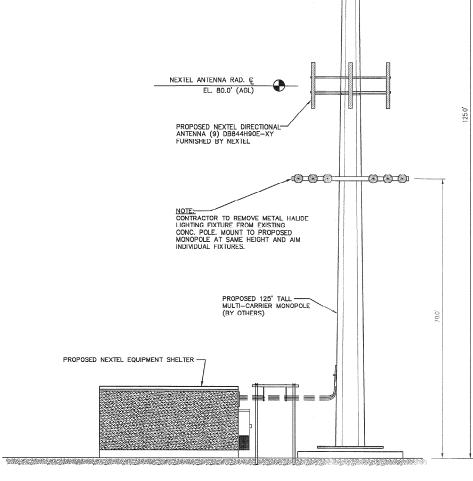

ELEVATION

- TOWER AND ALL PROPOSED EQUIPMENT MOUNTED ON TOWER BASED ON STRUCTURAL ANALYSIS BY OTHERS.
- 3. ANTENNA HEIGHTS SHOWN ARE BASED ON INFORMATION PROVIDED BY NEXTEL RF PERSONNEL.



6700 N. ANDREWS AVENUE SUITE 700
FT. LAUDERDALE, FLORIDA 33309
(954) 275–2400



Kimley-Horn and Associates, Inc.

© 1998 KIMLEY-HORN AND ASSOCIATES, INC. 4431 EMBARCADERO DRIVE, WEST PALM BEACH, FL 33407 PHONE: (561) 845 0665

REGISTRATION NUMBERS

KIMLEY HORN & ASSOCS., INC. EB0000696 DAVID STEWART PE 31180 CHARLES GEER PE 31435 PE 51910 PE 51567 KIRK DROST RUSSELL MORRISON



SEAL MAY 8 0 2001

	SIONS	
NO.	DATE	DESCRIPTION

APPROVALS	·
PROJECT MANAGER	DATE:
NEXTEL RF:	DATE:
PROPERTY OWNER	DATE:

ANTENNA INSTALLATION AT WINSTON PARK SITE NUMBER: FL 3672A

SCALE: AS SHOWN DESIGNED BY: JBC DRAWN BY: APPROVED BY: DWS DATE: MAY 2001

KHA PROJECT NUMBER 044201071 C-5SHEET TITLE

MONOPOLE ELEVATION

SHEET NUMBER

OF

10


17

NO SCALE (FURNISHED BY NEXTEL)

SHELTER FOUNDATION PLAN

#4 BARS

SECTION A-A

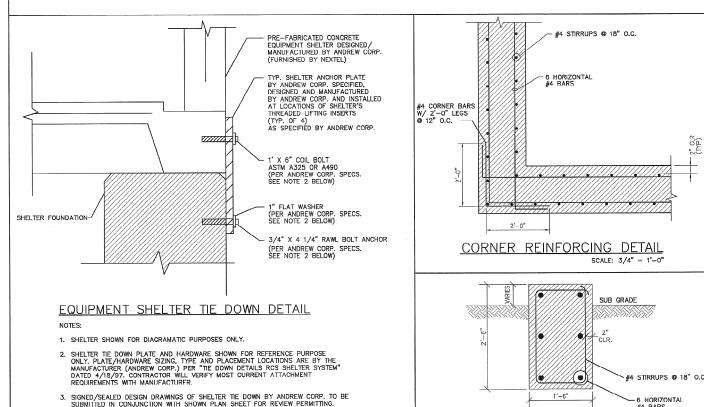

GENERAL STRUCTURAL NOTES

1999 SOUTH FLORIDA BUILDING CODE: BROWARD COUNTY EDITION FOUNDATION DESIGN IS BASED ON A RATIONAL ANALYSIS ASSUMING A MINIMUM SOIL BEARING CAPACITY OF 1500 PSF.

2. STRUCTURAL STEEL:

CONFORM TO ASTM A36 CRADE. STD PIPE AND TUBING SHALL
CONFORM TO ASTM A501. ALL STD. PIPE SHALL BE SCHEDULE 40 UNLESS OTHERWISE NOTED.

CONNECTIONS:
DESIGN, FABRICATION, AND CONSTRUCTION SHALL CONFORM TO AISC MANUAL OF STELL CONSTRUCTION.


WELDING:
SHALL BE DONE BY AN AWS CERTIFIED WELDER AND IN COMPLIANCE
WITH AWS D1.1. ALL WELD SIZES SHALL BE THE MAXIMUM ALLOWED
BY THE MATERIAL BEING WELDED WITH E70XX ELECTRODES.

BOLTS: A325-X WITH WASHER, SIZE AS SHOWN ON DRAWINGS.

ANCHOR BOLTS: SHALL CONFORM TO ASTM A307, UNLESS NOTED OTHERWISE

- 3. HOT DIP GALVANIZE ALL STRUCTURAL STEEL. TOUCH UP ALL FIELD WELDS AND ABRADED AREAS WITH TWO COATS OF GALVANIZED PAINT. REPAIR OF ABRADED OR UNCOATED AREAS SHALL CONFORM TO ASTM A780-03A.
- 4. CONTRACTOR/STEEL FABRICATOR SHALL LOCATE ANY REINFORCEMENT IN THE STRUCTURAL MEMBERS TO VERIFY THAT THEY WILL NOT CONFLICT WITH THE REINFORCEMENT WHEN INSTALLING ANCHORS. THE ANCHORS SHALL BE INSTALLED PER THE MANUFACTURERS INSTRUCTION.
- 5. CONTRACTOR/STEEL FABRICATOR SHALL CONFORM TO THE MINIMUM EDGE DISTANCE REQUIREMENTS IN ACCORDANCE WITH THE AISC MANUAL OF STEEL CONSTRUCTION.
- 6. ALL STRUCTURAL STEEL SHALL BE FABRICATED TO FIT BOLTED CONNECTIONS WITHIN 1/16 INCH TOLERANCE. STRUCTURAL STEEL SHALL NOT BE FLAME CUT UNDER ANY CIRCUMSTANCES WITHOUT APPROVAL OF THE ENGINEER.
- 7. CONTRACTOR/STEEL FABRICATOR SHALL CAP OR SEAL ALL PIPES AS REQUIRED TO PREVENT RAINWATER INTRUSION.
- 8. CONTRACTOR/STEEL FABRICATOR SHALL SUBMIT SHOP DRAWINGS FOR REVIEW PRIOR TO ANY STEEL FABRICATION. AT THE CONTRACTOR'S OPTION, FIELD SPLICES MAY BE USED FOR ERECTION PURPOSES. IF FIELD SPLICES ARE USED, THE SHOP DRAWINGS SHALL INCLUDE ALL DETAILS FOR THE PROPOSED FIELD SPLICES.
- 9. AT THE CONTRACTOR'S OPTION, SHOP WELDS MAY BE USED INSTEAD OF FIELD WELDS.
- 10. SUBMIT ORIGINAL SHOP DRAWINGS, INCLUDING COMPLETE DETAILS. SCHEDULES OF FABRICATION AND ASSEMBLY, PROCEDURES. AND DIAGRAMS. INCLUDE DETAILS OF CUTS. CONNECTIONS, CAMBER, HOLE, AND OTHER PERINERT DATA. INDICATE WELDS BY STANDARD AWS A2.1. AND A2.4 SYMBOLS. AND SHOW SIZE, LENGTH, AND TYPE OF WELD, PROVIDE SETTING DRAWINGS, TEMPLATES, AND DIRECTIONS FOR INSTALLATION OF ANCHOR BOLTS AND OTHER ANCHORAGES TO BE INSTALLED AS WORK OF OTHERS SECTIONS.
- 11. ALL CONCRETE SHALL HAVE A MINIMUM COMPRESSIVE STRENGTH OF 4000 PSI AT 28 DAYS.
- 12. REINFORCING STEEL: ASTM A615, 60 KSI YIELD CRADE, DEFORMED BILLET BARS, UNPROTECTED FINISH
- 13. PROVIDE 3/4" CHAMFER ON ALL EXPOSED EDGES OF CONCRETE.
- 14. MINIMUM CONCRETE COVER FOR REINFORCEMENT SHALL BE 2" UNLESS NOTED OTHERWISE. CONCRETE CAST AGAINST AND PERMANENTLY EXPOSED TO EARTH SHALL HAVE A MINIMUM CONCRETE COVER OF 3".
- CONTRACTOR SHALL COORDINATE ALL PENETRATIONS, CONDUIT, CHAMFERS, AND EMBEDDED ITEMS PRIOR TO CONCRETE PLACEMENT AND/OR STEEL ERECTION. CONTRACTOR SHALL VERIFY ALL SIZES AND LOCATIONS.
- 16. DO NOT IMPOSE SERVICE LOAD (i.e. FLOOR DEAD AND LIVE LOADS, BACKFILL, ETC.)
 UNTIL THE CONCRETE HAS REACHED ITS SPECIFIED MINIMUM COMPRESSIVE STRENGTH.

 17. CLASS "B" BACKFILL: SHALL BE CLEAN SAND FILL APPROVED FOR USE BY THE ENGINEER. NO UNAPPROVED MATERIAL WILL BE ALLOWED, CLEAN SAND FILL SHALL BE FREE OF ALL MARL, ROOTS, BOULDERS OR OTHER DELETERIOUS MATERIAL.
- 18. CONTRACTOR SHALL VERIFY THE ABSENCE OF ALL MARL, ROOTS, BOULDERS OR OTHER DELETERIOUS MATERIAL TO A DEPTH BELOW THE FOOTING EQUAL TO TWICE THE FOOTING WIDTH. ANY DELETERIOUS MATERIALS ENCOUNTERED SHALL BE REMOVED AND BACKFILLED WITH CLEAN SAND. THE ENTIRE BUILDING AREA SHALL BE COMPACTED TO 95% AASHTO T-99 TO A DEPTH OF 18 INCHES.
- 19. CONTRACTOR SHALL RESTORE ALL DISTURBED AREA TO EQUAL OR BETTER CONDITION.

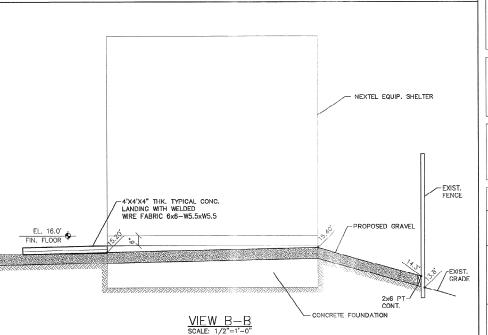



6700 N. ANDREWS AVENUE SUITE 700 FT. LAUDERDALE, FLORIDA 33309 (954) 275-2400



Kimlev-Horn and Associates, Inc.

© 1998 KIMLEY-HORN AND ASSOCIATES, INC. 1 EMBARCADERO DRIVE, WEST PALM BEACH, FL 33407

REGISTRATION NUMBERS

KIMLEY HORN & ASSOCS., INC. EB0000696 DAVID STEWART PE 31180 CHARLES GEER PE 31435 KIRK DROST PE 51910 RUSSELL MORRISON PE 51567



REVISIONS NO. DATE DESCRIPTION


APPROVALS PROJECT MANAGER ___ _ DATE: _ NEXTEL RE: DATE: PROPERTY OWNER _ DATE: _

ANTENNA INSTALLATION AT WINSTON PARK SITE NUMBER: FL 3672A

SCALE: AS SHOWN DESIGNED BY: JRS DRAWN BY: AJD APPROVED BY: DWS MAY 2001 DATE:

KHA PROJECT NUMBER 044201071 DRAWING NUMBER S-1SHEET TITLE SHELTER FOUNDATION

11

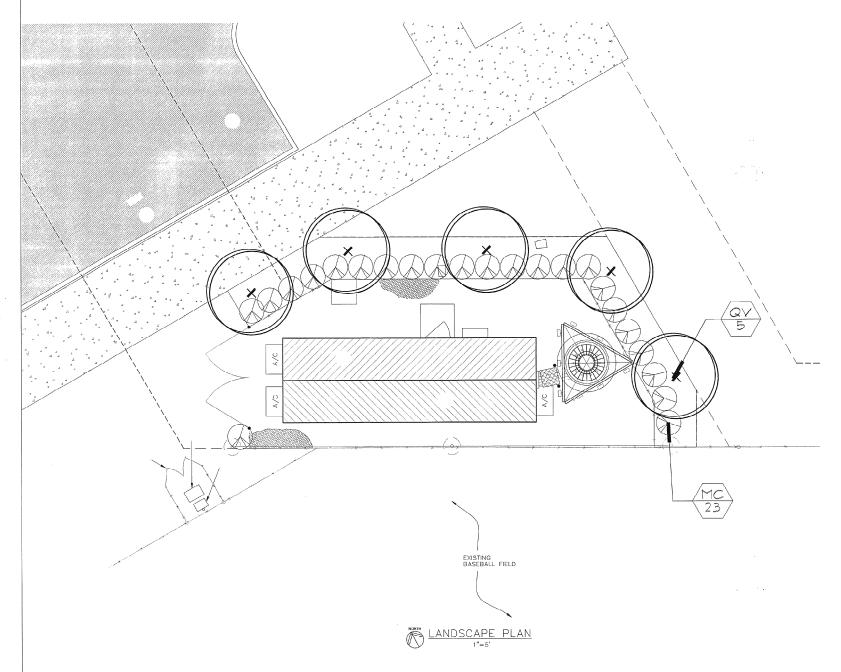

PLANT MATERIAL

SYM. QTY. BOTANICAL NAME COMMON NAME SIZE/REMARKS

TREES

QV 5 Quercus virginiana

45 gal. min., 12' height, 25" cal. min, Live Oak

SHRUBS AND GROUNDCOVERS

MC 23 Myrica cerifera

Wax Myrtle

3Gal., 30'x30', 30' O.C.

MISCELLANEOUS

Eucalyptus/Floramulch

Mulch

As Needed Stenotaphrum secundatum on site 'Floratam'

Floratam

Certified Sod, 100% insect/disease free, laid tight, rolled

CITY OF COCONUT CREEK LAND DEVELOPMENT CODES REQUIRED

ZONING DISTRICTS: RECREATIONAL

40% minimum native landscape requirement

PROPOSED

100%

2.5'

 \triangle \triangle hedge landscape barrier of at least 2 feet height $\frac{2}{2}$

PLANT LIST QUANTITIES ARE PROVIDED FOR CONVENIENCE. IN THE EVENT OF QUANTITY DISCREPANCIES, THE DRAWING SHALL TAKE PRECEDENCE. IT IS THE CONTRACTOR'S RESPONSIBILITY TO VERIFY PLANT MATERIAL QUANTITIES, INCLUDING SOD AND MULCH.

CONTRACTOR SHALL INSURE THAT ADEQUATE WATER IS SUPPLIED IN NECESSARY QUANTITIES TO ALL EXISTING AND NEWLY INSTALLED PLANTINGS.

ALL LANDSCAPING SHALL BE INSTALLED ACCORDING TO SOUND NURSERY PRACTICES AND SHALL BE FLORIDA NO. I OR BETTER AS GIVEN IN "GRADES AND STANDARDS FOR NURSERY PLANTS, FLORIDA DEPARTMENT OF AGRICULTURE AND CONSUMER SERVICES.

COMPLETELY REMOVE ALL SYNTHETIC NON-BIODEGRADABLE ROOTBALL WRAPPING MATERIAL PRIOR TO INSTALLATION.

NO SUBSTITUTIONS SHALL BE MADE WITHOUT WRITTEN AUTHORIZATION FROM THE OWNER OR LA. ALL PLANTING SHALL INCLUDE 3' LAYER OF FLORAMULCH.

NO SUBSTITUTIONS SHALL BE MADE WITHOUT WRITTEN AUTHORIZATION FROM THE LA OR OWNER, ALL LANDSCAPE AREAS SHALL BE FULLY IRRIGATED WITH AN AUTOMATIC IRRIGATION SYSTEM.

REVISION - SITE PLAN



6700 N. ANDREWS AVENUE SUITE 700 FT. LAUDERDALE, FLORIDA 33309 (954) 275–2400



Kimley-Horn and Associates, Inc.

C) 1998 KIMLLY-HURN AND ASSOCIATES, INC. 4431 EMBARCADERO DRIVE, WEST PALM BEACH, FL 3340. PHONE: (561) 845 0665

REGISTRATION NUMBERS

KIMLEY HORN & ASSOCS., INC. DAVID STEWART

CHARLES GEER KIRK DROST

PE 51910 PE 51567

FB0000696

PE 31435



	D 4 75	DECODIDETAL	h.1	
NO.	DATE	DESCRIPTION		
	İ			
	<u> </u>			
			_	
	İ			
		 	-	
	-			
			-	

	APPROVALS			
	PROJECT	MANAGER	DATE:	
	NEXTEL	RF:	DATE:	
	PROPERTY	OWNER	DATE:	
1				

AMTERINA INSTALLATION AT WINSTON PARK SITE NUMBER: FL 3672/A

DESIGNED BY: MDB DRAWN BY: MDB APPROVED BY: SEL MAY 2001

> KHA PROJECT NUMBER 044201071 DRAWING NUMBER LA-1

SHEET TITLE

LANDSCAPE PLAN

12

General Landscape Specifications and Notes

A. Scope of Work

The work consists of furneling all lobor, materials, equipment, track, transpartation, and any other opporteniances necessary for the completion of this project as shown on the Drawings, as included in the Plant List, and as herein specified.

Work shall include maintenance and votering of all planting areas of the Contract until Certification of Acceptability by the Owner.

B. Protection of Existing Structures

All enting buddaps, volks, valls, powna, ppra, and other stems of construction and planting aready completed or established shall be protected from damage by this Constructor unless otherwise specified. All damage resulting from incliquous shall be repaired or replaced to the substitution of the

The Couractor shall be responsible for all unashbaread cutting or denote to trees and shribs emisting or otherwise, cusced by a code supervision of expressed, stackplane of notamble, esc. The shall related compaction by driven or portions must be short per of the shall not of configuration of the shall not obtained on the shall not of configuration of the deleterous searchs with the dry-line. No natures shall be braned where the best will discuss early point. Trees state of monaged so that they are ensigned not of unsupply shall be registered in the costs to the Contractor of the Handred Deliers (\$1000) per colore such non mendioning cities which does not additional views (\$200) per to per not over fair (\$4) which so colore to dead of accred liquidated discusses. Caliper shall be neared so (\$6) incloss above ground level for trees over four (4) incles in colore. The Contractor shall be responsible for all inquithorped curting or danger to trees and shrubs existing

1 Ceneral

Samples of materials as listed below shall be submitted for approval, on the site or as otherwise determined by the Oviner. Upon approval of samples, delivery of materials may begin.

2. Pear, Maserusis.

Pear, Spece ond one shall reading its those indirected on the driveness. Nearestature shall conform as STADIACOUTED PLANT MAYES, PASY Edean. All watersy seeds shall be in accordance with CREADES AND STADIACOUTED PLANT MAYES. PASY EXECUTED TO the Livest existent published by the filestal Propertiess of Agreement of Agreement of Companies Survives. All plants shall be fibred Grode bits. It is better an attention by the filestal Powers of Plants Assistant, All plants all be freshly disposed, actual, busilly, supraise, well-branched only fire of discuss and notices, practice and branch and state hore disquare root systems. Terms for plants in one state the water of the special plants and except the state of

b. Pleasurements: The height, and/or with of trees shall be assumed from the ground or across the noral spread of branches with the plants in their noral poston. The insurement shall not notice the medicate transproad wyork. Plants ingerin in a sea than tisses speeded in the Plant Let may be useful of postproad by the Owner. If the use of lorger plants is approad of court of plants and he recreated in propuration to the sear of the plant.

competition reasons and or suggest an expection and approved on the place of graville, or upon deflower, in the run, so determined by the Owner, for quality, seek, and verset, such approved shall not appet the right of suppetion and rejection out the set during process of the varie or affect couplitum for see and condition of loss or routes, beaut failtest or migners. Expected places shall be removed mendatively free, the size. Notice requisioning respection shall be submissed in virtual by the Constructor on least one of 100 week prior to accept and dotter.

Topool for use in preparing set for buckfiring plans, puts shall be thirty percent (30%) and, but and seventy percent (70%) and and be ferste, freaker, and of a benny character, website neture of subsite extensis, and distance from a vell-dream challes sue. It will account later (3) to the (5) percent decomposed orapic souter and shall be free free heavy cloy, course sond, stones, bee, large, plants, routs or other forms neturely, an amount sweet. It shall not contain tone substances which may be harving to plant parts of the free free heavy cloy, course sond, stones, bee, large, plants, routs or other forms neturely, an amount sweet. It shall not contain tone substances which may be harving to plant parts of the free free heavy cloy. So the real neture.

Sand shall be course, clean, well draming native sand. Contractor shall submit results of soil tests for

Vater necessary for plantag and numeronce shall be of satefactory quality to sustan an obequate growth of plants and shall not content horself, natural or num-rade elevents detrivented to plants. Water menting the brown surfaced with the blanks of the sate of the sate for the Owner, or consider, and the Countactor shall be responsible to order errorements for its use by left tasks, house, sprakkers, etc. If such vater is not ordefacted to stake the Countactor shall provide such satefactory voter from sources of the size of no disclosured cost to the Owner.

G. Connercul Fernior

Converced Ferulater shall be a couplete familia; it shall be uniform in composition, dry and free Flowns. This fertilizer shall be delivered to the site in the ariginal unopened containers, each bearing the nanufacturer's quaranteed statement of analysis.

Fifty percent (50%) of the ntrogen shall be derived from natural argamic sources. The following fertilizers shall be used and applied at rates as suggested by natural actuaries specifications:

I Shrubs and Trees - Missessete on approved could

2. Annuals and aroundcovers - Osmocote/Surra Bland 14-14-14

3 Sod - 8-8-8 Fertilizer

In addition to surface applied fertizers, all container grown and field grown plant national shall receive "Marfarm" planting stablets 24-10-5 formale, 21 gram or equal. These tablets shall be placed at a depth of root ball at the rate as specified by naturalizations.

1. Protect roots or balls of plans at all these from son and drywa wads, valuer and firearra, as necessary uset porture. Plants instermis shall be delegately parest to prevent broading and drywa are during internation. These transported where that in (10) uses or with one not potented with their real (3) days of delivery to see shall be supposed with an entireogramical product ("Witprus" or equal) to manner transportational product ("Witprus" or equal) to manner.

Bailed and burlapped plants (B&B) shall be day with firm, natural bails of soil of sufficient size to exceppes the forms and feeting roots of the plants. No plants neved with a bail shall be planted the ball to crucked or broken. Plants bailed and burlapped or container grown shall not be handled by

3. Plants marked 'BR' in the Plant Lot shall be dup with lare routs. The roots shall not be cut within the names spread specified in the Plant Lot. Core shall be exercised that the roots do not dry out in nowing and prior to planting.

4. Protection of Polas (if applicable): Only a annum of fronds shall be removed from the crown of the pulm trees to facilitate moving and handling. Clear Trunk (CT) shall be as specified after the minimum

5. Excavation of tree pis shall be done using extreme care to avoid damage to surface and subsurface

L. All container grown noteral shall be healthy, vaporous, vell-rooted plants and established in the container in which they are sold. The plants shall have tops which are of good quality and are in a healthy growing condition.

Z. An escabeled container grown plant shall be transplanted rule o commoner and grown in that container sufficiently long for the new liferous roots to have developed so that the root was will ration as shape and loid Logether when removad from the container. Container grown stock shall not be bondled by

3. Plant roots bound in containers shall not be acceptable.

Substitution of non-container grown material for material explicitly specified to be container grown will not be permitted unless written approval is obtained from the owner and Landscope Architect.

When the use of collected stock is permitted as indicated on the Plant List Schedule, the ensure sizes of rootbolls shall be equal to that specified for the next larger size grown stock of the same variety.

L. Notine Stock

Plants callected from wild or nature stands shall be considered sursery grown when they have been successfully re-established in a nursery row and grown under require nursery cultural procrees for a menum of two (2) growng seasons and have attained adequate root and top growth to induce full recovery from transplanting run to the nursery row.

M. Moterials List

Quantities necessary to complete the work on the Drawnes shall be furnished. Quantity estimates have been note carefully, but the Landscape Archests or Owner assures no tability for consists or errors. Stand a desception of our between the bidders take off and the plant lost quantity, the landscape Archest shall be notified for charlestom prior to the subnession of both.

I. Fine grading under this Contract shall consist of final finehead grading of lawn and planting areas that have been rough graded by others. Burning as shown on the drawnss shall be the responsibility of the Landscape Constructur, unless arbenvise nated.

2. The Landscape Contractor shall like grade the lawn and planting areas to bring the rough grade up to frail finehed grade allowing for thickness of soid and/or much depth. This Contractor shall fine grad by hand and/or with all equipment necessary including a grading tractor with front—end loader for transcortings of white the sixt.

All planting areas shall be craded and manuaged to allow free flow of surface vater. Areas adjacent to buildings shall slope away from the buildings.

O. Planting Procedures

I. Cleaning up before connecting work The Contractor shall clean up work and surrounding areas of all riddes or object-conditie nature. All nature, center, and stace natural shall be reasoned from the surface of all parts beds. These naturalists also not be most with be sal. Should be Contractor in such set conditions beneath the out which will may very colorwisty differe the plant spranch, be shall manadately coil it, to the outenation of the Landscope Architect or Owner. Feature to do so before plants point and the correction ensoures the responsibility of the Contractors.

2. Verify locations of all utities, conducts, supply lines and cobles, including but not limited to: electric, and (lines and table) water, someony sever, successful lines, coble and table)have. Properly name in

3. Subgrade Execution: Size Contractor is responsible to resoure all ensiting and injurical limiteds and limited sub-tizzed from all landscape floriting areas to a rear—size depth of 36°. Size Contractor is respectable to bedieful these plantscape not rearly finished pride with deem togeth from a non-size source or an injurical source. If limited conductors occur in planted areas after 36° deep excention by Size Gournators, and posture distributed continuity on the architect, lookingse Contractor shall safter planting desirable and between passing and an architecture.

Furnish nursery's certificate of complance with all requirements as heren specified and required.
 France and solver plant materials before plants are due at nursery or growing site.

5. Ceneral: Comply with applicable Federal, State, County, and local regulations governing landscape a. Lemma. Lemmy van opposition reserva, activit, usarety, and total required governing foundcrops and with. Confirm to accepted behatfullard protected spin or avoid at the size by being thoroughly votared and apperly monated until plonted. Places shall not reason upprotected for a period exceeding twenty four (24) hours. At all times variabilities technologically and forticultural protections shall be exercised.

7. All planua pas shal be exclused to see and depth in accordance with the USA Standard for Narsery Deuk 2001, whos sherm softence on the drames, and localified with the proposed Planua Soil or specified herefulfore (Section S). Test off tree pas with water before principle on coulded. No divorce with earlier for the planua to assure proper dramage previous on coulded. No divorce will be said for the planua to assure proper dramage results, using pourag deal that offeresses the condition. Terms shall be set typing and held in poster until the piones, servine has been fluided in optice with a long fill these stream. All pointing shall be performed by personed forder the proper shall proper shall be constructed and of the the proper shall be shall be assured to a shared or pockets unround the roots. "Net Seck" or equal to recommended.

8. Take all necessary precoutors to avoid danage to buildings and building structures while installing

 \mathbf{q}_{i} Soi nature shall be as specified in Section E of these specifications. In addition, each planting pit

- Two (2) toltets per 1 qol. plant Three (3) toldets per 3 qol. plant Faur (4) toldets per 10 col. plant Larger Platerial two (2) toldets per 1/2' of trunk colper

10. Trees and shrubs shall be set straight and at such a level that after settlement, the plant crown will stand one (I) to two (2) where above grade. Each plant shall be set in the center of the pit. Planting sof nature shall be backfilled and thoroughly tamped around the ball and shall be settled by water after

II. Fill hole web sod mexture, retains certain all soil is socturated. To do the, fill hole with water and clow to sook measur twenty (20) markes, string if necessary to get soil theretainly wet. Pook thighly with face. And dure are used nature. Do not covere you of boil with soil enterer, only with malch. All burings, rope, wree, race, shall be removed from the sides and tops of boils, but no burings shall be platfor on undermach.

12. Prunno: Each tree shall be pruned to preserve the natural character of the plant as shown on the drawings. All soft wood or sucker growth and all braken or bodly damaged branches shall be reroved.

13. On the and would cover plants shall be evenly spaced in accordance with the drawings and as indicated on the Plant List. Cultivate all planting areas to a minum depth of 6', remove and depose at delive. Tal into top 4" the planting soll sex as specified in Section E. Throughly water all plants ofter installation.

14. Tree guying and bracing shall be installed by the Landscape Contractor in accordance with the plans to nour stability and sentin trees in a spelit position.

The Landscape Controller and Overe deads to wave the tire gaving and brocks, the Owen shall notify the Landscape Architect in writing of their internation and gave to hald harmless — the Landscape Architect in the event, any trees fall down and danage person or property.

15. Mulching: Provide a three (3) inch minimum layer of specified mulch over the entire area of each shrub bed, ground cover and wine bed and tree pt.

16. Herbooke Weed Courte: All plans beés shall be kept fire of norous veeds until find acoptomor of vars. If freezed by the Ower, "Road-Up" shall be appeled for veed counts' by qualified personnel of all plantag reverse a pseu applications per nonifications' precisions and specifications. Prior to find inspection, treat of plantag beds with an approved pre-mergant herbody as an application rate reconnected by the nonifications.

The work consets of lawn bed preparation, soil preparation, and southing complete, in strict accordance with the specifications and the applicable drawings to produce a grass lawn acceptable to the Owner.

2. Lam Bei Proporació: All arcos tolas are to be sodied shall be cleared of any roush, erans, weeks, and there, and the grand brought to an even grobe. The holds surface shall be trailed with a roller veclapa also, not vita non-harbrid (60) pounds per face of Velob. Lampa the rolled all dispersions cannot by sections of rolling shall be falled who additional suit, and the surface shall be recycled out roll next personning a mount and commands that is a up to the requested model.

3. Sal Preparation: Prepare losse bed four (4) native deep. Apply fortion at rate of trainty (20) points for one thousand (000) square feet. Applicant shall be uniform, utima approved exchanced spreaders. The further thoroughly with the sal to a depth of three (3) notes. Hord rake until all burps and depressions are removed. Were prepared orne thoroughly.

- The Contractor shall sed all areas that are not paved or planted as designated on the drawings within the contract here, unless enoughed in the order of horizons.
- The sod shall be certified to neet Florido State Plant, Board Specifications, obsolutely true to varietal
- Sad panels shall be laid tightly tagether so as to make a solid sodded lawn area. Sad shall be laid unformly against the edges of all curbs and other hordscape elements, purved and planned areas.
 Adjacent to baddings, a four such auch strp shall be provided, inseducity following and laying the long areas of the follower prices of the lower prices recordingly used for such purposes, and then thoroughly uses orders statule re-level two at least return recturning view or two purposes, and into the couper required. If, in the opening of the Owners, Lorp-deserge in encessary offer redting to 16 the veckle between the said ponels and to even our enconstances in the sod, clean send on approved by the Landscape Architect or Owner shall be uniformly spread over the extre surface of the sod and thoroughly subtreed in.

5. During delivery, prior to and during the planting of the laws areas, the sid pase's shall at all times be protected from excessive drying and uniccosory toposore of the roots to un

- a. Within the contract lens, the Contractor shall produce a density will established love. The Contractor shall be responsible for the reper and re-reading of all created, summ or have space used Contractors of Acceptability by the Landscape Architector Owner. Reported sorting shall be acceptabled as in the original work (houtbur regrouping of necessary).
- Water every day for ten (0) successive days, then water three (3) times per veek (at even intervals) for two (2) additional weeks. All vatering shall be of sufficient quantity to wet or resture water to depth of four (4) inches.

Upon completion of all planting work and before final acceptance, the Contractor shall remove all natural, equipment, and debre resulting from his work. All paved areas shall be broom cleaned and the site left in a next and acceptable condition as approved by the Owner's Nutritined Represent

All plants and plantan included under the Contract shall be rountained by vatering, cultivativing, sproving, and all other operations (such as ir existing or reporting just paperts) recessory to insure a healthy conductor by the Contraction under Certification of Acceptability of the Contraction (Corrections of Acceptability shall be in accordance with the specifications on the section. Contractions are required of provide as of estimate to correct individuos and irrigation manerature for a period of 40 Collegion days contenting other acceptance.

L Contractors are requested to provide a bid estimate for maintenance following the initial $90-{\rm doy}$ maintenance period on a cost per mainth basis.

l. The life and sole-factory condition of all 5 gallon and larger plant notional notation by the Landscape Contractor shall be quaranteed by the Contractor for a singua of one (I) coloniar year consenting at the time of Certification of Acceptability by the Landscape Architect or Ower.

2. The life and solvifactory conducen of all other plans noterial (including sod) installed by the Landscape Communition shall be qualisated by the Contraction for a name of 90 calendor days, convenience at the time of Certification of Acceptability by the Landscape Architect or Orient.

3. Replacement: Any plant not found in a healthy growing condition at the end of the augmentee period 3. Regionement: Purp plant not count in a mattery growing constant bit the ear or the guarantee person shall be removed from the size and replaced on soon as veather conducts parts. All replacements shall be plants of the same kind and size as specified in the Plant Lat. They shall be furnished planted and matched as specified under "Plantse", at no additional cost to the Owner.


4. In the event the owner does not contract with the Contractor for landscape (and imagazion) maintenance 4. In the event the open does not control, when the Lorence or endouge you trighted present as probability that the lorence or executing to view the properties probability that the low year warranty period to evaluate automorce procedures being periodic by the Ower, and shall loosely storage to period to evaluate automorce procedures being periodic by the Ower, and shall loosely warrant, but one of the open in which all descending procedures or conductors which unternate mayous and leasth plott warrant. In a supposite such such as the locodification of many of once per mental for a proof of twelve (CD) mustally from the date of accordance.

U. Final inspection and Acceptance of Work

Find respective on the end of the guarantee period shall be on planting, construction and oil other inclineds work pertinents to the Construct. Any replacement on this time shall be subject to the some oil (1) year uparantee (or as specified by the Landscape Architects on Orem in writing) becoming with the time of replacement and ending with the some respection and occeptance here described.

BEST FACE OF SHRUB/ GROUNDCOVER TO FACE FRONT OF PLANTING BED.

MAINTAIN 12" DEAD ZONE AT BED EDGE.

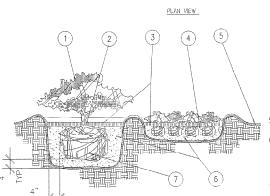

NOTES: I. TOP OF SHRUB ROOTBALLS TO BE PLANTED I" — 2" HIGH WITH SOIL MOUNDING UP

A HINIFORM MASS/HEICHT

COMPACTED OR AS SPECIFIED


FOR GROUDCOVER BED.

5. FINISHED GRADE (SEE GRADING

6 PREPARED PLANTING SOIL AS COVERS AND SHRIBS USED IN MASSES ENTIRE BED TO BE AMENDED WITH PLANTING SOIL MIX AS SPECIFIED.

7. SCARIFY ROOTBALL SIDES AND BOTTOM.

Shrub/Groundcover Planting Detail

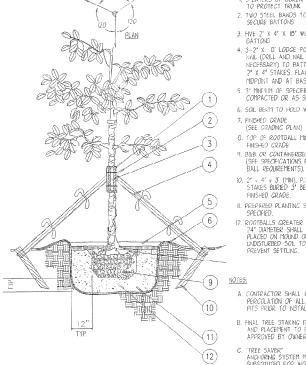

arge Tree Planting Detail

I. 5 LAYERS OF BURLAP TO PROTECT TRUNK 2. TWO STEEL BANDS 10 SECURE BATTONS

3. FIVE 2" X 4" X 18" WOOD BATTONS 4. 3-2" X 8' LODGE POLES. NAIL (DRILL AND NAIL IF

NECESSARY) TO BATTONS 2" X 4" STAKES, FLAG AT MIDPOINT AND AT BASE.

3" MINIMUM OF SPECIFIED MULCI COMPACTED OR AS SPECIFIED.

6 SON BERM TO HOLD WATER 7. FINISHED GRADE (SEE GRADING PLAN)

8. TOP OF ROOTBALL MIN. I' ABOVE FINISHED GRADE 9. B&B OR CONTAINERIZED (SEE SPECIFICATIONS FOR ROOT

10. 2" × 4" × 3" (MIN), P.T. WOOD STAKES BURIED 3" BELOW FINISHED GRADE.

II. PREPARED PLANTING SOIL AS

SPECUREU.

12. ROOTBALLS GREATER THAN
24" DIAMETER SHALL BE
PLACED ON MOUND OF
UNDISTURBED SOIL 10
PREVENT SETTLING.

A CONTRACTOR SHALL ASSURE

B. FINAL TREE STAKING DETAILS AND PLACEMENT TO BE APPROVED BY OWNER.

C. "TREE SAVER"
ANCHORING SYSTEM MAY BE SUBSTITUTED FOR WOOD STAKING SYSTEM UPON APPROVAL BY OWNER OR LANDSCAPE ARCHITECT.

NIZXIII COMMUNICATIONS

6700 N. ANDREWS AVENUE SUITE 700 FT. LAUDERDALE, FLORIDA 33309 (954) 275-2400



(C) 1998 KIMLEY-HORN AND ASSOCIATES, INC.

4431 EMBARCADERO DRIVE, WEST PALM BEACH, FL 3340: PHONE: (561) 845 0665

REGISTRATION NUMBERS

KIMLEY HORN & ASSOCS., INC. FROODORGE PE 31180 PE 31435 CHARLES GEER KIRK DROST PF 51910 RUSSELL MORRISON

SEAL

REVISIONS		
NO.	DATE	DESCRIPTION
		-
		-

APPROV	ALS
PROJECT MANAGER	DATE:
NEXTELRF:	DATE:
PROPERTY OWNER	DATE:

ANTENNA INSTALLATION AT WINSTON PARK SITE NUMBER: FL 3672A


1		
	SCALF:	AS SHOWN
	DESIGNED BY:	MAB
	DRAWN BY:	MAB
	APPROVED BY:	SEL
	DATE:	NOVEMBER 2000

KHA PROJECT NUMBER 044201071 1A-2

SHEET TITLE

LANDSCAPE DETAILS

SHEET NUMBER 13

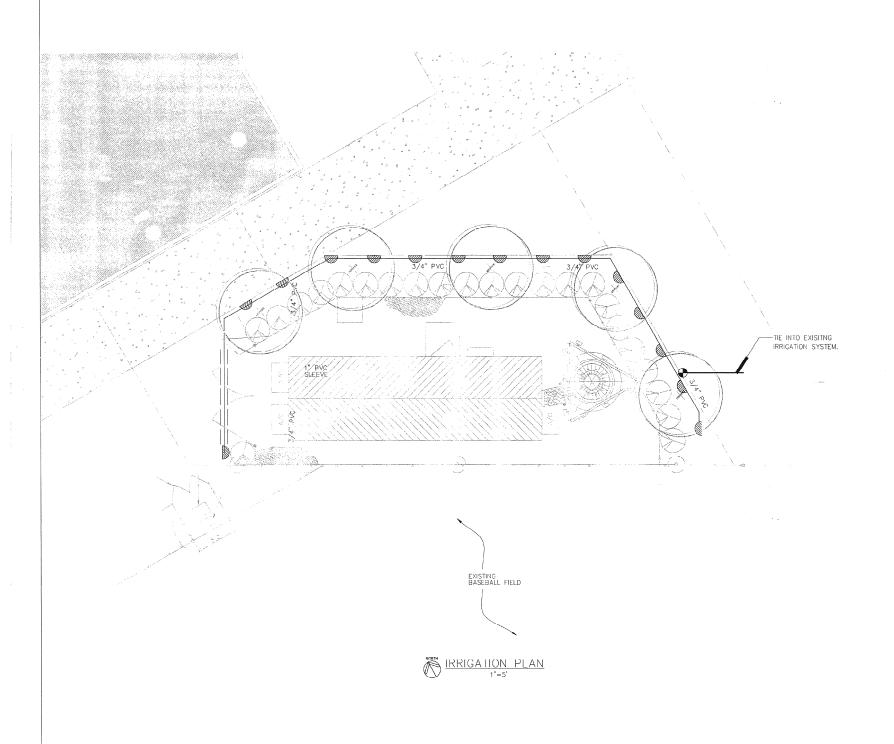

IRRIGATION SYSTEM

IRRIGATION IS TO BE COORDINATED WITH THE CITY.

IRRIGATION SHALL PROVIDE 100% COVERAGE WITH A 50 % OVERLAP

IRRIGATION CONTRACTOR MUST EVALUATE EXISTING PARK IRRIGATION SYSTEM, AND DETERMINE IF THE NEAREST ZONE IS CAPABLE OF SUPPLYING AN ADDITIONAL 4.0 G.P.M. IF FOUND UNCAPABLE. A NEW ZONE MUST BE ADDED FROM THE EXISTING MAINLINE. WIRING AND A NEW CONTROL BOX MAY BE REQUIRED IF CURRENT SYSTEM IS INCAPABLE OF BEING UPGRADED.

SOURCE OF WATER FOR IRRIGATION SYSTEM WILL BE THE EXISTING PARK IRRIGATION SYSTEM.

INSTALLATION IS TO INCLUDE COMPLIANCE WITH APPLICABLE CODES, PRESSURE TESTING OF MAINLINE, AND HARDWIRE TO POWER SOURCE AT EQUIPMENT SHELTER, CONTRACTOR MAY USE ALTERNATE/NEARBY SOURCE IF FOUND ACCEPTABLE BY PROJECT MANAGER.

CONTRACTOR TO EVALULATE EXISTING SYSTEM AND PRODUCE IRRIGATION SHOP DRAWINGS PRIOR TO SUBMITTING FOR A BUILDING PERMIT.

THE CONTRACTOR SHALL BE REPONSIBLE OF CONTRACTING LOCAL UNDERGROUND UTILITIES TO VERIFY LOCATIONS, THE CONTRACTOR SHOULD VISIT THE SITE PRIOR TO INSTALLATION AND BECOME FIMILIAR WITH EXISTING CONDITIONS.

THE CONTRACTOR IS RESPONSIBLE FOR ALL MATERIAL REQUIRED TO MAKE THE SYSTEM FUNCTION PROPERTY. ALL IRRIGATION SHALL BE IN ACCORDANCE WITH MANUFACTURER'S SPECIFICATION AND COMPLY WITH XERISCAPE PRINCIPLES AS SPECIFIED BY THE SOUTH FLORIDA WATER MANAGEMENT DISTRICT.

ALL SLEEVING SHALL BE SCH 40 PVC TO SIZE INDICATED ON PLAN, OR IF NOT INDICATED, A MIN. OF 2 PIPE SIZES LARGER THAN THE SUPPLY LINE CONTAINED. ALL SLEEVES SHALL BE INSTALLED A MIN. OF 24" BELOW FINISHED GRADE.

WATERING TIME PER STATION WILL BE DETERMINED IN THE FIELD AND PER LOCAL REQUIREMENTS. REFER TO MANUFACTURE'S INSTUCTIONS FOR PRECIPITATION RATES OF SPRINKLERS SPECIFIED.

LEGEND

ZONES

SHRUB & TREE ZONE

NOTE:

Preferred irrigation specs: TORO 570 MPR PLUS SRAPY NOZZLES

HARDIE ELECTRIC VALVE (100-2)

 $\stackrel{\times}{\cancel{xx}}$ ZONE #/GALLONAGE

IRRIGATION CACULATION: ZONE | - 3.8 GAL PER MIN REQUIRED FOR IRRIGATION DESIGN.





6706 N. ANDREWS AVENUE SUITE 700 FT. LAUDERDALE, FLORIDA 33309 (954) 275-2400



Kimley-Horn and Associates, Inc.

C 1998 KIMLEY-HORN AND ASSOCIATES, INC. 4431 EMBARCADERO DRIVE, WEST PALM BEACH, FL 33407 PHONE: (561) 845 0685

REGISTRATION NUMBERS

 KIMLEY HORN & ASSOCS., INC.
 EB0000696

 DAVID STEWART
 PE 31180

 CHARLES GEER
 PE 31435

 KIRK DROST
 PF 51910

 RUSSELL MORRISON
 PE 51567



REVISIONS					
NO.		DESCRIPTION			
			_		

 APPROVALS

 PROJECT MANAGER
 DATE:

 NEXTEL
 RF:
 DATE:

 PROPERTY OWNER
 DATE:

antenna installation At Winston Park Site Number: FL 3572A

SCALE: AS SHOWN
DESIGNED BY: MDR
DRAWN BY: MDB
APPROVED BY: SEL
DATE: MAY 2001

KHA PROJECT NUMBER
044201071

DRAWING NUMBER

| | | 1

IRRIGATION PLAN

SHEET NUMBER

14

17

04201071 This accument, together with the concepts and designs precented herein, or ferrowers of service. In intended only for this specific parmise and design to the service of the ferrowers of service. It intended only for this specific parmise and design to the design of the service of the design of the de

IRRIGATION SPECIFICATIONS SCALE: AS NOTED

A. EXTENT:

includes furnishing all-lobor, materials and equipment for the proper installation of the irrigation system. The work includes, but is not limited to the following: (1) Trenching and Bockfill; (2) Automatically Controlled Irrigation System; (3) Test All Systems and Make Operative; (4) "An—Built" Drawing.

B. GENERAL:

- 1. Permits and Face: Obtain all permits and pay required fees to any governmental agency having jurisdiction over the work, Inspections required by lead ordinances during the occurse of construction shall be arranged as required. On completion of the work, substitution evidence shall be furnished to the Tenant's construider representative to show that all work has been installed in accordance with the ordinances and code requirements.
- Approval: Wherever the terms "approve" or "approved" ore used in the specifications, they shall mean the approval of the tenant's construction
- Before any work is started, a conference shall be held between the contractor and the Tenant's construction representative concerning the work under this Contract.
- Coordination: Coordinate and cooperate with other contractors to enable the work to proceed as rapidly and efficiently as possible
- 5. Inspection of Site:
- a. Contractor shall acquiant himself with all site conditions Submission of his proposal shall be considered evidence that the examination has been conducted. Should utilities not shown on the plans be found during excevations, Contractor shall promptly notify the Terion's construction representative for instructions to further action. Failure to do so will make contractor liable for any and all damage thereto arising from his operations subsequent to discovery of such utilities not shown in plana.
- b. Contracts and animal in plants.

 b. Contractor shall make necessarry adjustments in the loyout as may be required to connect to existing stubouts, should such stubs not be located exactly as shown, and as may be required to work around exist work at no increase in cost to the Temant's construction representative.
- work at no increase in cost to the Tenant's construction representative. O Protection of Existing Plants and Site Conditions: The Contractor shall take necessary precautions to protect site conditions to remain. Should demage be incurred, this Contractor shall repair the damage to its original condition at his own expense.

 7. The owner reasons the right to substitute, add, or delete any material or work as the work progresses. Adjustments to the contract price shall be negotiated if deemed necessary by the Owner on a per diem basis.
- The Owner reserves the right to rejembterial or work which does not conform to the Contract DocumenRejected work shall be removed or corrected at the earliest time possible.
- Work Schedule: Within 10 days after award of the Contract, the contractor shall submit to the Owner a workschedule.
- 10. "As-Built" Irrigation Drawings: Prepare on "As-Built" drawing on a blueprint which shall show deviations from the bld documents made during construction affecting the main line pipe, container locations, remote control volves and quick coupling valves. The drawings shall also indicate and show approved substitutional size, material and manufacturers name and catelog name and catelog number. The drawings shall be delivered to the "Meant's construction representative bottor entil acceptance of
- 11. Final Acceptance: Final acceptance of the work may be obtained from the Tenant's construction representative upon the satisfactory completion of all work.

 12. Guarantee: All work shall be guaranteed for one year from date of acceptance against all defects in material, equipment and workmanship. Guarantee shall also over repair of damage to any port of the premises resulting from leaks or other defects in material, equipment and workmanship to the satisfactory of the Tenats construction representative. Repairs, if required, shall be done promptly at no cost to the Owner.

C. MATERIALS:

- General: All materials throughout the system shall be new and in perfect condition.
- Plastic Piping: All main lines shall be Class 200 o-ring polyvinyl chloride (PVC) pipe and shall conform to ASIM D-2241 cc 200 with gaskets conforming to ASIM 1889-F477.
 All lateral piping shall be PVC Class 160 solvent weld conforming to ASIM D-1784 and D-2241
- Plastic Fittings: Sch. 40 solvent weld, polyvinyl chloride (PVC) standard weight as manufactured by Sloane, Lasco, or approved equal.
- Solvent Cement: Compatible with PYC pipe, of proper consistency, and color.
- 5. Sprinkler Head Risers: Sch. 40 PVC for risers. Pipe shall be cut in a standard pipe cutting tool with sharp cutters. Reum only to full diameter of pipe and clean all rough edges or burs. Out all threads accurately with sharp dies. Not more than three(3) full threads shall show beyond tittings when pipe is made up.Assemblies shall be as detailed.
- Automatic Controllers:
 See Legend
- 7. Remote Control Valves: See Legend
- Control Wiring: 24 volt solid UL approved for direct burial in ground.
 Minimum wire size: 12 guage.
- Sleeves for Control Wiring: Under all walks and paved areas and where indicated on drawings. Minimum PVC 1220—160 psi plastic pipe.
- 11. Quick Coupling Valves: Shall be noted on drawings.

NOTES:

DO NOT SCALE PLAN FOR EXACT HEAD LOCATION.

ALL RISERS SHALL BE PAINTED FLAT BLACK.

THE CONTRACTOR SHALL MAKE ALL ADJUSTMENTS TO THE IRRIGATION SYSTEM WHICH PROVIDES A MINIMUM 100% COVERAGE WITH 50% OVERLAP.

THE CONTRACTOR SHALL RUN THE DESIGNATED ADDITIONAL WIRES TO THE INDIVIDUAL TRACTS AS FOLLOWS:

TRACT B1: 10 WIRES TRACT B2: 4 WIRES TRACT C: 10 WIRES

THE CONTRACTOR SHALL BE RESPONSIBLE FOR HARD WRING THE THE ELECTRICAL SERVICE CONNECTIONS

THE FINAL LOCATION OF ALL COMPONENTS SHALL BE APPROVED BY THE OWNER

D. WORKMANSHIP:

- Lay out work as accurately as possible to the drawings. The drawings though corefully drawn, are generally diagrammatic to the extent that swing joints, offsets, and all fittings are not shown.
- swing joints, offsets, and all fittings are not shown.

 2. The Contractor shall be responsible for full and complets coverage of all irrigated areas and shall make any necessary minor adjustments at no additional cost to the Tenant's construction representative.

 3. Any major revisions to the irrigation system must be submitted and answered in written form, along with any change in contract price.

E. INSTALLATION:

- Excavation and Trenching:
- ENLoyation and Irenching:
 Perform all excevoltions as required for the installation of the work including under this section, including shoring of earth banks to preven cover-ine. Restore all surfacese, existing underground installations, etc., damaged or cut as a result of the excevoltions to and in a manner approved by the Owner.
- b. Trenches shall be made wide enough to allow a minimum of 6 inches between parallel pipe lines. Irenches for pipe lines shall be made of sufficient depths to provide the minimum cover from finish grade as
 - follows: 1) 18" minimum cover over main lines
- 3) 12" minimum cover over lateral lines to heads Maintain all warning signs, shoring, barricades, flores and red lanterns as required by the Safety Orders of the Division of Industrial Safety and local ordinances.
- 2. Pipe Line Assembly:
- Install remote control valves where shown and group together where practical; place no closer than 12 inches to walk edges, buildings and
- b. Plastic pipe and fittings shall be solvent welded using solvents and connections are required. Pipe and fitngs shall be thoroughly alsoned of dirt, dust and moisture before applying solvent with a non-synthetic bristle brush.
- c. Pipe may be assembled and welded on the surface. Snake pipe
- d. Make all connections between plastic pipe and metal valves or steel pipe with threaded fittings using plastic male adopters.
- 3. Sprinkler Heads:
- a. Install all sprinklers as detailed on drawings.
 b. Do not scale plans for exact head location.
- 4. Closing of Pipe and Flushing Lines:
- a. Cop or plug all openings as soon as lines have been installed to
- place until removal is necessary for completion of installation.
- Thoroughly flush out all water lines before installing heads, valves and other hydrants.
- Upon completion of the testing, the contractor shall complete assembly and adjust sprinkler heads for proper distribution.
- 5. Hydrostatic Tests:
- Request the presence of the Owner in writing at least 48 hours in advance of testing.
- b. Testing to be accomplished at the expense of the Contractor and in the presence of the Owner.
- c. Center load piping with small amount of backfill to prevent arching or slipping under pressure.
- d. Applying a continuous and static water pressure of 125 psi when welded plastic joints have cured at least 3 hours and with the risers Main lines and submains to be tested for 3 hours. Moin lines and submaints to be taken to the following for o-ring gasket pipe the allowable leakage shall not exceed the number of gallons per hour as determined by the following formula:
- L=SD(P) -5 133200
- in which:

 L=Allowable leakage, in gollons per hour
 S=Length of pipe tested in feet
 D=Pipe diameter in inches
 P=Average test pressure in PSI guage
 f. Repair leaks resulting from tests.
- a. Connect remote control valves to controller in a clockwise sequence to correspond with station setting beginning with Stations 1, 2, 3, etc.
- 7. Automatic Control Wiring:
- Install control wing, sprinkler mains and laterals in common tranches wherever possible.

 Install control wires at least 18" below finish grade and lay to the side and below the main line. Provide looped slock at valves and snake wires in trench to allow for contraction of wirefic wires in bundles at intervals.

 C. Cantrol wire splices will be allowed only runs over 1000 ft.


 Connections shall be as detailed.
- d. All wiring passing under existing or future paving, construction, etc., shall be encesed in plastic or galvanized steel conduit extending at least \$2yond edges of paving or constuction.
- 8. Backfill and Compacting:
- After system is operating and required tests and inspections have been made, backfill excavations and trenches with clean soil, free of
- rubbish.


 Blockfill for all trenches, regardless of the type of pipe covered, shall be compacted to minimum 90% density.
- c. Compact trenches in areas to be planted by thoroughly flooding the backfill. Jetting process may be used in those areas. d. Dress off all greas to finish grades.


F. CLEAN-UP:


1. Remove from the site all debris resulting from work of this section.


HEAD DETAILS

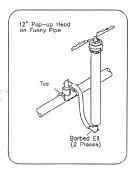

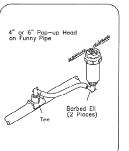

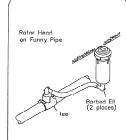

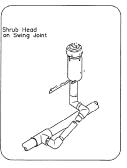


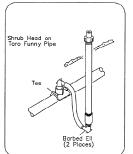


SLEEVE SIZE SCHEDULE

PIPE SIZE	SLEEVE SIZE
3/4"	1-1/4"
1"	2" 2-1/2"
1-1/2"	2-1/2"
2"; 2-1/2"	3,"
2-1/2" 3 4"	4"

THRUST BLOCK DETAILS

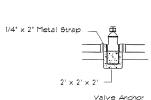

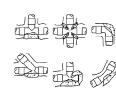

NOTE: Min. thrust block size shall be 2 cu. ft...

CCMMUNICATIONS

6700 N. ANDREWS AVENUE SUITE 700 FT. LAUDERDALE, FLORIDA 33309 (954) 275-2400



Kimley-Horn and Associates, Inc.

(C) 1998 KIMLEY-HORN AND ASSOCIATES, INC. EMBARCADERO DRIVE, WEST PALM BEACH, FL 3340 PHONE: (561) 845 0665

REGISTRATION NUMBERS

INEOIS INVITION	TYONIDE	110	
KIMLEY HORN & ASSOCS.,	INC.	EBO	00069
DAVID STEWART		PE	31180
CHARLES GEER		PE	3143
KIRK DROST		PE	51910
RUSSELL MORRISON		PE	51567



	ISIONS	1
NO.	DATE	DESCRIPTION
		-
	ļ	

APPROVALS	;
PROJECT MANAGER	DATE:
NEXTEL RF:	DATE:
PROPERTY OWNER	DATE:

ANTIENNA INSTALLATION AT WINSTON PARK SITE NUMBER: FL 3672A

SCALE: AS SHOWN DESIGNED BY: MDB DRAWN BY: MDB APPROVED BY: SEL

KHA PROJECT NUMBER 044201071 DRAWING NUMBER IR-2

> SHEET TITLE IRRIGATION DETAILS

SHEET NUMBER


15

17


ALL MAIN LINE SLEEVE LOCATION ARE ACCOMPANIED WITH A 2" ELECTRICAL CHASE FOR THE CONTROL WRING

TORO 510 SERIES SHRUB ADAPTOR *4 REBAR SECURED TO STANDPIPE WITH STAINLESS STEEL HOSE CLAMPS AT 2 POINTS AND BURIED AT AN APPROPRIATE DEPTH FOR STABILITY - NOTE: INSTALL SFRINKLER ABOVE FINISHED GRADE


TORO SPRAY NOZZLE ON STAND-PIPE WITH SHRUB ADAPTOR SCALE: NOT TO SCALE

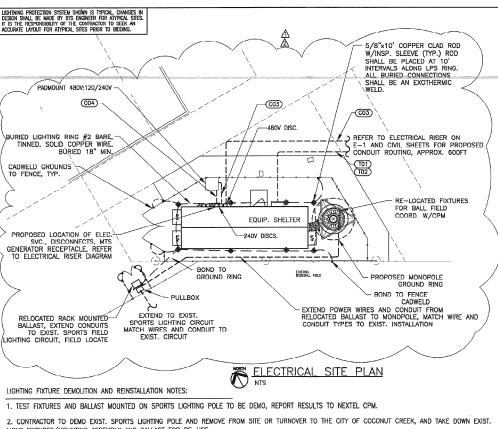


- 3. INSTALL NEW MONOPOLE ANTENNA AND REINSTALL EXIST. FIXTURES/ASSEMBLY ONTO MONOPOLE MAINTAIN SAME ELEVATION AND AIMING OF FIXTURES AS THE ORIGINAL INSTALLATION. CONTRACTOR MAY NEED TO FURNISH ADDITIONAL HARDWARE TO MOUNT FIXTURE/ASSEMBLY ONTO NEW MONOPOLE.
- 4. INSTALL EXIST. BALLAST ONTO RACK AND FURNISH NEW WIRING AND CONDUIT FROM BALLAST TO RELOCATED FIXTURES, MATCH WIRES AND CONDUIT TO EXIST. INSTALLATION.
- 5. RECONNECT RELOCATED FIXTURES AND BALLAST TO EXIST. SPORTS LIGHTING LIGHT CIRCUIT, FIELD LOCATE AND EXTEND WIRES AND CONDUITS AS
- 6. CONTRACTOR TO HIRE MUSCO LIGHTING SERVICES FOR LIGHTING TEST CERTIFICATION AND STRUCTURAL INTEGRITY OF INSTALLATION, CONTACT TIM IMHOFF @ 954-583-9756

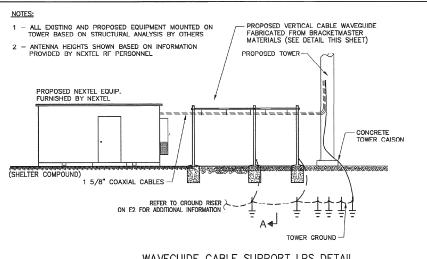


WAVEGUIDE CABLE SUPPORT LPS DETAIL

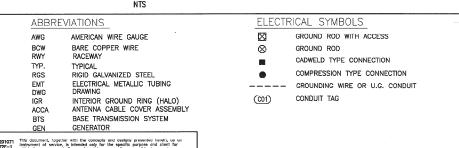


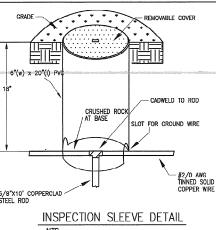



NTS

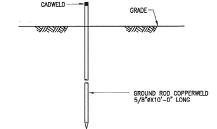

GROUNDING - STANDARD DETAIL **GROUND ROD**

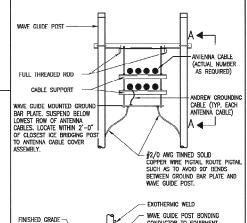

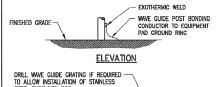


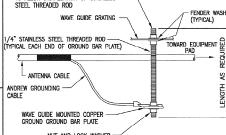

NUT AND LOCK WASHER

SECTION A-A

WAVE GUIDE MOUNTED GROUND BAR PLATE INSTALLATION

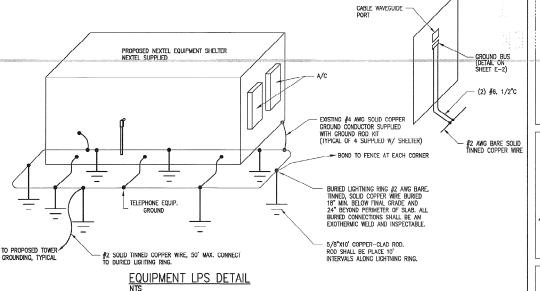

ELECTRICAL NOTES

- A. THE CONTRACTOR SHALL PROVIDE ALL MATERIAL AND LABOR FOR A COMPLETE ELECTRICAL SYSTEM AS INDICATED ON THE DRAWINGS. ITEMS NOT SHOWN BUT OBVIOUSLY NECESSARY FOR A COMPLETE SYSTEM SHALL BE INCLUDED.
- B. THE CONTRACTOR SHALL OBTAIN ALL NECESSARY PERMITS, INSPECTIONS AND
- C. ALL WORK SHALL CONFORM TO THE NATIONAL ELECTRICAL CODE AND THE LOCAL BUILDING CODES, ALL COMPONENTS SHALL BE U.L. APPROVED.
- D. THE CONTRACTOR SHALL BEFORE SUBMITTING HIS BID, VISIT THE SITE OF THE PROJECT AND BECOME FAMILIAR WITH THE CONDITIONS. NO ALLOWANCE WILL BE MADE FOR EXISTING CONDITIONS OR FAILURE OF THE CONTRACTOR TO OBSERVE
- E. EXACT LOCATION OF ALL EQUIPMENT SHALL BE COORDINATED WITH NEXTEL, THE BUILDING OWNER AND OTHER TRADES.
- F. WHERE EQUIPMENT IS SPECIFIED BY MANUFACTURER AND TYPE, SUBSTITUTION SHALL ONLY BE MADE WITH THE APPROVAL OF THE ENGINEER. THE CONTRACT SHALL SUBMIT DETAILS OF PROPOSED MATERIALS, REASON FOR CHANGE AND CHANGE IN CONTRACT AMOUNT.

- A. THE CONTRACTOR SHALL PROVIDE ALL ELECTRICAL WIRING AND EQUIPMENT UNLESS OTHERWISE INDICATED. MAIN COMPONENTS ARE AS FOLLOWS:
- 1. PROVIDE ELECTRICAL SERVICE AS INDICATED ON THE DRAWINGS.
- 2. PROVIDE SERVICE EQUIPMENT MOUNTED AS INDICATED ON DRAWINGS.
- 3. PROVIDE TELEPHONE CONDUIT WITH PULL WIRE AS INDICATED ON DRAWINGS.
- 4. COORDINATE ELECTRICAL SERVICE WITH POWER CO. CONTACT REP. BEFORE STARTING 5. COORDINATE TELEPHONE SERVICE WITH LOCAL UTILITY PRIOR TO CONSTRUCTION.
- 6. DEMO EXIST. LIGHT POLE AND RE-USE FIXTURES AS INDICATED IN DRAWINGS.
- 7. INSTALL WIRE AND CONDUIT AS INDICATED.
- 8. PROVIDE GROUNDING AND LPS AS INDICATED ON DRAWINGS
- 9. RESTORE ALL AREAS TO ORIGINAL CONDITION AFTER INSTALLATION OF CONDUIT. CUI AND PATCH CONCRETE AND/OR ASPHALT AS REQUIRED.
- CONTRACTOR SHALL CLEARLY LABEL DISCONNECTS, METERS, BREAKERS, TELEPHONE TERMINAL BOX AND OTHER RELATED GEAR.

3.0 CONDUIT

- A. CONDUIT SIZES AS SHOWN ON THE DRAWINGS ARE A MINIMUM. THE CONTRACTOR MAY INCREASE AS REQUIRED FOR EASE OF PULLING.
- 1. ALL ABOVE GRADE CONDUIT SHALL BE RIGID GALVANIZED STEEL.
- 2. ALL CONDUIT BELOW GRADE SHALL BE SCHEDULE 40 PVC.
- C. ALL EXPOSED CONDUIT SHALL BE NEATLY INSTALLED AND RUN PARALLEL OR PERPENDICULAR TO STRUCTURAL ELEMENTS. SUPPORTS AND MOUNTING HARDWARE SHALL BE HOT DIPPED GALVANIZED STEEL CONDUITS SHALL HAVE BURRS REMOVED WITH A REAMER. CONDUITS ENTERING CABINETS SHALL HAVE LOCK NUTS INSIDE AND OUT UNLESS EN HAROLE IS THREADED. NYLON INSULATED BUSHINGS SHALL BE USED ON ALL CONDUIT TERMINATIONS.
- D. FLEX CONDUIT SHALL BE LIQUID TIGHT FLEXIBLE METALLIC CONDUIT.

A. CONDUCTORS SHALL BE STRANDED COPPER TYPE THWN OR XHHW WITH 75 DEGREE C RISE INSULATION OR AS INDICATED ON DRAWINGS.

- A. PROVIDE GROUND SYSTEM AS INDICATED ON THE DRAWINGS AND AS REQUIRED BY THE NATIONAL ELECTRIC CODE AND RADIO EQUIPMENT MANUFACTURER.
- THE RACEWAY SYSTEM SHALL BE CONTINUOUS FROM MAIN SWITCH GROUND BUSES TO PANEL GROUND BARS, AND FROM PANEL GROUNDING BARS TO BRANCH CIRCUIT OUTLETS, MOTORS, LICHTS, ETC. THESE GROUND CONDUCTORS ARE REQUIRED THROUGHOUT THE PROJECT REGARDLESS OF WHETHER CONDUIT RUNS SHOW GROUND

LIGHTNING PROTECTION SYSTEM (LPS) NOTES:

- PROVIDE A LPS RING BURIED A MINIMUM OF 18" BELOW GRADE, THE LPS OTHERWISE RING SHALL DE INSTALLED 2'-0" AWAY FROM FOUNDATION (MINIMUM UNLESS SHOWN
- 2. PROVIDED BRAIDED BONDING JUMPERS BETWEEN EACH GATE AND POST.
- 3. BOND FENCE POST TO LPS RING USING AN EXOTHERMIC WELD. BOND FENCE GATE TO POST WITH A FLEXIBLE COPPER JUMPER STRAP MECHANICALLY OR EXDITHERMICALLY, TYPICAL FOR ALL FENCE PLANES WITHIN 12 FEET OF TOWER FOUNDATION, FOR FENCE PLANES BEYOND 12, FXTRIN 1/2 TO EACH FENCE PLANE TO ANY PLANES WITHIN 50.
- 4. DISCONNECT SWITCH, METER, TELEPHONE CABINET AND SERVICE CONDUITS TO BE SEPARATELY BONDED TO $5/8^{\circ} \phi_{x1} 0' 0''$ Long ground rod
- 5. EACH LEG OF THE WAVEGUIDE STRUCTURE SHALL BE INDIVIDUALLY BONDED TO THE BURIED LPS RINGS AT THE TOWER AND SHELTER, EXOTHERMICALLY WELD CONNECTIONS AT POST FOR WAVEGUIGE STRUCTURE AND BURIED LPS RINGS, PLACE 5/6*X10' COPPERCLAD LPS ROD AT 10' INTERVALS ALONG WAVEGUIDE PATH.
- 6. BOND REBAR IN CONCRETE FOR COMMUNICATION STRUCTURE AND EQUIPMENT PAD TO BURIED LPS RING. EXOTHERMICALLY WELD A #Z AWG TINNED SOLID COPPER CONDUCTOR TO THE REBAR AND CONNECT TO THE BURIED LPS RING.
- 7. PROVIDE INSPECTION SLEEVE AT EACH BURIED LPS RING/GROUND ROD EXOTHERMIC CONNECTION AS SHOWN.
- PROVIDE BONDING CONDUCTOR(S) FROM THE BURIED LPS RING TO THE ANTENNA CABLE BUS BAR AT POINT JUST INSIDE OF THE COMMUNICATION STRUCTURE EXIT. VERIFY EXACT LOCATION OF COPPER BUS BAR FOR PROPER CONDUCTOR LENGTH. FINAL EXOTHERMIC WELDS TO COPPER BUS BAR BY THE ANTENNA CABLE INSTALLER.
- EXOTHERMICALLY WELD BONDING CONDUCTOR TO COMMUNICATION STRUCTURE LEG AT 1'-0' ABOVE PAD AND BOND TO BURIED LPS RING. PROVIDE A 3/4" PVC. SLEEVE WITH A GRADUAL BEND IN THE CONCRETE FOUNDATION.
- 5/8"X10"-0" LONG COPPER CLAD LPS ROD. 10' SPACING BETWEEN RODS (NON-LINEAR). TYPICAL FOR ALL LPS RODS SHOWN. USE STAINLESS STEEL HARDWARE WHERE APPLICABLE.
- ELECTRICAL CONTRACTOR SHALL TAKE MEGGER READINGS OF LPS. THE RESULTS SHALL NOT BE GREATER THAN 5 OHMS.
- ALL CONNECTIONS TO LPS SYSTEM SHALL BE MADE IN LINE WITH BENDS NOMINAL 12* RADIUS IN THE DIRECTION OF CURRENT FLOW. T-CONNECTIONS WILL NOT BE
- 13. ALL BENDS IN LPS WIRES SHALL BE NOMINAL 12" RADIUS.
- 14. ANTENNA CABLES SHALL BE BONDED AT EACH END. RUNS GREATER THAN 150' SHALL BE BONDED TOWARDS MIDDLE OF LENGTH. COORDINATE LOCATION WITH NEXTEL'S PROJECT MANAGER.
- 15. Existing tower ground ring exact location is unknown. Contractor to locate and identify prior to connection of bonding conductors. Hang dig only in investigation.

CALL 48 HOURS BEFORE YOU DIG

IT'S THE LAW!

-800-432-4770

SUNSHINE STATE ONE CALL OF FLORIDA, INC.

C&W engineering ELECTRICAL CONSULTANTS 2326 S. CONGRESS AVE., SUITE 1F WEST PALM BEACH, FL. 33406 (561) 642-5333

REGISTRATION NUMBERS

C & W ENGINEERING
DALE G. WALKER ELECTRICAL PE 36914
ELECTRICAL PE 17774



SUITE 700 FT. LAUDERDALE, FLORIDA 33309 (954) 275-2400



Kimley-Horn and Associates, Inc.

(C) 1998 KIMLEY-HORN AND ASSOCIATES, INC. PHONE: (561) 845 0665

REGISTRATION NUMBERS

KIMLEY HORN & ASSOCS., INC. FROOOO DAVID STEWART PE 31180 CHARLES GEER PE 31435 KIRK DROST PE 51910 RUSSELL MORRISON PE 51567



	REVI	SIONS		
	NO.	DATE	DESCRIPTION	
	Δ	2/19/01	480V SERVICE	
	◬	5/21/01	SHELTER/ SVC. UPGRADE	

SEAL

APPROVALS	
PROJECT MANAGER	DATE:
NEXTELRF:	DATE:
PROPERTY OWNER	DATE:


ANTENNA INSTALLATION AT WINSTON PARK FL 3672A


SCALE: AS SHOWN DESIGNED BY: JLR DRAWN BY: APPROVED BY: DGW DATE: MAY 200

> KHA PROJECT NUMBER 044201071 DRAWING NUMBER

SHEET TITLE ELETRICAL SITE PLAN

16 OF

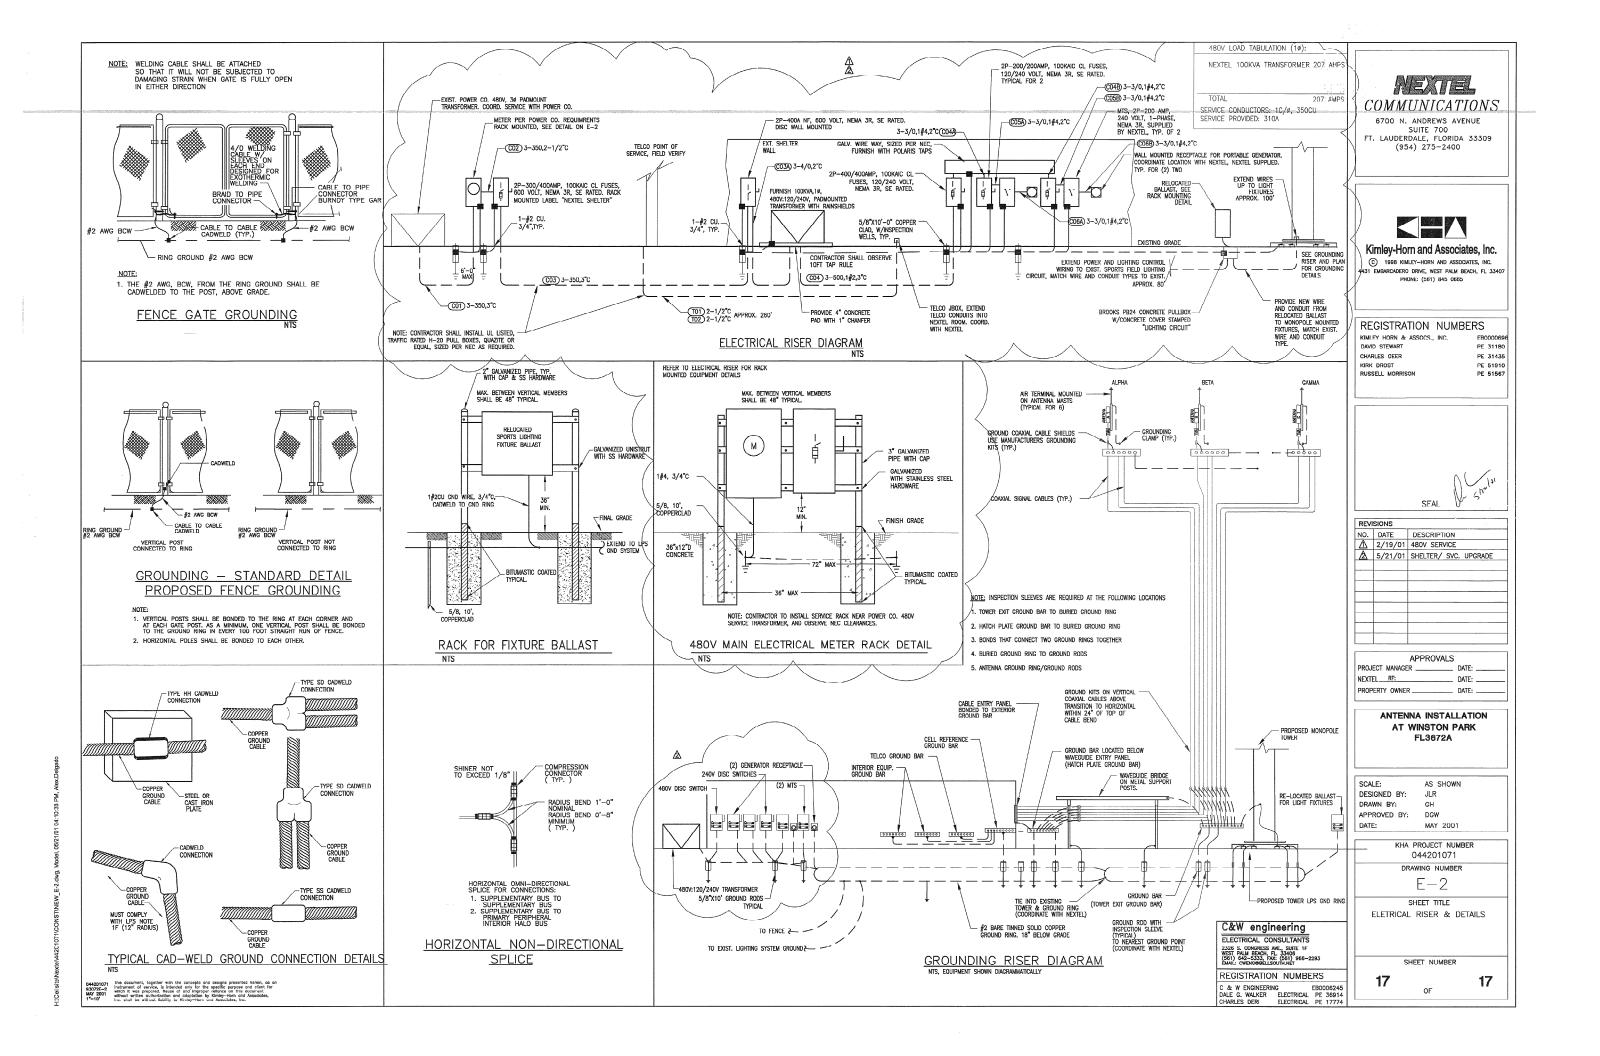

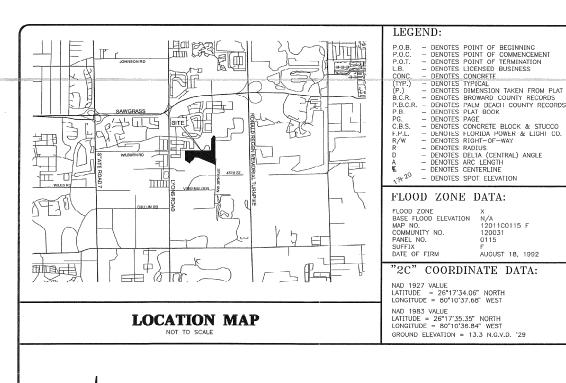

PARENT TRACT LEGAL DESCRIPTION:

N/A 12011C0115 F 120031 0115

R=90.00'

AUGUST 18, 1992

NL OF TRACT 'B' AND THAT CERTAIN 100 FOOT CANAL RIGHT-OF-WAY AS SHOWN ON WINSTON PARK SECTION TWO. ACCORDING TO THE PL
HEREOF AS RECORDED IN PLAT BOOK 156, PAGE 1 OF SAID PUBLIC RECORDS, TOGETHER WITH ALL OF PARCEL "E" AND A PORTION OF PARC
"C" AS SHOWN ON BANYANT RABLE, ACCORDING TO THE PLAT THEREOF AS RECORDED IN PLAT BOOK 154, PAGE 3, OF SAID PUBLIC RECORD
TIGGETHER WITH ALL OF PARCEL "B". COCOL AKES, ACCORDING TO THE PLAT THEREOF AS RECORDED IN PLAT BOOK 155, PAGE 25 OF THE
PUBLIC RECORDS OF BROWAND COUNTY, ELORIDA, TOGETHER WITH A PORTION OF THAT CERTAIN IS FOOT BOOK SESTRATION AS VACAT
BY OFFICIAL RECORDS BOOK-15870, PAGE 4 OF SAID PUBLIC RECORDS-TOGETHER WITH A PORTION-OFTHAT CERTAIN ROAD RESERVATION. - DENOTES POINT OF BEGINNING
- DENOTES POINT OF COMMENCEMENT
- DENOTES POINT OF TERMINATION
- DENOTES LICENSED BUSINESS DENOTES CONCRETE
DENOTES CONCRETE
DENOTES TYPICAL
DENOTES TYPICAL
DENOTES BIMENSION TAKEN FROM PLAT
DENOTES BROWARD COUNTY RECORDS
DENOTES PLAT BOOK
DENOTES PLAT BOOK S SHOWN OF THE PLAT OF PALM BEACH FARMS COMPANY PLAT NO. 3, AS RECORDED IN PLAT BOOK 3, PAGES 45 THRU 54 (INCLUSIVE) O UBLIC RECORDS OF PALM BEACH COUNTY, FLORIDA AND BEING MORE PARTICULARLY DESCRIBED AS FOLLOWS:* SEE NOTE BELOW

0.510 (WEST), A DISTANCE OF 21 48 FEET, THENDE NORTH 81 3840 WEST, A DISTANCE OF 14.58 FEET, THENGE SOUTH 52 1925 WEST, A DISTANCE OF 14.58 FEET, THENGE SOUTH 52 1925 WEST, A DISTANCE OF 12.68 FEET, THENGE SOUTH 52 5935 WEST, A DISTANCE OF 12.60 FEET, THENGE SOUTH 52 1925 WEST, A DISTANCE OF 19.5 FEET, THENGE SOUTH 52 1925 WEST, A DISTANCE OF 19.5 FEET, THENGE NORTH 52 70 STORTH EREOF, ADISTANCE OF 403.5FEET TO THE SOUTHEAST CORNER OF LOT \$4 OF SAID WINSTON PARK SECTION TWO: THENCENORTH 00°2454 ST. ALLONG THE EAST BOUNDARY OF SAID LOT 54 AND THE NORTHERLY PROJECTION THEREOF, ALSO BEING ALONG THE WEST BOUNDARY SAID PARCEL: "2." A DISTANCE OF 674.88 FEET TO THE NORTHWEST CORNER OF SAID PARCEL: "2": THENCE NORTH 89°270°3" EAST, ALONG SAID PARCEL TO ADITATIVE OF 29 ABSPECT TO THE MORTHWEST COINIER OF SAID PARCEL TO THE WORTH STOTYME LAST. ALONG THE MORTHAND ANY OF SAID PARCEL TO ADITATIVE SAID THE MORTHAND ANY OF SAID PARCEL TO ADITATIVE SAID THE MORTHAND ANY OF SAID PARCEL TO ADITATIVE SAID THE MORTHAND ANY OF SAID THAT THE SAID THE SAID THE SAID THE SAID THE SAID THE SAID THE SAID THE SAID THE SAID THE SAID THE SAID THE SAID THE SAID THE SAID THE SAID THE SAID THE SAID THE SAID THE SAID THAT THE SAID THE SAID THAT THAT THE SAID THAT THAT THE SAID THAT THE SAID THAT THAT THE SAID THAT THAT THE SAID THAT THAT THE SAID THAT THAT THE SAID THAT THAT THE SAID THAT THAT THE SAID THAT THAT THE SAID THAT THE SAID THAT THE SAID THAT THE SAID THAT THE SAID THAT THE SAID THAT THE SAID THAT THE SAID THAT THE SAID THAT THE SAID THAT THE SAID THAT THE SAID THAT THE SAID THAT THE SAID THAT THE SAID THAT THE SAID THAT THE SAID THAT THE SAID THA INT OF CURRATURE OF A CIRCULAR CURVE TO THE RIGHT, THENCE MORTHEASTERLY, EASTERLY AND SOUTHEASTERLY, ALONG THE ARE SAID CURVE, HAVING A RABIUS OF 25.00 FEET AND A CENTRAL ANGLE OF 55 '1028', A DISTANCE OF 258.2 TO A POINT OF REVERSE RVATURE; THENCE SOUTHEASTERLY, EASTERLY AND NORTHEASTERLY, ALONG THE ARC OF SAID CURVE, HAVING A RADIUS OF 90.00 FEET O A CENTRAL ANALE OF 72.5°23", A DISTANCE OF 114.47 FEET TO A POINT OF REVERSE CURVATURE; HENCE NORTHEASTERLY AND STERLY ALONG THE ARC OF SAID CURVE. HAVING A RADIUS OF 25.00 FEET AND A CENTRAL ANGLE OF 38' 1807". A DISTANCE OF 16.71 FEET THE POINT OF TANGENCY. THENCE NORTH AS 3'33" EAST, A DISTANCE OF 19.16 FEET TO THE NORTHWEST CORNER OF SAID PARCEL 18' TRADIUS POINT OF THE NEXT DESCRIBED CURVE BEARS SOUTH 60' 3'30" "WEST FROM SAID CONNER, THENCE EASTERLY SOUTHEASTERLY. ET TO THE PONT OF TANGENCY, THENCE SOUTH 00 50°22" EAST, A DISTANCE OF 339.95 FEET TO THE POINT OF BEGINNING, THE DESCRIBED COURSES BEING ALONG THE WESTERLY BOUNDARY OF N.W. 39" AVENUE AS SHOWN ON SAID COCO LAKES PLAT

NOTE: PARCEL "D", BANYAN TRAILS, PLAT BOOK 154, PAGE 3 AS RECORDED IN THE PUBLIC RECORDS OF BROWARD COUNTY, FLORIDA, WAS

PORTION OF PARCEL "D" OF BANYAN TRAILS, AS RECORDED IN PLAT BOOK 154, PAGE 3 OF THE PUBLIC RECORDS OF BROWARD COUNTY

COMMENCE AT THE NORTHEAST CORNER OF PARCEL "E" OF SAID BANYAN TRAILS; THENCE SOUTH 00°50'12" EAST, ALONG THE EAST LINE AID PARCEL "E", SAID EAST LINE ALSO BEING THE WEST RIGHT-OF-WAY LINE OF N.W. 39TH AVENUE, A DISTANCE OF 440.30 FEET, THEN OUTH 86'09'84" WEST, A DISTANCE OF 289'8 FEET, TO THE POINT OF BEGINNING OF THE POLLOWING DESCREED MAKEL LEASE SITE:

THENCE NORTH 60°44'49" WEST, A DISTANCE OF 48.00 FEET; THENCE NORTH 28°16'11" EAST, A DISTANCE OF 14.34 FEET; THENCE NORTH 88°08'42" EAST, A DISTANCE OF 11 28 FEET; THENCE SOUTH 60°44'49" EAST, A DISTANCE OF 28.77 FEFT; THENCE SOUTH 60°60'18" FAST, A DISTANCE OF 16.88 FEET; THENCE SOUTH 29°11'14 WEST, A DISTANCE OF SOFFEET, TO THE POINT OF BEGINNIG. ONTAINING 871 SQUARE FFET OR 0.0200 ACRES, MORE OR LESS.

NEXTEL ACCESS EASEMENT LEGAL DESCRIPTION

A STRIP OF LAND 20 DIEFET IN WIDTH, FOR ACCESS FASEMENT PURPOSES, SAID STRIPL VING WITHIN A PORTLON OF PARCEL 1911/JE BANYAN
TRAILS, AS RECORDED IN PLAT BOOK 154, PAGE 3 OF THE PUBLIC RECORDS OF BROWNER COUNTY, ACTION OF TRAIL CHARLAGE
CERTAIN 100 POOT CANAL RIGHT-OF-WAY AS SHOWN ON WINST ON PARK SECTION TWO, AS RECORDED IN PLAT BOOK 158, PAGE 1, OT SAID
PUBLIC RECORDS OF BROWNER COUNTY, FLORIDA, APPORTING OF AS SECON TRIGHT-OF-WAY, AS SHOWN ON THE PLAT OF PARM BEACH COUNTY, FLORIDA, AND A
COMPANY'S PLAT NO. 2, PLAT BOOK 2, PAGES 45 THROUGH 54, INCLUSINE, PUBLIC RECORDS OF PAIN SEACH COUNTY, FLORIDA, AND A
PORTUNAL OF BARRED SECONDATA MAY AS SHOWN OF THE PLAT OF PARM SEACH COUNTY, FLORIDA, AND A
PORTUNAL OF BARRED SECONDATA MAY AS SHOWN OF THE PLAT OF PARM SEACH COUNTY, FLORIDA, AND A
PORTUNAL OF BARRED SECONDATA MAY AS SHOWN OF THE PLAT OF PARM SEACH COUNTY, FLORIDA, AND A
PORTUNAL OF BARRED SECONDATA MAY AS SHOWN OF THE PLAT OF THE PLAT OF PARM SEACH COUNTY, FLORIDA, AND A
PORTUNAL OF BARRED SECONDATA MAY AS SHOWN OF THE PLAT OF THE

COMMENCE AT THE SOUTHEASTERLY CORNER (POINT OF BEGINNING) OF THE PREVIOUSLY DESCRIBED NEXTELLEASE SITE; THENCE NORTH 80°4440° WEST, ALONG THE SOUTHWESTERLY LINE OF SAID NEXTELLEASE SITE, DISTANCE OF 48.00 FEET; THENCE; NORTH 20°1511° EAST, ALONG THE NORTHWESTERLY LINE OF SAID NEXTELLEASE SITE, A DISTANCE OF 10.00 FEET, TO THE POINT OF BEGINNING OF THE FOLLOWING DESCRIBED CENTRELINE:

THENCE NORTH 80°4449' WEST, DEPARTING SAID NORTHWESTERLY LINE, A DISTANCE OF 2.00 FEET; THENCE NORTH 00°5540' WEST, DISTANCE OF 46.78 FEET; THENCE NORTH 90°5540' WEST, A DISTANCE OF 17.75 FEET, TO THE BEGINNING OF A CURVE CONCAVE TO TH NORTHEAST AND HAWING A RADIUS OF 15.00 FEET; THENCE WESTERLY, NORTHEAST AND HAWING A RADIUS OF 15.00 FEET; THENCE WESTERLY, NORTHEAST AND HAWING A RADIUS OF 15.00 FEET; THENCE WESTERLY, NORTHEAST AND HAWING A RADIUS OF 15.00 FEET; THENCE WESTERLY, NORTHEAST AND HAWING A RADIUS OF 15.00 FEET; THENCE WESTERLY, NORTHEAST AND HAWING A RADIUS OF 15.00 FEET; THENCE WESTERLY, NORTHEAST AND HAWING A RADIUS OF 15.00 FEET; THENCE WESTERLY, NORTHEAST AND HAWING A RADIUS OF 15.00 FEET; THENCE WESTERLY, NORTHEAST AND HAWING A RADIUS OF 15.00 FEET; THENCE WESTERLY, NORTHEAST AND HAWING A RADIUS OF 15.00 FEET; THENCE WESTERLY, NORTHEAST AND HAWING A RADIUS OF 15.00 FEET; THENCE WESTERLY, NORTHEAST AND HAWING A RADIUS OF 15.00 FEET; THENCE WESTERLY, NORTHEAST AND HAWING A RADIUS OF 15.00 FEET; THENCE WESTERLY, NORTHEAST AND HAWING A RADIUS OF 15.00 FEET; THENCE WESTERLY, NORTHEAST AND HAWING THE THENCE WESTERLY OF 15.00 FEET; THENCE WESTERLY, NORTH AND HAWING THE THENCE WESTERLY. DISTANCE OF 40.0 PERTY. HENCE NUTTI 99 39.3 WEST, A DISTANCE OF 117, FEEL, 10 THE SERMINN OF A CUTVE CONCAVE 10 THE NOTTIFICATE OF THE NOTTIFICATION OF THE

- NOT VALID WITHOUT THE SIGNATURE AND THE ORIGINAL RAISED SEAL OF A FLORIDALICENSED SURVEYOR AND MAPPER, NO ABSTRACT OF THE PUBLIC RECORDS FOR EASEMENTS OR RIGHTS-OF-WAY WAS PROVIDED TO OR CONDUCTED BY THIS OFFICE. ROAD AND STAND TO THE PUBLIC RECORDS FOR EASEMENTS OR RIGHTS-OF-WAY WAS PROVIDED TO OR CONDUCTED BY THIS OFFICE. BENCHMARK USED: THE BENCHMARK USED IS A BROWARD COUNTY ENGINEERING DIVISION BENCHMARK NO.2754, WHICH IS A STANDARD BRASS CAP STAMPED BIM \$280 IN STANDARD GO'S "X 4" CONCRETE MONUMENT, 4"S SOUTH OF CENTERLINE VINKEMULDER ROAD AND 5" EAST OF EAST OF EAST PAYMENT NORTHWEST 39" AVENUE (UNDER TRADEWINDS PARK SIGN), PUBLISHED ELEVATION BY THE BROWARD COUNTY BRGINEERING DIVISION IS ELEVATION 15.131 N.G. V.D. 1929.

 THIS SHCTIO HERPTESCHTS A DOUBLARY SURVEY OF THE INCEXTLE LEASE SITE ONLY.

 ABOVE GROUND IMPROVEMENTS WERE LOCATED ONLY AS SPECIFIED BY NEXTEL AND SUBCONTRACTORS.

 BECANINGS SHOWN HEREON AND RED SED ON A GRID BEARING OF NORTHAY 5" 915" WEST BETWEEN POINT ED 78ND E08 OF THE EASTERN BROWARD COUNTY HORIZONTAL GT'S CONTROL HER TWORK (NADSSIGD), THE GRID BEART ZONE, TRANSVERSE MERCATOR PROJECTION OF PROVIDED AND THE BEARD OF A DEPOSIT OF THE SENSE OF THE SENSE WERE CATOR PROJECTION.

 THE GUITVEY INFORMATION FOR THE PARENT TRACT, AS SHOWN HEREON, IS BASED UPON A BOUNDARY, TOPOGRAPHIC AND TREE SURVEY BY GRAVEN THOMPSON A SASSOCIATES, INC. OF SABAL PINES PARK PROJECT NO, 98-0046 ADDITION FOR THE SENSE OUTH 00" 5022" EAST ALONG THE EASTERY BOUNDARY OF PARCELT*, AS SHOWN HEREON, SHOWN HEREON, SHOWN HEREON FROM SHID SURVEY BEARINGS AND REPARK PROJECT NO, 98-0046 AS ROTATED O'O'D "COUNTER CLOCKWISE FROM THE GRID BEARNING SOUTH 00" 5022" EAST (SURVEY BEARINGS ARE ROTATED O'O'D "O'O O'D' O'O'D' COUNTER CLOCKWISE FROM THE GRID BEARNING SOUTH 00" 5022" EAST (SURVEY BEARNINGS ARE ROTATED O'O'D "O'O'O'D' COUNTER CLOCKWISE FROM THE GRID BEARNING SOUTH 00" 5022" EAST (SURVEY BEARNINGS ARE ROTATED O'O'D "O'O'O'O' O'O'O' TE EAST ING REFERENCED SURVEY BEARNINGS ARE ROTATED O'O'D' O'O'O' O'O'O' TE COUNTER COU

CERTIFICATION:

I HEREBY CERTIFY THAT THE BOUNDARY AND TOPOGRAPHIC SURVEY SHOWN HEREON MEETS THE MINIMUM TECHNICAL STANDARDS FOR SURVEYING IN THE STATE OF FLORIDA AS SET FORTH BY THE FLORIDA BOARD OF PROFESSIONAL SURVEYORS AND MAPPERS IN CHAPTER STIGT, FLORIDA ADMINISTRATURE CODE, PURSUANT TO SECTION 472.027 FLORIDA STATUTES.



DATE OF LAST FIELD WORK: MAY 18, 2001

CV

367

1 24

FL PAJ

STAON

BOUNDARY A LEASE SITE I NEXTEI TP/WIN BROWARD

 A_{A}

MP.

CO J

\$ E

L.FISH

N.O.

DRAWN:

DATE:

JOB NO.

M. LA TOUR

W. L. FISH

05/18/2001

2000-284A SHEET NO.

2 OF 17

CHECKED:

