DRAWING INDEX

ELECTRICAL DRAWINGS

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DONALDSON PARK PARKING LOT LIGHTING PROJECT FOR THE CITY OF COCONUT CREEK



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REVISIONS

DESCRIPTION

NO. DATE BY CHK'D

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R.J.Behar & Company, Inc. Engineers • Planners


6861 S.W. 196th Avenue, Suite 302 Pembroke Pines, Florida · 33332 (954) 680-7771 · Fax: (954) 680-7781

> RODOLFO HOYOS, P.E. NO. 47056 Progressive Design & Engineering, Inc. 10891 La Reina Road Telt 561-498

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 Tet: 561-498-2304

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 Defray Beach, FL 33446
 CERTIFICATE OF AUTHORIZATION NO. 7151

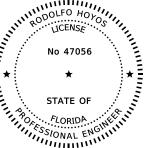


THIS ITEM HAS BEEN DIGITALLY SIGNED AND SEALED BY:

ON THE DATE ADJANCENT TO THE SEAL.

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CITY OF COCONUT CREEK PUBLIC WORKS DEPARTMENT

CITY OF COCONUT CREEK OFFICIALS

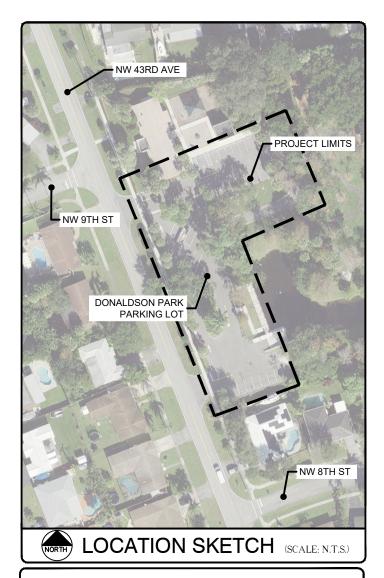JOSHUA RYDELL SANDRA L. WELCH BECKY TOOLEY JACKIE RAILEY JOHN A. BRODIE KAREN BROOKS BRIAN ROSEN MAYOR VICE MAYOR COMMISSIONER COMMISSIONER COMMISSIONER CITY MANAGER CITY PROJECT MANAGER

RODOLFO HOYOS, P.E.
LIGHTNOT NO. HOMA

05, P.E. 056

DATE: September 13, 2022

SHEET NAME: G001

R.J. BEHAR PROJECT No.: 22038

100% PLAN SET

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G001

LIGHTING NOTES:

- 1. THE MAINTAINING AGENCY FOR THE LIGHTING SYSTEM IS THE CITY OF COCONUT CREEK.
- 2. GOVERNING STANDARDS AND SPECIFICATIONS ARE: THE F.D.O.T. STANDARD PLANS, THE FLORIDA DEPARTMENT OF TRANSPORTATION STANDARD SPECIFICATIONS FOR ROAD AND BRIDGE CONSTRUCTION, THE NATIONAL ELECTRIC CODE, AND THE NATIONAL ELECTRICAL SAFETY CODE OR LATER EDITION AND LOCAL CODES WHICH EXCEED THESE SPECIFICATIONS
- 3. ENDS OF EXISTING/NEW CONDUITS SHALL BE SEALED WITH POLYURETHANE FOAM AFTER WIRING IS COMPLETE. FOAM SEAL SHALL NOT BE USED AS A MEANS TO PROTECT CONDUCTORS FROM ABRASION IN RACEWAYS.
- 4. A SLUG SHALL BE INSERTED IN THE GROUNDED (NEUTRAL SIDE) OF FUSEHOLERS
- 5. GROUND CONDUCTOR, IF NEEDED, SHALL HAVE A GREEN JACKET, TYPE THWN-2, AND SHALL NOT BE SMALLER THAN NO. 6 AWG.
- 6. LIGHT POLE FOUNDATION SHALL BE CONCRETE AS PER INDEX 715-002 AND DETAILS IN PLANS.
- 7. LIGHT POLE FOUNDATIONS SHALL BE INSTALLED AT A GRADE THAT IS FLUSH WITH THE ADJACENT AND SURROUNDING SIDEWALK.
- 8. THE POLE FOUNDATION CONDUITS SHALL EXTEND FROM 1" TO 2" INSIDE THE POLE BASE.
- 9. ONCE THE LIGHTING SYSTEM IS SUBSTANTIALLY COMPLETE, THE CONTRACTOR SHALL CONTACT THE ENGINEER FOR A FINAL INSPECTION OF THE LIGHTING CONSTRUCTION.
- 10. THE LOCATION OF THE UTILITIES SHOWN IN THE PLANS ARE APPROXIMATE. THE EXACT LOCATION SHALL BE DETERMINED BY THE CONTRACTOR AND THE UTILITY OWNERS DURING CONSTRUCTION.
- 11. SUBMITTAL DATA PRIOR TO ANY PROCUREMENT ORDER THE CONTRACTOR SHALL SUBMIT FOR APPROVAL, EQUIPMENT SPECIFICATIONS OR DESIGN DATA FOR ALL MATERIALS PROPOSED FOR THE PROJECT AND SHALL INCLUDE. BUT NOT LIMITED TO:
 - CONDUCTORS, CONDUIT, GROUND RODS AND PULL BOXES.
- В. FUSES, FUSE HOLDERS, SURGE PROTECTORS AND POLE CABLE DISTRIBUTION SYSTEMS.
- STRUCTURAL CALCULATIONS FOR LIGHT POLE ASSEMBLY SHOWING IT MEETS 160 MPH WIND LOAD. C CALCULATIONS SHALL BE SIGNED AND SEALED BY A FLORIDA LICENSED ENGINEER.


SUBMIT THE SHOP DRAWINGS AND DESIGN DATA DIGITALLY TO THE ENGINEER, ALLOW A 15 DAY TURNAROUND FOR SUBMITTALS.

- 12. ALL FEATURES IMPACTED DURING THE CONSTRUCTION OF THE LIGHTING SYSTEM (LANDSCAPING, IRRIGATION, SIDEWALK, ETC.) SHALL BE RESTORED TO ITS ORIGINAL CONDITION, AS A MINIMUM.
- 13. THE CONTRACTOR SHALL NOTIFY UTILITY OWNERS THROUGH SUNSHINE ONE CALL OF FLORIDA INC. (1-800-432-4770) AND UTILITY OWNERS LISTED BELOW 2 FULL BUSINESS DAYS IN ADVANCE OF BEGINNING CONSTRUCTION ON THE JOB SITE;

UTILITY OWNERS TELEPHONE NUMBERS CONTACT PERSON COMCAST CABLE 786-586-8505 RICARDO DAVIDSON CITY OF COCONUT CREEK 954-545-6655 EILEEN CABRERA CITY OF MARGATE 954-972-0828 FXT 237 RANDY DANIFI FLORIDA POWER & LIGHT-BROWARD 386-586-6403 JOEL BRAY 561-683-2729 DINO FARRUGGIO AT&T DISTRIBUTION

14. CONTRACTOR SHALL ENSURE THAT LIGHT POLES INTENDED TO HAVE TYPE III AND TYPE V DISTRIBUTIONS ARE INSTALLED CORRECTLY ON EACH POLE, SEE NOTE 3 UNDER POLE DATA TABLE. CONTRACTOR SHALL DEMONSTRATE THIS AT THE FINAL INSPECTION.

LEGEND AND DESCRIPTION

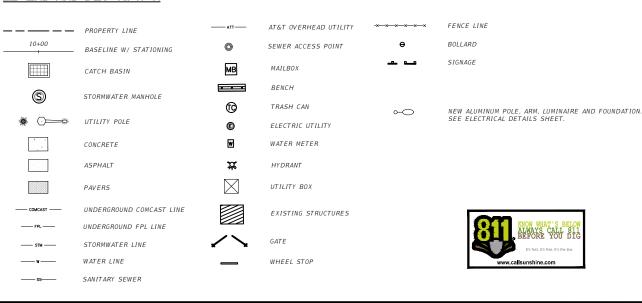

GENERAL NOTES:

- 1. ALL CONSTRUCTION AND MATERIALS SHALL CONFORM TO THE STANDARDS AND SPECIFICATIONS OF THE CITY OF COCONUT CREEK, FLORIDA DEPARTMENT OF TRANSPORTATION, FLORIDA DEPARTMENT OF ENVIRONMENTAL PROTECTION, BROWARD COUNTY HEALTH DEPARTMENT, BROWARD COUNTY DEPARTMENT OF ENVIRONMENTAL PROTECTION AND GROWTH MANAGEMENT, FLORIDA BUILDING CODE (LATEST EDITION), AND ALL OTHER LOCAL AND NATIONAL CODES WHERE APPLICABLE.
- 2. ALL CONSTRUCTION SHALL BE DONE IN A SAFE MANNER, SPECIFICALLY, THE RULES AND REGULATIONS OF THE OCCUPATIONAL SAFETY AND HEALTH ADMINISTRATION AND THE MANUAL OF UNIFORM TRAFFIC CONTROL DEVICES SHALL BE STRICTLY OBSERVED.
- 3. ALL ELEVATIONS ON THE DRAWINGS OR REFERENCED IN THE SPECIFICATIONS ARE BASED ON NORTH AMERICAN VERTICAL DATUM OF 1988.
- 4. THE CONTRACTOR SHALL OBTAIN THE SERVICES OF A UTILITY LOCATION SERVICE SUCH AS "SUNSHINE STATE ONE CALL OF FLA. INC." AT (800) 432-4770 AT LEAST 48 HOURS PRIOR TO REGINNING ANY EXCAVATION
- 5. EXISTING UTILITY LOCATIONS SHOWN ON THESE DRAWINGS ARE APPROXIMATE. THE ENGINEER ASSUMES NO RESPONSIBILITY FOR THE ACCURACY OF EXISTING UTILITIES SHOWN OF FOR ANY EXISTING UTILITIES NOT SHOWN
- 6. PRIOR TO BEGINNING CONSTRUCTION, THE CONTRACTOR SHALL VERIFY THE SIZE LOCATION AND MATERIAL OF ALL EXISTING UTILITIES WITHIN THE AREA OF CONSTRUCTION
- 7. IF UPON EXCAVATION, AN EXISTING UTILITY IS FOUND TO BE IN CONFLICT WITH THE PROPOSED CONSTRUCTION OR TO BE OF A SIZE OR MATERIAL DIFFERENT FROM THAT SHOWN ON THE DRAWINGS, THE CONTRACTOR SHALL IMMEDIATELY NOTIFY THE ENGINEER
- 8. THE CONTRACTOR SHALL PERFORM ALL WORK NECESSARY TO LOCATE, EXCAVATE AND PREPARE FOR CONNECTIONS TO THE EXISTING SYSTEMS. ALL AS SHOWN ON THE DRAWINGS. THE COST FOR THIS WORK AND FOR THE ACTUAL CONNECTION TO THE EXISTING SYSTEMS SHALL BE INCLUDED IN THE BID PRICE FOR THE PROJECT AND SHALL NOT RESULT IN ANY ADDITIONAL COST TO THE OWNER.
- 9. CONTRACTOR MUST PROVIDE FOR AND MAINTAIN ADEQUATE ACCESS AT ALL TIMES TO ALL BUSINESSES AND RESIDENCES AFFECTED BY PROGRESS OF THE WORK
- 10. CONTRACTOR SHALL BE RESPONSIBLE TO REPAIR ANY DAMAGED INFRASTRUCTURE OR LANDSCAPE CAUSED BY THE CONSTRUCTION.
- 11. PROJECT SITE SAFETY:
- A. THE CONTRACTOR IS SOLELY RESPONSIBLE FOR JOBSITE SAFETY, AND WARRANTS THAT THIS INTENT IS MADE EVIDENT BY THE AGREEMENT BETWEEN OWNER AND CONTRACTOR.
- B. ALL EXISTING OVERHEAD AND UNDERGROUND UTILITIES SHOWN ON THESE DRAWINGS OR ENCOUNTERED THROUGH THE PROGRESSION OF WORK AT THIS PROJECT SITE ARE ASSUMED TO BE LIVE, CONTRACTOR SHALL BE RESPONSIBLE FOR ALL SAFETY PRECAUTIONS WHEN WORKING AROUND EXISTING OVERHEAD OR UNDERGROUND UTILITIES. VALVE BOXES AND MANHOLE RIM ELEVATIONS SHOWN ARE APPROXIMATE.

POLE DATA

POLE NO.	CIRCUIT	STATION	DIST. OR ARM	LUMINAIRE WATTAGE	MOUNTING HEIGHT	POLE SETBACK	PAY ITEM
1	EXIST	STA. 1+56 LT B	20 IN	105W	12 FT	SEE NOTE 2	715-536-110
2	EXIST	STA. 1+68 RT B	20 IN	105W	12 FT	SEE NOTE 2	715-536-110
3	EXIST	STA. 1+85 RT B	20 IN	105W	12 FT	SEE NOTE 2	715-536-110
4	EXIST	STA. 2+13 LT B	20 IN	105W	12 FT	SEE NOTE 2	715-536-110
5	EXIST	STA. 0+82 RT B	20 IN	105W	12 FT	SEE NOTE 2	715-536-110
6	EXIST	STA. 0+36 RT B	20 IN	105W	12 FT	SEE NOTE 2	715-536-110
7	EXIST	STA. 2+23 RT B	20 IN	105W	12 FT	SEE NOTE 2	715-536-110
8	EXIST	STA. 1+38 LT B	20 IN	105W	12 FT	SEE NOTE 2	715-536-110
9	EXIST	STA. 0+65 RT B	20 IN	105W	12 FT	SEE NOTE 2	715-536-110

NOTES:

1 POLE SETBACK IS THE DISTANCE MEASURED FROM EDGE OF S/W OR ASPHALT TO THE FACE OF POLE

2. LIGHT POLE SHOULD BE REPLACED AT EXISTING LOCATION, MAINTAIN, AT MINIMUM, THE SAME SETBACK DISTANCE FROM THE EDGE OF THE ASPHALT PARKING AREA TO THE FACE OF THE LIGHT POLE.

3. LUMINAIRES FOR POLES 1, 4, & 6 SHALL HAVE A TYPE III DISTRIBUTION AND BE REFERRED TO AS LUMINAIRE TYPE C. LUMINAIRES FOR POLES 2, 3, 5, 7, 8, & 9 SHALL HAVE A TYPE V DISTRIBUTION AND BE REFERRED TO AS LUMINAIRE TYPE D.

WIND LOAD DESIGN CRITERIA

WIND SPEED 160 MPH


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	Engineers.Planners. Bestswigthars. Bestswigthars. PENBROKE NWES.FL 3332 PENBROKE NWES.FL 33322 PH:94-880-7771, FAX: 954-880-7781
	POLE DATA, LEGEND & NOTES DONALDSON PARK PARKING LOT LIGHTING CITY OF COCONUT CREEK 100% PLANS
	RJB Proj. Ne: 22038 Data: August 18, 2022 Design: DRAWN: CHECK: RUDY AS HM REVISIONS:
	SHEET NAME: G002
-	SHEET 2 OF 4

CONSULTANT:	
RODOLFO HOYOS	
P.E. LICENSE NO. 4705	6

DATE:




TABULATION OF QUANTITIES					
PAY ITEM	DESCRIPTION	UNIT	TOTAL		
NO .	DESCRIPTION	UNIT	PLAN	FINAL	
630-2-11	CONDUIT, FURNISH & INSTALL, OPEN TRENCH (1" SCH 40 PVC)	LF	27		
715-10-2	LIGHT POLE FOUNDATION, F&I	EA	9		
715-69-000	LIGHT POLE COMPLETE, REMOVE POLE AND FOUNDATION	EA	9		
715-500-1	POLE CABLE DISTRIBUTION SYSTEM, CONVENTIONAL	EA	9		
715-536-110	LIGHT POLE COMPLETE- SPECIAL DESIGN, INSTALL, POLE TOP MOUNT, ALUMINUM, 12'	EA	9		

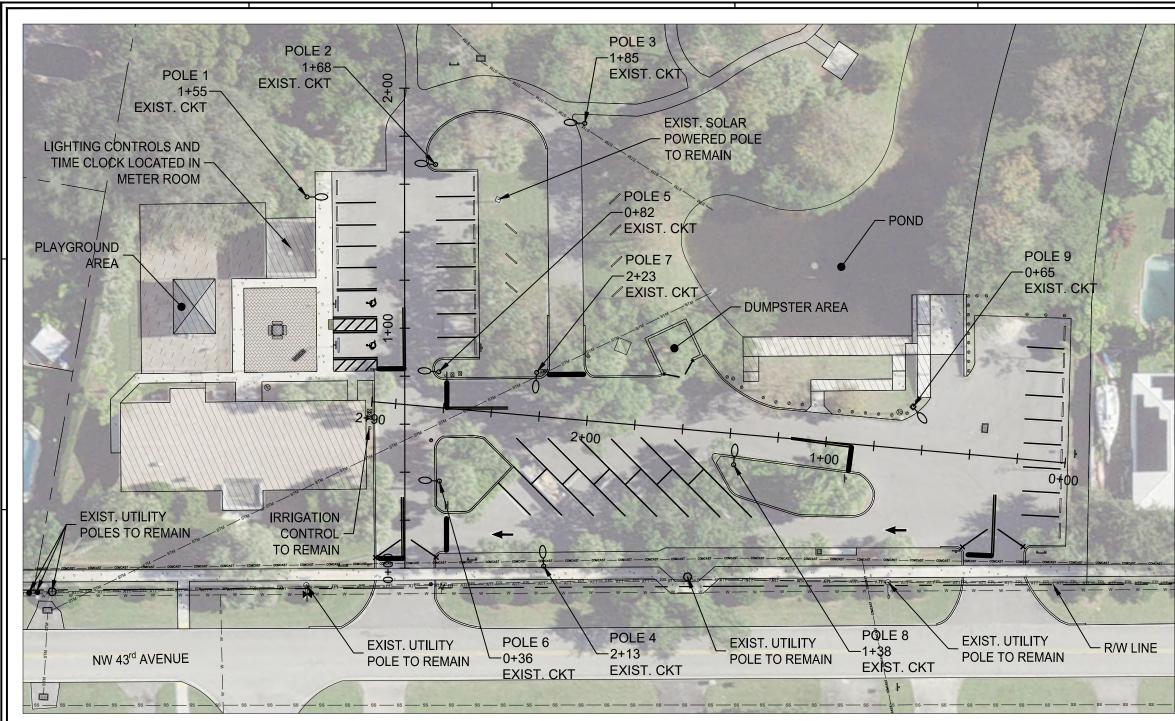630-2-11 INCLUDES THE COST OF 3 LF OF CONDUIT FROM PULL BOX TO LIGHT POLE AT EACH LOCATION.

715-69-000 INCLUDES THE REMOVAL AND DISPOSAL OF COMPLETE LIGHT POLE AND CONCRETE FOOTING.

715-536-110 CITY OF COCONUT CREEK WILL ADVANCE PROCURE THE LIGHT POLE ASSEMBLIES. INCLUDES THE COST OF OBTAINING LIGHT POLES AND TRANSPORTING THEM TO THE JOB SITE. LIGHT POLES WILL BE STORED AT THE CITY OF COCONUT CREEK, 4900 WEST COPANS ROAD. CONTACT BRIAN ROSEN AT (954) 545-6614 TO COORDINATE.

GRAPHIC SCALE	R.J.Behar & Company, Inc. Engineers.Planners Bestsw.196TH AVE. SUITE 302 PH: 954-800-7771, FAX: 554-800-7781
0 20 40 80 (IN FEET) 1"=40'	
	LICHTING PLAN & QUANTITIES LICHTING PLAN & QUANTITIES DONALDSON PARK PARKING LOT LIGHTING CITY OF COCONUT CREEK MAXING LOT LIGHTING CITY OF COCONUT CREEK MAXING PLANS PRELIVANE:
CONSULTANT:	E001
RODOLFO HOYOS DATE: P.E. LICENSE NO. 47056	SHEET 3 OF 4

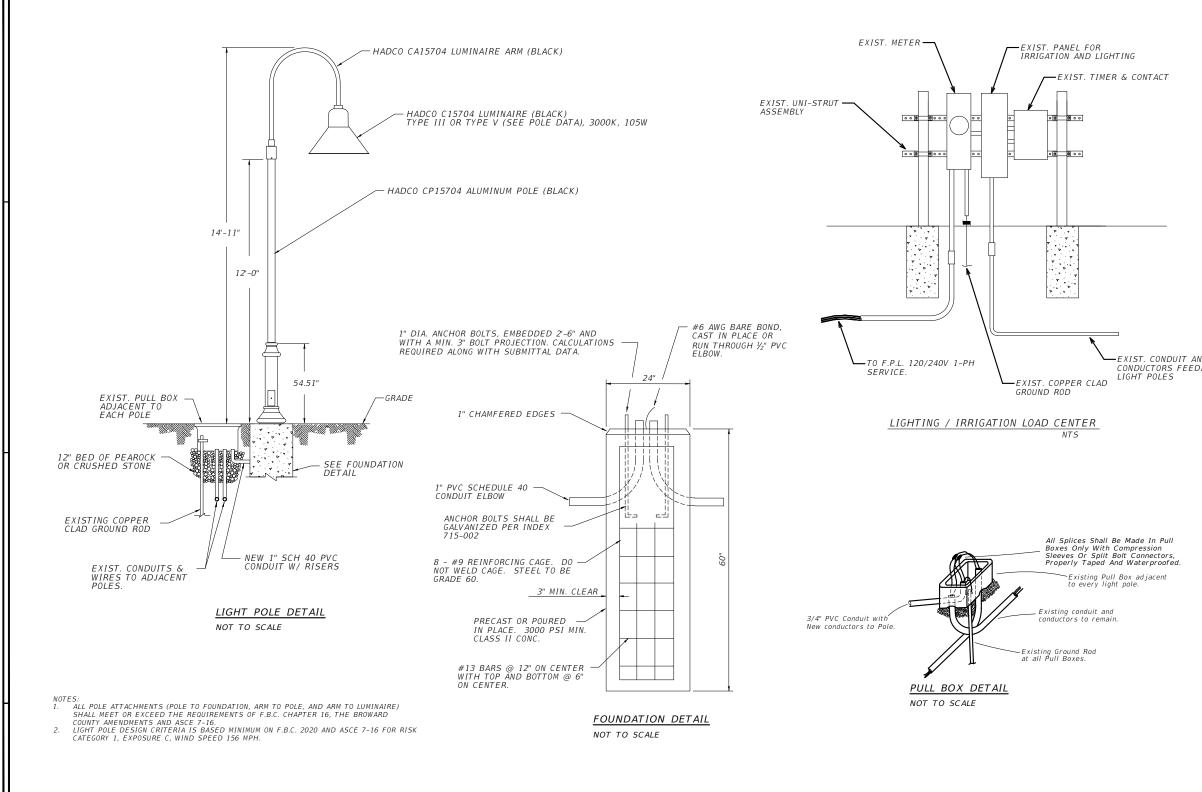

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			Engineers.Planners Bestsw.196TAVE.SUTE 302 PEABRONCE PNES.FL 33332 PH: 954-860-7771, FAX: 954-860-7771
ND DING			ELECTRICAL DETAILS DONALDSON PARK PARKING LOT LIGHTING CITY OF COCONUT CREEK 100% PLANS
			RJB Proj. No: 22038 Date: November 7, 2022 DESIGN: DRAWN: CHECK: RUDY REVISIONS: HM REVISIONS:
			SHEET NAME:
			E002
	consultant: RODOLFO HOYOS P.E. LICENSE NO. 47056	DATE:	SHEET 4 OF 4