I Mobile® stick together®

LAKE SIDE PARK

5555 REGENCY BLVD **COCONUT CREEK, FL 33073**

6FB1173B

ITF OVERLAY

SCOPE OF WORK DESIGN CRITERIA LOCAL MAP INDEX OF DRAWINGS DESIGN WIND SPEED: 170 MPH (3-SECOND GUST) SHT. REV. INSTALLATION OF NEW UNMANNED T-MOBILE DESCRIPTION EXPOSURE: NO TELECOMMUNICATIONS EQUIPMENT WITHIN EXISTING FENCED NO. RISK CATEGORY: COMPOUND AND REPLACEMENT ANTENNAS ON EXISTING TOWER. 0 T1 COVER SHEET OPEN STRUCTURE CONNECTIONS TO FXISTING POWER SUPPLY. 0 T2 NOTES CONTACTS C1 COMPOUND PLAN 0 EQUIPMENT PLANS 0 C2 **APPLICANT** PROPERTY SUMMARY C3 ANTENNA LAYOUTS 0 T-MOBILE USA 1300 CONCORD TERRACE C4 0 PROJECT **ELEVATION** PARCEL #: SUITE 200 4842-06-16-0012 SITE C5 DETAILS SUNRISE, FL 33323 LATITUDE: 26' 18' 36.20" N C6 CABINET MOUNTING DETAILS LONGITUDE: 80' 11' 58.10" W E1 ELECTRICAL PLAN AND NOTES 0 PROPERTY OWNER CONTACT: ZONING JURISDICTION: CITY OF COCONUT CREEK stick together ZONING CLASSIFICATION: RECREATIONAL 0 LANDLORD: CITY OF COCONUT CREEK E3 ELECTRICAL AND GROUNDING DETAILS 0 1300 CONCORD TERRACE LEGAL DESCRIPTION ADDRESS: 4800 WEST COPANS ROAD REGENCY LAKES AT COCONUT CREEK 157-23 B PART OF CITY, STATE, ZIP: COCONUT CREEK, FL 33063 PARCEL A DESC'D AS, COMM AT SW COR TR A OF SAWGRASS VICINITY MAP PK OF COMMERCE COMM SEC B,E 214.18,S 30,E 426,56 TO POB,E 144,31,N 285,03,E 254,66,S 99,99,E 438,79 TO P/I,SLY MORRISON HERSHFIELD Two South University Drive, Suite 245, Plantation, FL 33324 576.15,WLY & S 147.42,SLY 5.58,WLY 213.60,WLY 200, NLY 330.41 TO POB AKA: PARK SITE-REGENCY LAKES AT COCONUT CREEK **APPROVALS** APPLICABLE CODES PROPERTY OWNER PROJECT THE CONTRACTOR WORK SHALL COMPLY WITH ALL APPLICABLE NATIONAL, STATE, AND LOCAL CODES AS ADOPTED BY THE LOCAL AUTHORITY HAVING JURISDICTION (AHJ) OVER THE LOCATION. THE EDITION OF THE AHJ ADOPTED CODES AND STANDARDS IN 6FB1173B CONSTRUCTION EFFECT ON THE DATE OF CONTRACT AWARD SHALL GOVERN THE DESIGN. SITE ACQUISITION CONTRACTOR'S WORK SHALL COMPLY WITH THE LATEST EDITION TO THE FOLLOWING STANDARDS; ZONING 1. 2010 FLORIDA BUILDING CODE - BUILDING **NETWORK** NFPA 55 STANDARD FOR THE STORAGE USE, AND HANDLING OF COMPRESSED GASES & CRYOGENIC FLUIDS IN PORTABLE & STATIONARY CONTAINERS, CYLINDERS & TANKS - 2010 EDITION. **OPERATIONS** NFPA 853 - STANDARD OF INSTALLATION OF STATIONARY FUEL CELL POWER SYSTEMS - 2010 EDITION. CONTRACTOR Project No.: 4. 2010 FLORIDA BUILDING CODE - MECHANICAL **APPROVALS** 7123053 2010 FLORIDA BUILDING CODE FUEL GAS ASCE 7-10 DRIVING DIRECTIONS 7. ANSI/EIA/TIA-222-G. DESIGN BASED ON RFDS VERSION V1. FROM T-MOBILE'S OFFICE: HEAD NORTH THEN EAST ON SAWGRASS EXPY N FOR CONTRACTOR SHALL REQUEST 17.2 MILES TO US-441, HEAD NORTH FOR 1.1 MILES TO REGENCY LAKES BLVD, TURN RIGHT AND HEAD EAST FOR 0.1 MILES TO SITE ON LEFT SIDE OF THE ROAD NATIONAL ELECTRICAL CODE (NFPA 70-2008) ssue No.: T-MOBILE FOR CURRENT RFDS PRIOR FLORIDA FIRE PREVENTION CODE 2010. TO CONSTRUTION 0 10. CITY AND/OR COUNTY ORDINANCES.

ROBERT JERRY LARA REGISTERED ARCHITECT STATE OF FLORIDA

	Section of the sectio	5		
-	outo solutionessis	4		•
-	ON THE PROPERTY OF	3		•
١	SHAN SHAN SHAN SHAN SHAN	2		•
1	CONTRACTOR OF STREET	1		•
1	S. C.	0	10/10/12	ISSUED FOR PERMIT
	September 1990 September 1990	в	08/09/12	REVISED
		A	08/02/12	PRELIMINARY
	Minister Andrews	No.	Date	Action
	N. Optorete	Clie	nt:	

Tel: 954.577.4655 Fax: 954.577.4656 STATE OF FLORIDA CO# 00008508

LAKE SIDE PARK 5555 REGENCY BLVD COCONUT CREEK, FL 33073

COVER SHEET

08/02/12 Checked By: Client Approva Drawing No.

SCALE IS BASE ON 22" X 34" "D" SIZE


ARCHITECTURAL GENERAL NOTES ELECTRICAL GENERAL NOTES WORK SHALL COMPLY WITH ALL APPLICABLE CODES, ORDINANCES, AND REGULATIONS. ALL A. GENERAL NECESSARY LICENSES, CERTIFICATES, ETC., REQUIRED BY AUTHORITY HAVING JURISDICTION SHALL BE EXAMINE THE SITE CONDITIONS VERY CAREFULLY AND THE SCOPE OF PROPOSED WORK TOGETHER WITH PROCURED AND PAID FOR BY THE CONTRACTOR. THE WORK OF ALL OTHER TRADES AND INCLUDE IN THE PID PRICE ALL COSTS FOR WORK SUCH AS THE GENERAL CONTRACTOR AND EACH SUBCONTRACTOR SHALL BE RESPONSIBLE FOR VERIFYING EQUIPMENT AND WIRING MADE NECESSARY TO ACCOMMODATE THE ELECTRICAL SYSTEMS SHOWN AND DIMENSIONS AND CONDITIONS AT THE JOB SITE WHICH COULD AFFECT THE WORK UNDER THIS SYSTEMS OF OTHER TRADES. CONTRACT. ALL MANUFACTURERS RECOMMENDED SPECIFICATIONS, EXCEPT THOSE SPECIFICATIONS 2. OBTAIN ALL PERMITS, PAY ASSOCIATED FEES AND SCHEDULE INSPECTION. HEREIN, WHERE MOST STRINGENT SHALL BE COMPLIED WITH. THE CONTRACTOR SHALL VERIFY THAT NO CONFLICTS EXIST BETWEEN THE LOCATIONS OF ANY AND 3. PROVIDE ALL LABOR, MATERIAL, EQUIPMENT, INSURANCE. AND SERVICES TO COMPLETE THIS PROJECT IN ACCORDANCE WITH THE CONTRACT DOCUMENTS AND PRESENT IT AS FULLY OPERATIONAL TO THE ALL MECHANICAL. ELECTRICAL, PLUMBING, OR STRUCTURAL ELEMENTS, AND THAT ALL REQUIRED CLEARANCES FOR INSTALLATION AND MAINTENANCE ARE MET. NOTIFY THE CONSULTANT OF ANY SATISFACTION OF METRO-PCS & LAND/TOWER OWNER CONFLICTS. THE CONSULTANT HAS THE RIGHT TO MAKE MINOR MODIFICATIONS IN THE DESIGN OF PRIOR TO BEGINNING WORK COORDINATE ALL POWER AND TELCO WORK WITH THE LOCAL UTILITY THE CONTRACT WITHOUT THE CONTRACTOR GETTING ADDITIONAL COMPENSATION COMPANY AS IT MAY APPLY TO THIS SITE. ALL WORK TO COMPLY WITH THE RULES AND THE CONTRACTOR SHALL BE RESPONSIBLE FOR DAILY CLEAN UP OF ALL TRADES AND REMOVE ALL REGULATIONS OF THE UTILITIES INVOLVED GENERAL CONTRACTOR IS RESPONSIBLE FOR VED. DEBRIS FROM THE CONSTRUCTION SITE. AT THE COMPLETION OF THE PROJECT, THE CONTRACTOR REQUESTING CONNECTION OF COMMERCIAL POWER FROM THE POWER COMPANY. ELECTRICAL SHALL THOROUGHLY CLEAN THE BUILDING, SITE, AND ANY OTHER SURROUNDING AREAS TO A CONTRACTOR SHALL COORDINATE THIS WORK WITH THE GENERAL CONTRACTOR. BETTER THAN NEW CONDITION. THE CONTRACTOR IS RESPONSIBLE FOR ADEQUATELY BRACING AND PROTECTING ALL WORK DURING FABRICATION AND INSTALLATION OF THE COMPLETE ELECTRICAL SYSTEM SHALL BE DONE IN A FIRST CONSTRUCTION AGAINST DAMAGE, BREAKAGE, COLLAPSE, ETC. ACCORDING TO APPLICABLE CODES, CLASS WORKMANSHIP PER NECA STANDARD 1-2000 BY QUALIFIED PERSONNEL EXPERIENCED IN SUCH STANDARDS, AND GOOD CONSTRUCTION PRACTICES. WORK AND SHALL SCHEDULE THE WORK IN AN ORDERLY MANNER SO AS NOT TO IMPEDE PROGRESS OF WHERE ONE DETAIL IS SHOWN FOR ONE CONDITION, IT SHALL APPLY FOR ALL LIKE OR SIMILAR THE PROJECT. CONDITIONS, EVEN THOUGH NOT SPECIFICALLY MARKED ON THE DRAWINGS OR REFERRED TO IN B. BASIC MATERIALS AND METHODS THE SPECIFICATIONS. UNLESS NOTED OTHERWISE. 1. ALL ELECTRICAL WORK SHALL CONFORM TO THE EDITION OF THE NEC ACCEPTED BY THE LOCAL WHERE NEW PAVING, CONCRETE SIDEWALKS OR PATHS MEET EXISTING CONSTRUCTION, THE JURISDICTION AND TO THE APPLICABLE LOCAL CODES AND REGULATIONS. CONTRACTOR SHALL MATCH THE EXISTING PITCH, GRADE, AND ELEVATION SO THE ENTIRE FOUNDATION MOVEMENTS. STRUCTURE SHALL HAVE A SMOOTH TRANSITION. 2. ARRANGE CONDUIT, WIRING, EQUIPMENT, AND OTHER WORK GENERALLY AS SHOWN, PROVIDING PROPER CLEARANCES AND ACCESS. CAREFULLY EXAMINE ALL CONTRACT DRAWINGS AND FIT THE WORK IN EACH THE GENERAL CONTRACTOR SHALL OBTAIN WRITTEN CONFIRMATION OF THE EXPECTED DATE OF LOCATION WITHOUT SUBSTANTIAL ALTERATION. WHERE DEPARTURES ARE PROPOSED BECAUSE OF FIELD COMPLETION OF THE POWER CONNECTION FROM THE POWER COMPANY. CONDITIONS OR OTHER CAUSES, PREPARE AND SUBMIT DETAILED DRAWINGS FOR ACCEPTANCE. IF THE POWER COMPANY IS UNABLE TO PROVIDE THE POWER CONNECTION BY OWNER'S REQUIRED DATE. THE GENERAL CONTRACTOR SHALL PROVIDE AND MAINTAIN A TEMPORARY GENERATOR UNTIL THE CONTRACT DRAWINGS ARE GENERALLY DIAGRAMMATIC AND ALL OFFSETS. BENDS. FITTINGS AND THE POWER COMPANY CONNECTION IS COMPLETED. COSTS ASSOCIATED WITH THE TEMPORARY ACCESSORIES ARE NOT NECESSARILY SHOWN. PROVIDE ALL SUCH ITEMS AS MAY BE REQUIRED TO GENERATOR TO BE APPROVED BY THE OWNER. FIT THE WORK TO THE CONDITIONS. ALL HIS PRACTICAL TRADES. O. PLANS PART OF THIS SET ARE COMPLEMENTARY, INFORMATION IS NOT LIMITED TO ONE PLAN. 4. SEAL AROUND CONDUITS AND AROUND CONDUCTORS WITHIN CONDUITS ENTERING THE MODULAR DRAWINGS AND SPECIFICATIONS ARE INSTRUMENTS OF SERVICE AND SHALL REMAIN THE PROPERTY OF CABINETS WHERE PENETRATION OCCURS WITH A SILICONE SEALANT TO PREVENT MOISTURE PENETRATION THE ARCHITECT, WHETHER THE PROJECT FOR WHICH THEY ARE MADE IS EXECUTED OR NOT. THEY ARE NOT TO BE USED BY THE OWNER ON OTHER PROJECTS OR EXTENSION TO THIS PROJECT C. CONDUCTORS AND CONNECTORS EXCEPT BY AGREEMENT IN WRITING AND WITH APPROPRIATE COMPENSATION TO MORRISON HERSHFIELD. 1. UNLESS NOTED OTHERWISE, ALL CONDUCTORS SHALL BE COPPER, MINIMUM SIZE #12 AWG, WITH THESE PLANS WERE PREPARED TO BE SUBMITTED TO GOVERNMENTAL BUILDING AUTHORITIES FOR COORDINATE IN FIELD THERMOPLASTIC INSULATION CONFORMING TO NEMA WC5 OR CROSS-LINKED POLYETHYLENE INSULATION REVIEW FOR COMPLIANCE WITH APPLICABLE CODES AND IT IS THE SOLE RESPONSIBILITY OF THE CONFORMING TO NEMA WC7. (TYPES THHN), INSULATION SHALL BE RATED FOR 90 DEG. CONDUCTORS OWNER AND/OR CONTRACTOR TO BUILD ACCORDING TO APPLICABLE BUILDING CODES. SHALL BE COLOR CODED IN ACCORDANCE WITH NEC. 11. IF CONTRACTOR OR SUB-CONTRACTOR FIND IT NECESSARY TO DEVIATE FROM ORIGINAL APPROVED PLANS. THEN IT IS THE CONTRACTOR'S AND THE SUB-CONTRACTOR'S RESPONSIBILITY TO PROVIDE CONDUCTOR LENGTHS SHALL BE CONTINUOUS FROM TERMINATION TO TERMINATION WITHOUT SPLICES. THE ARCHITECT WITH 4 COPIES OF THE PROPOSED CHANGES FOR HIS APPROVAL BEFORE PROCEEDING SPLICES ARE NOT ACCEPTABLE. IF SPLICES ARE UNAVOIDABLE PRIOR APPROVAL FROM THE ENGINEER MUST BE OBTAINED. WITH THE WORK. IN ADDITION THE CONTRACTOR AND SUB-CONTRACTORS SHALL BE RESPONSIBLE FOR PROCURING ALL NECESSARY APPROVALS FROM THE BUILDING AUTHORITIES FOR THE PROPOSED CHANGES BEFORE PROCEEDING WITH THE WORK, THE CONTRACTOR AND SUB-CONTRACTORS SHALL BE RESPONSIBLE FOR PROCURING ALL NECESSARY INSPECTIONS AND APPROVALS FROM BUILDING 1. ALL LIGHTNING PROTECTION GROUNDING OF THE ELECTRICAL EQUIPMENT SHALL BE CARRIED OUT IN AUTHORITIES DURING THE EXECUTION OF THE WORK. ACCORDANCE WITH THE CURRENT NFPA STANDARDS. 2. ALL GROUND LUG AND COMPRESSION CONNECTIONS SHALL BE COATED WITH ANTI-OXIDANT AGENT. 12. IN EVERY EVENT, THESE CONSTRUCTION DOCUMENTS AND SPECIFICATIONS SHALL BE INTERPRETED TO BE A MINIMUM ACCEPTABLE MEANS OF CONSTRUCTION BUT THIS SHALL NOT RELIEVE THE SUCH AS NO-OX, NOALOX, PENETROX OR KOPRSHIELD. CONTRACTOR, SUB-CONTRACTOR, AND/OR SUPPLIER/MANUFACTURER FROM PROVIDING A COMPLETE 3. ALL EXTERIOR GROUNDING CONDUCTORS INCLUDING EXTERIOR GROUND RING SHALL BE #2 AWG SOLID AND CORRECT JOB WHEN ADDITIONAL ITEMS ARE REQUIRED TO THE MINIMUM SPECIFICATION. IF ANY BARE TINNED COPPER, MAKE ALL GROUND CONNECTIONS AS SHORT AND DIRECT AS POSSIBLE, AVOID ITEMS NEED TO EXCEED THESE MINIMUM SPECIFICATIONS TO PROVIDE A COMPLETE, ADEQUATE AND SHARP BENDS. THE RADIUS OF ANY BEND SHALL NOT BE LESS THAN 8" AND THE ANGLE OF ANY BEND SAFE WORKING CONDITION, THEN IT SHALL BE THE DEEMED AND UNDERSTOOD TO BE INCLUDED IN SHALL NOT EXCEED 90°, GROUNDING CONDUCTORS SHALL BE ROUTED DOWNWARD TOWARD THE BURIED THE DRAWINGS. FOR EXAMPLE, IF AN ITEM AND/OR PIECE OF EQUIPMENT REQUIRES A LARGER WIRE GROUND RING SIZE (I.E. ELECTRICAL WIRE). STRONGER OR LARGER PIPING, INCREASED QUANTITY (I.E. STRUCTURAL 4. REPAIR ALL GALVANIZED SURFACES THAT HAVE BEEN DAMAGED BY THERMO-WELDING WITH ERICO ELEMENTS), REDUCED SPACING, AND/OR INCREASED LENGTH (I.E. BOLT LENGTHS, BAR LENGTHS) T-319 GALVANIZING BAR. THEN IT SHALL BE DEEMED AND UNDERSTOOD TO BE INCLUDED IN THE BID/PROPOSAL. THESE DOCUMENTS ARE MEANT AS A GUIDE AND ALL ITEMS REASONABLY INFERRED SHALL BE DEEMED TO 5. ALL EXTERNAL GROUND CONNECTIONS SHALL BE EXOTHERMICALLY WELDED. ALL EXOTHERMIC WELDS BE INCLUDED. TO EXTERIOR GROUND RING SHALL BE THE PARALLEL TYPE, EXCEPT FOR THE GROUND RODS WHICH 13. THESE CONTRACT DOCUMENTS AND SPECIFICATIONS SHALL NOT BE CONSTRUED TO CREATE A ARE TEE EXOTHERMIC WELDS. REPAIR ALL GALVANIZED SURFACES THAT HAVE BEEN DAMAGED BY CONTRACTUAL RELATIONSHIP OF ANY KIND BETWEEN THE ARCHITECT AND THE CONTRACTOR. EXOTHERMIC WELDING, USE SPRAY GALVANIZER SUCH AS HOLUB LECTROSOL #15-501.

COMPOUND NOTES

- 1. THE MINIMUM LOWEST FIRST FLOOR ELEVATION SHALL NOT BE LESS THAN 4" ABOVE CROWN OF ROAD OR THE FEDERAL AND/OR COUNTY FLOOD CRITERIA ELEVATION, WHICHEVER IS HIGHER, CONTRACTOR SHALL SUBMIT AN ELEVATION CERTIFICATE (IF REQUIRE BY THE JURISDICTION) UPON COMPLETION OF PROJECT.
- WORK OUTSIDE OF THE PROPERTY LINE INCLUDED IN THIS SET OF DRAWINGS SHALL BE. BUT NOT LIMITED TO, DRIVEWAYS, SODDING TO ASPHALT LINE AND UTILITY CONNECTIONS.
- EXISTING TREES WITHIN CONSTRUCTION FOOTPRINT SHALL BE REMOVED AND PROPERLY DISPOSED OF. CONTRACTOR SHALL PROCURE PERMIT PRIOR TO REMOVAL.
- CONTRACTOR AND SUBCONTRACTORS SHALL VERIFY ALL UTILITY SERVICE CONNECTION LOCATIONS PRIOR TO SUBMITTING BID AND PROCEEDING WITH WORK, IT IS RECOMMENDED THAT THE CONTRACTOR VISIT THE SITE AND VERIFY ALL DIMENSIONS AND NOTES BEFORE SUBMITTING BID AND PROCEEDING WITH WORK.
- SOIL AT THIS SITE IS UNDISTURBED ROCK AND SAND ADEQUATE OF SUPPORTING THE DESIGN LOAD OF 2000 P.S.F. IF OTHER CONDITIONS ARE ENCOUNTERED, NOTIFY MIRRISON HERSHFIELD BEFORE PROCEEDING WITH WORK. THIS VALUE IS CONSIDERED SAFE WITH RESPECT TO ACTUAL FAILURE OF THE SUPPORTING GROUND, BUT DOES NOT NECESSARILY ENSURE THE PREVENTION OF EXCESSIVE
- 6. BURY PHONE, AND ELECTRIC SERVICE NO LESS THAN 24" BELOW FINISH GRADE WITH 1'-0" RADIUS SAND BACKFILL AROUND PIPES. COORDINATE W/ ELECTRICAL DRAWINGS.
- 7. IN ORDER TO AVOID ANY CONFLICTS, CONTRACTOR SHALL COORDINATE
- THE POWER CABINET MUST BE CLEAR OF FLAMMABLE MATERIAL WITHIN 12 INCHES OF THE CABINET, INCLUDING ABOVE THE CABINET.
- EXHAUST OUTLETS MUST BE LOCATED AT LEAST 10 FEET FROM ANY HVAC AIR INTAKES, WINDOWS, DOORS, AND OTHER OPENINGS INTO A BUILDING
- 10. THE POWER CABINET MUST BE MOUNTED ON THE FOUNDATION TO ALLOW WATER TO DRAIN FROM THE DRAIN OUTLET AND AWAY FROM THE CABINET.
- 11. TO ENSURE SERVICEABLE ABILITY, THE DOORS OF CABINETS WILL REQUIRE AN OPENING RADIUS OF 36 INCHES OF CLEARANCE FROM THE CLOSED POSITION TO THE OPEN POSITION.

DO NOT SCALE DRAWINGS, CONTRACTOR MUST VERIFY ALL DIMENSIONS AND ADVISE CONSULTANTS OF ANY ERRORS OR OMISSIONS, NO VARIATIONS OR MODIFICATIONS TO WORK SHOWN SHAUL BE IMPLEMENTED WITHOUT PRIOR WRITTEN APPROVIA. ALL PREVIOUS ISSUES OF THIS DRAWING ARE PERSEDED BY THE LATEST REVISION, ALL DRAWING D. SPECIFICATIONS REMAIN THE PROPERTY OF

ROBERT JERRY LARA REGISTERED ARCHITECT STATE OF FLORIDA AR92824

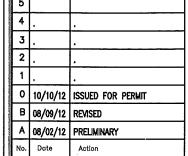

stick together

1300 CONCORD TERRACE SUNRISE, FL, 33323

MORRISON HERSHFIELD Two South University Drive, Suite 245, Plantation FL 33324 Tel: 954.577.4655 Fax: 954.577.4656 STATE OF FLORIDA CO# 00008508

LAKE SIDE PARK 6FB1173B COCONUT CREEK, FL 33073

NOTES

7123053 08/02/12 Drawn By Checked By: PM Review Client Approval CM Issue No.: Drawing No. 0 T-2

PROJECT INFORMATION

2, THIS FACILITY WILL CONSUME NO UNRECOVERABLE ENERGY AND IS EXEMPT FROM THE FLORIDA ENERGY REVIEW CODE.

OF RADIO SIGNALS FOR THE PURPOSE OF PROVIDING PUBLIC CELLULAR SERVICE.

1. THIS IS AN UNMANNED AND RESTRICTED ACCESS EQUIPMENT AND WILL BE USED FOR THE TRANSMISSION

- 3. NO POTABLE WATER SUPPLY IS TO BE PROVIDED AT THIS LOCATION.
- 4. NO WASTE WATER WILL BE GENERATED AT THIS LOCATION.
- 5. NO SOLID WASTE WILL BE GENERATED AT THIS LOCATION.
- 6. T-MOBILE MAINTENANCE CREW (TYPICALLY ONE PERSON) WILL MAKE AN AVERAGE OF ONE TRIP PER MONTH AT ONE HOUR PER VISIT.
- 1. RESTORE EXISTING ASPHALT AND/OR CONCRETE COMPOUND TO IT'S ORIGINAL CONDITION

SITE GENERAL NOTES

2. CONTRACTOR SHALL DETECT AND MARK ANY UNDERGROUND LINES. PIPING, PRIOR TO START OF EXCAVATION

IMPORTANT NOTICE

THE EXISTING CONDITIONS REPRESENTED HEREIN ARE BASED ON VISUAL OBSERVATIONS AND INFORMATION

PROVIDED BY OTHERS, MORRISON HERSHFIELD CORPORATION CANNOT GUARANTEE THE CORRECTNESS NOR

CONTRACTOR AND HIS SUB-CONTRACTORS SHALL VISIT THE SITE AND VERIFY ALL EXISTING CONDITIONS AS

COMPLETENESS OF THE EXISTING CONDITIONS SHOWN AND ASSUMES NO RESPONSIBILITY THEREOF,

CONSULTANT PRIOR TO CONSTRUCTION.

REQUIRED FOR PROPER EXECUTION OF PROJECT. REPORT ANY CONFLICTS OR DISCREPANCIES TO THE

SCALE IS BASE ON 22" X 34" "D" SIZE

TRUE NORTH EXISTING T-MOBILE UTILITY -H-FRAME W/ METER, DISCONNECT, PPC AND FIBER CABINET EXISTING ±125'-0" HIGH-MONOPOLE TOWER EXISTING EQUIPMENT CABINET -ON CONCRETE PAD 1 2 C-2 C-2 EXISTING SPRINT/NEXTEL EQUIPMENT SHELTER EXISTING T-MOBILE FCOA EQUIPMENT CABINET Xummunimming magammini EXISTING T-MOBILE GSM EXISTING -EQUIPMENT CABINET (TYP. OF 3) EXISTING T-MOBILE COAX BRIDGE EXISTING AT&T/T-MOBILE EXISTING ACCESS GATE (TYP. OF 3) SHARED COAX BRIDGE EXISTING CHAIN-LINK -EXISTING T-MOBILE TRIPLE BASE FENCE PLINTH ON CONCRETE PAD Zummummmm - EXISTING GENERATOR ON CONCRETE PAD EXISTING ASPHALT AREA EXISTING AT&T EQUIPMENT SHELTER A/C A/C

DO NOT SCALE DRAWINGS. CONTRACTOR MUST VERIEY ALL DIMENSIONS AND ADVISE CONSULTANTS OF ANY ERRORS OR OMISSIONS. NO VARANTONS OR MODIFICATIONS TO WORK SHOWN SHALL BE IMPLEMENTED WITHOUT PRIOR WRITTEN APPROVAL ALL PREVIOUS ISSUES OF THIS DRAWING SENDER OF THIS DRAWINGS AND SPECIFICATIONS REMAIN THE PROPERTY OF MORRISON HERSHFIELD CORPORATION, NEITHER MORRISON HERSHFIELD NOR THE ARCHITECT WILL BE PROVIDING CONSTRUCTION REVIEW OF THIS PROJECT.

ROBERT JERRY LARA REGISTERED ARCHITECT STATE OF FLORIDA AR92824

3 2

0 10/10/12 ISSUED FOR PERMIT

B 08/09/12 REVISED A 08/02/12 PRELIMINARY No. Date

T Mobile

stick together 1300 CONCORD TERRACE SUITE 200 SUNRISE, FL. 33323

MORRISON HERSHFIELD Two South University Drive, Suite 245, Plantation, FL 33324 Tel: 954.577.4655 Fax: 954.577.4656 STATE OF FLORIDA CO# 00008508 www.morrisonhershfield.com

LAKE SIDE PARK 6FB1173B 5555 REGENCY BLVD COCONUT CREEK, FL 33073

Drawing Title:


COMPOUND PLAN


Project No.: 7123053	
Designer: RL	Date: 08/02/12
Drawn By: XL	Checked By:
PM Review: CM	Client Approval
Issue No.:	Drawing No.
0	C-1


SCALE IS BASE ON 22" X 34" "D" SIZE

COMPOUND PLAN

24"x36" SCALE: 1/4" = 1'-0" 11"x17" SCALE: 1/8" = 1'-0"

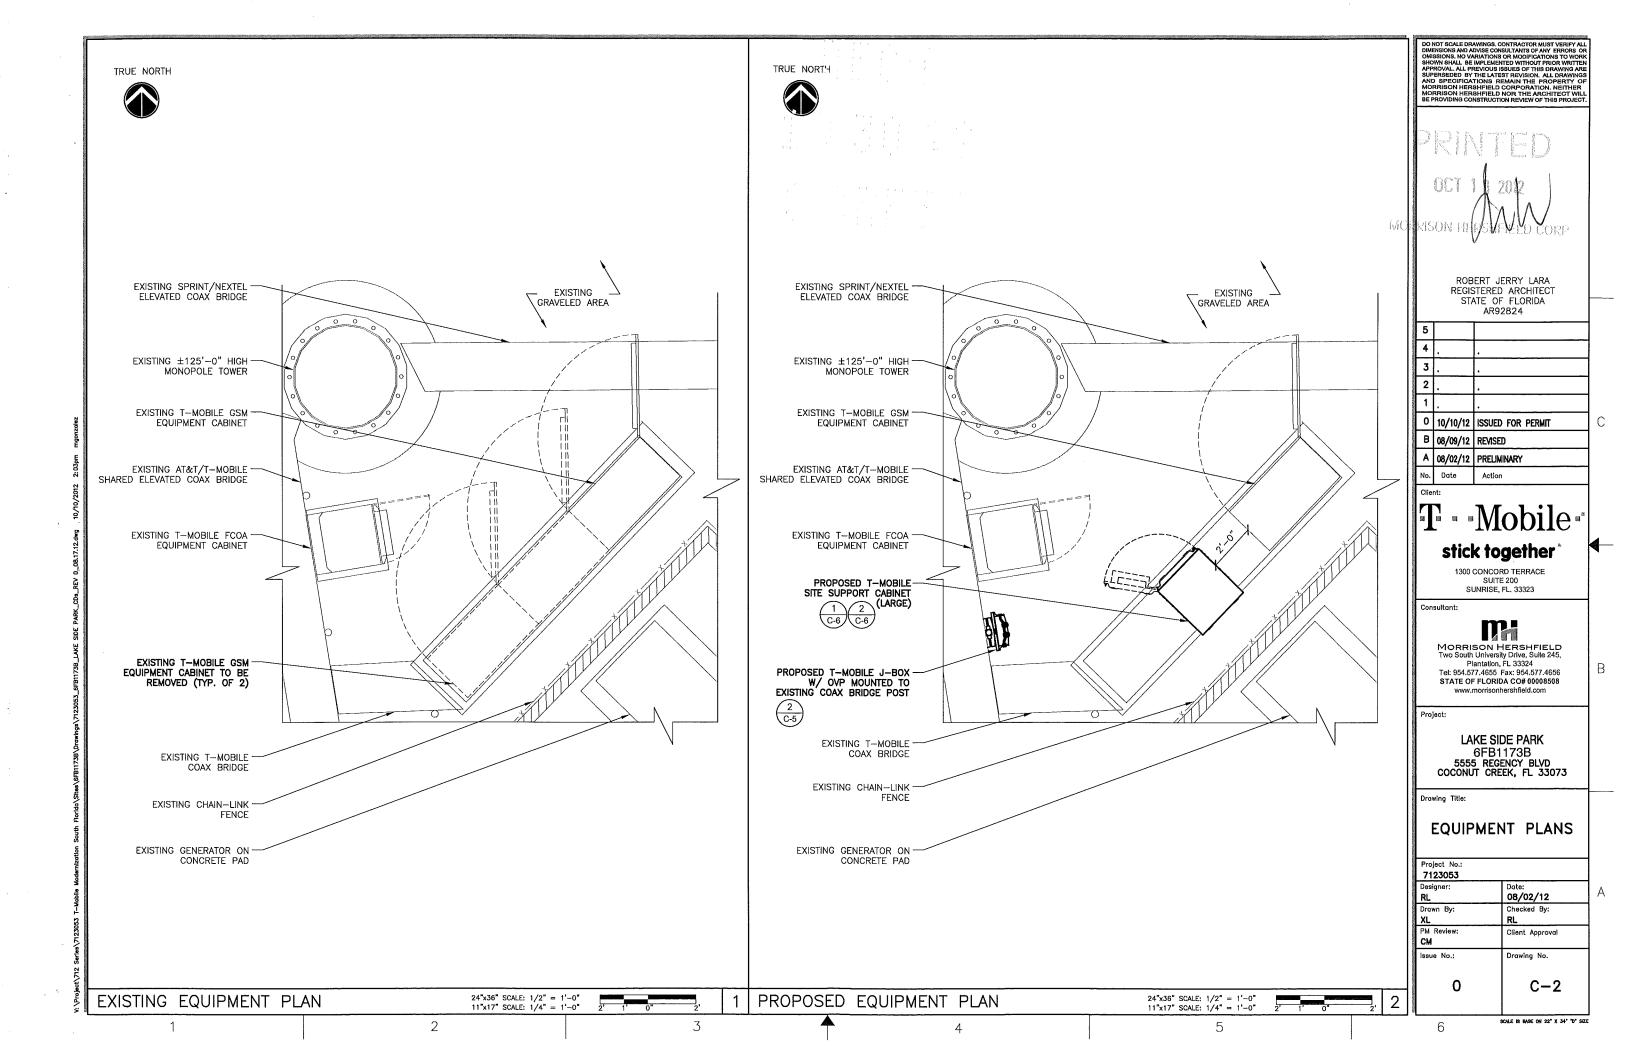

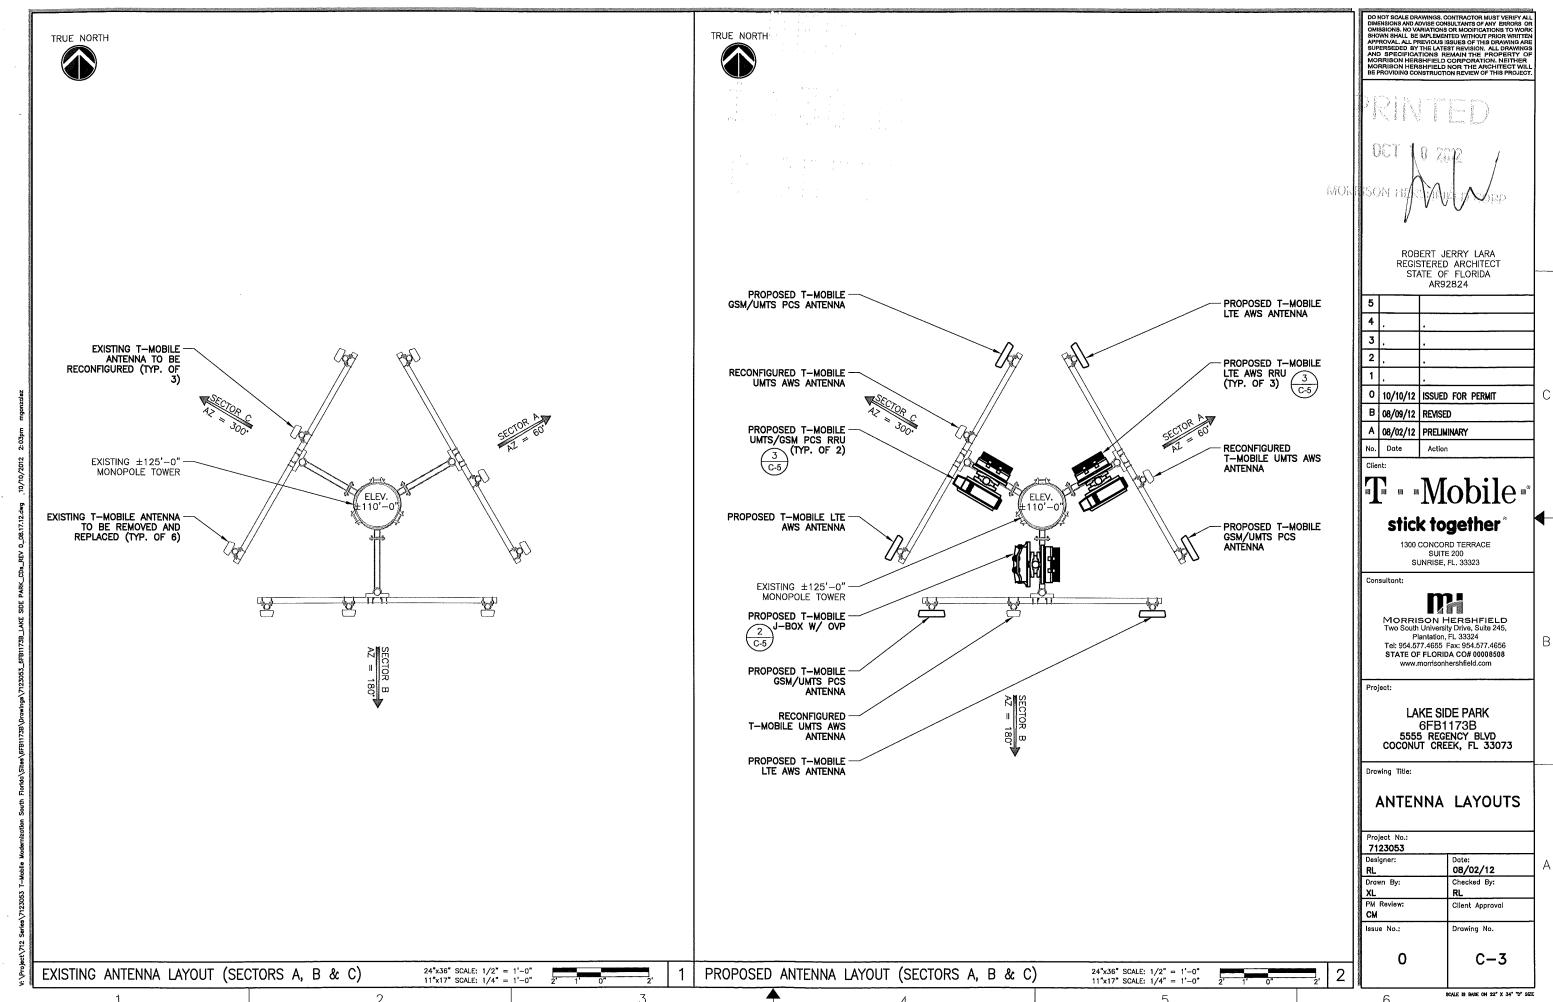

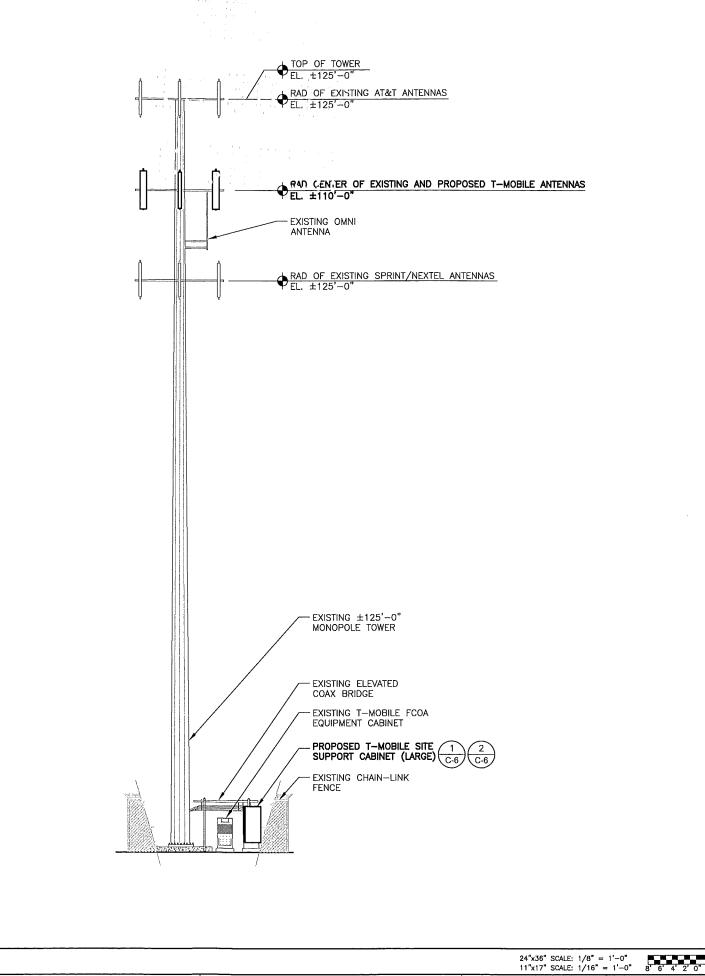

nization South Florida\Sites\6FB11738\Drawings\7123053_6FB1173B_LAKE SIDE PARK_C0s_REV 0_08.17.12

NOTE:

NO WORK SHALL COMMENCE WITHOUT THE APPROVED TOWER/ANTENNA MOUNT STRUCTURAL ANALYSIS REPORT SIGNED AND SEALED BY A LICENSED PROFESSIONAL ENGINEER UNDER SEPARATE COVER. IF REQUIRED, THE CONTRACTOR SHALL MODIFY TOWER AND/OR ANTENNA MOUNTS AS INDICATED IN THE ABOVE MENTIONED STRUCTURAL REPORT OR ASSOCIATED MODIFICATION DESIGN DRAWINGS.

DO NOT SCALE DRAWINGS. CONTRACTOR MUST VERIFY ALL DIMENSIONS AND ADVISE CONSULTANTS OF MAY ERRORS OR OMISSIONS. NO VARIATIONS OR MODIFICATIONS TO WORK SHOWN SHALL BE IMPLEMENTED WITHOUT FRIOR WRITTEN APPROVAL. ALL PREVIOUS ISSUES OF THIS DRAWINGS ARE SUPERSEDED BY THE LATEST REVISION. ALL DRAWINGS AND SPECIFICATIONS REMAIN THE PROPERTY OF MORRISON HERSHFIELD CORPORATION. NEITHER MORRISON HERSHFIELD NOR THE ARCHITECT WILL BE PROVIDING CONSTRUCTION REVIEW OF THIS PROJECT.

PRINTED

OCH O 2012

RRISON WERSMENELD CORP

ROBERT JERRY LARA REGISTERED ARCHITECT STATE OF FLORIDA AR92824

Client:

T Mobile

stick together

1300 CONCORD TERRACE SUITE 200 SUNRISE, FL. 33323

Consultani

MORRISON HERSHFIELD Two South University Drive, Suite 245, Plantation, FL 33324 Tel: 954.577.4655 Fax: 954.577.4656 STATE OF FLORIDA CO# 00008508

Project

LAKE SIDE PARK
6FB1173B
5555 REGENCY BLVD
COCONUT CREEK, FL 33073

Drawing Title:

ELEVATION

ELEVATION

2


7


1

5

6

SCALE IS BASE ON 22" X 34" "D" SIZE

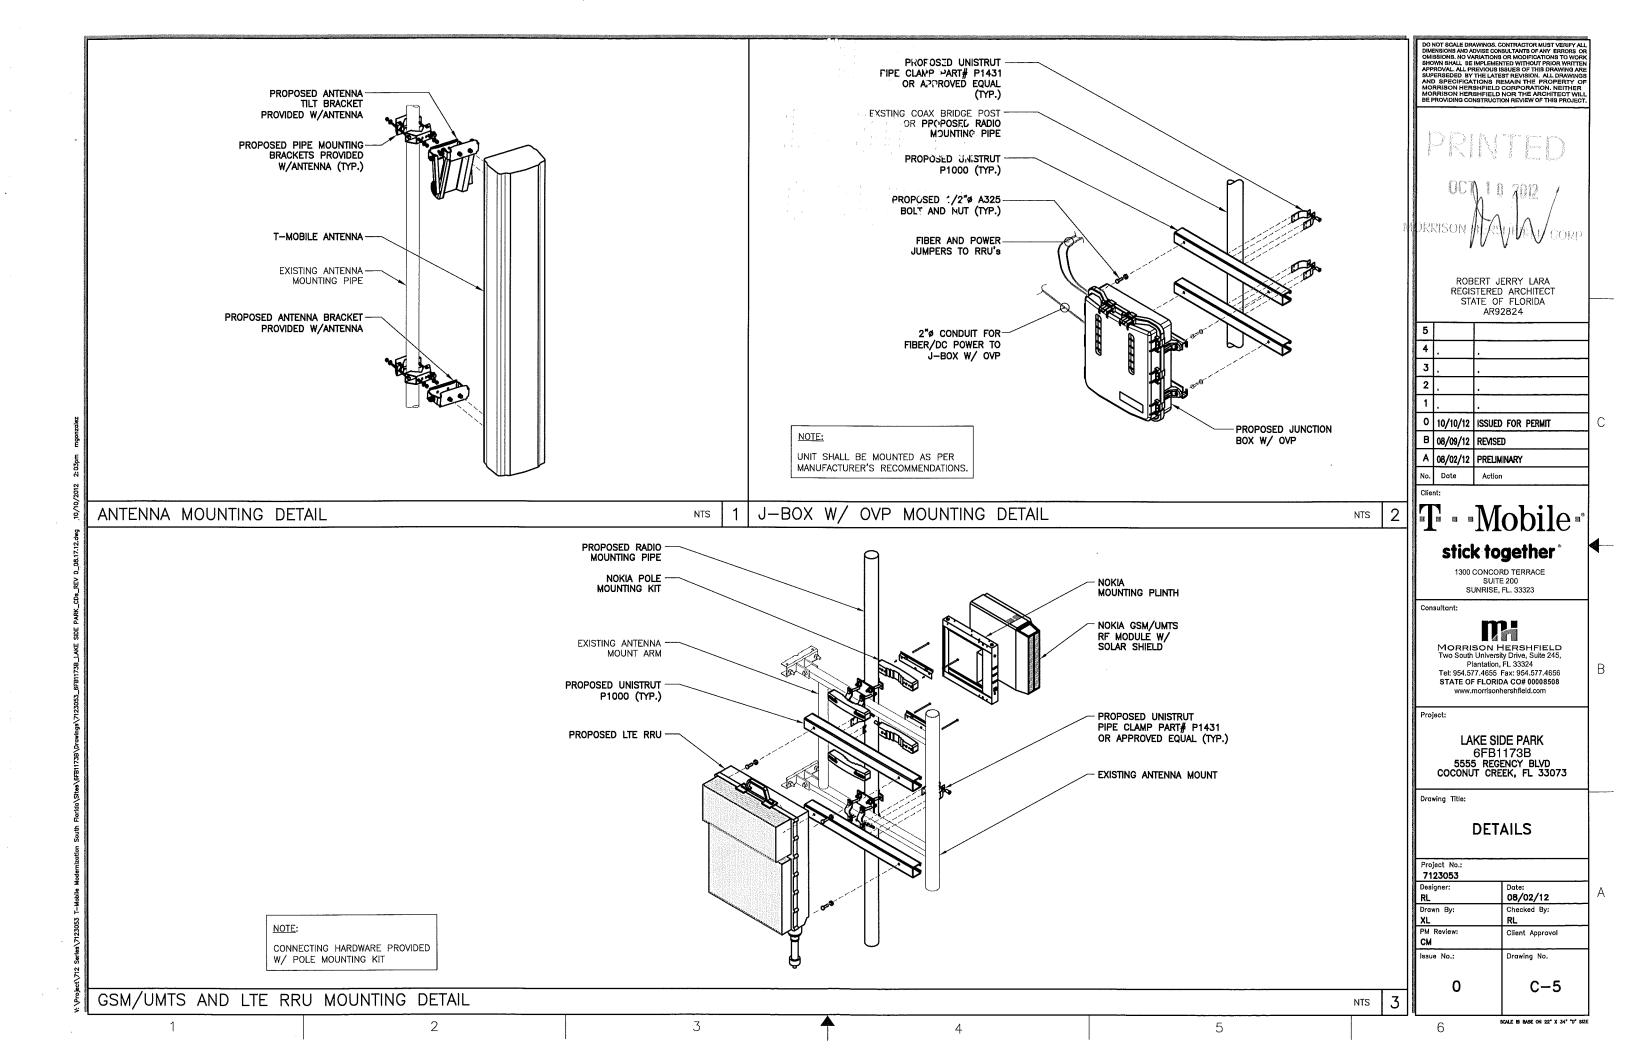

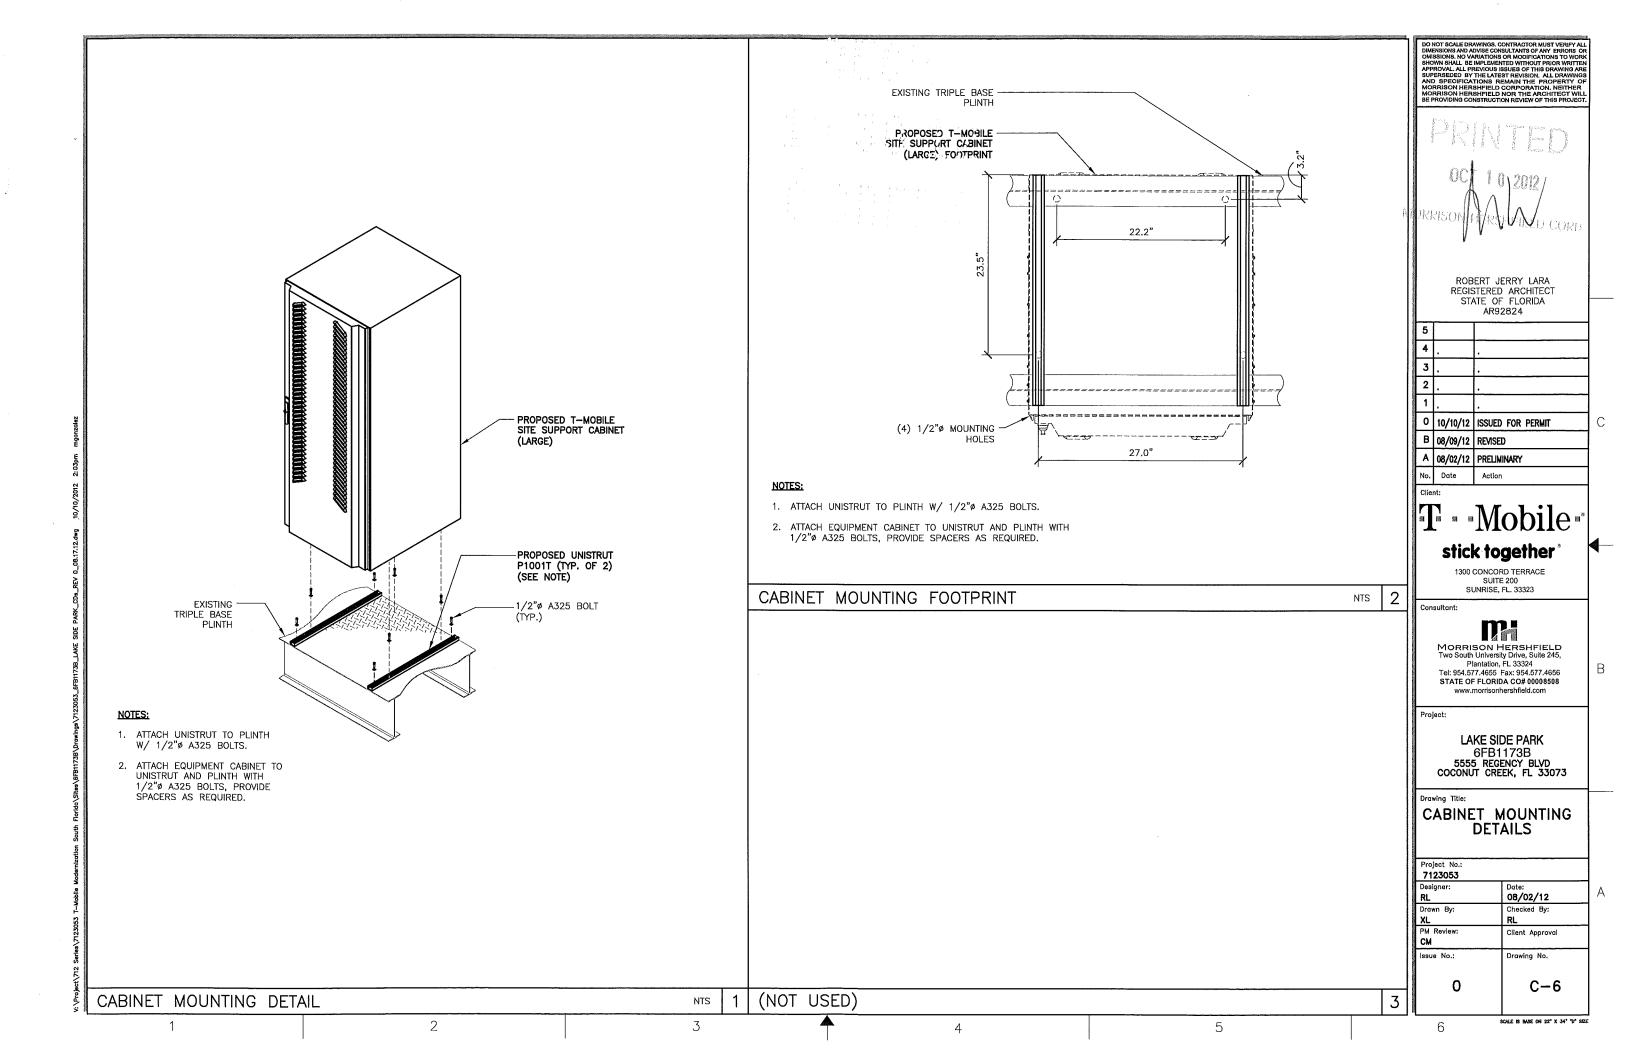


REFERENCE NOTES

- (1) EXISTING T-MOBILE 200A, 240V, 3W, UTILITY METER
- EXISTING T-MOBILE 200A, 2-POLE, SERVICE MAIN FUSED DISCONNECT SWITCH
- 3 EXISTING T-MOBILE 200A RATED, 120/240-10-3W PPC CABINET
- 4 EXISTING T-MOBILE FIBER CABINET
- (5) EXISTING T-MOBILE FCOA EQUIPMENT CABINET
- (6) EXISTING T-MOBILE GSM EQUIPMENT CABINET
- 7 PROPOSED T-MOBILE SITE SUPPORT CABINET
- 8 PROPOSED 2" RNC B.F.G. AND RMC A.F.G. FOR ALARM
- 9 PROPOSED EMPTY 2" RNC B.F.G. AND RMC A.F.G.
- PROPOSED 2" RNC B.F.G. AND RMC A.F.G. FOR DC POWER
- PROPOSED 2" RNC B.F.G. AND RMC A.F.G. EQUIPPED WITH (3) #3 AWG CU. AND (1) #8 AWG CU. GROUND FOR SITE SUPPORT CABINET.
- PROPOSED 100A-2P BRANCH CIRCUIT BREAKER FOR SITE SUPPORT CABINET. MATCH EXISTING AIC RATING

TRUE NORTH



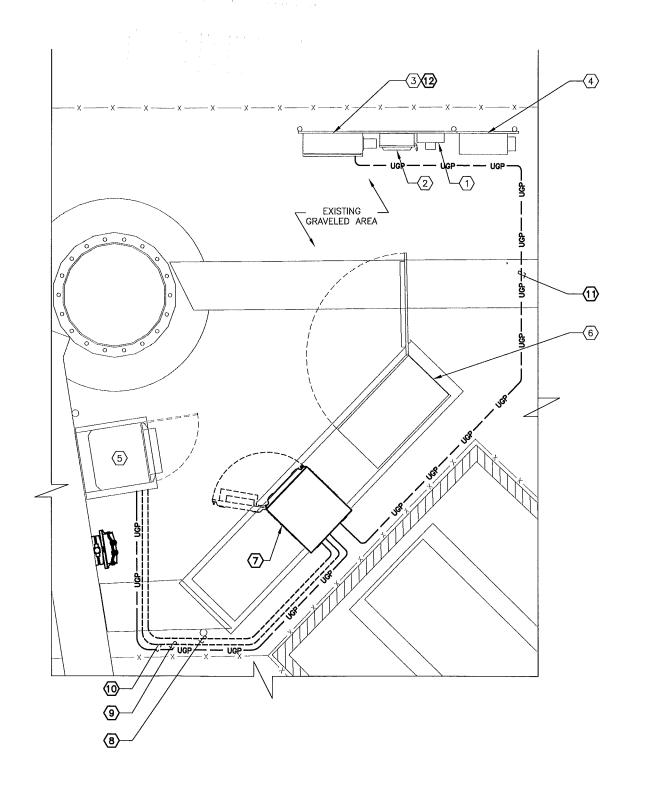

DO NOT SCALE DRAWINGS, CONTRACTOR MUST VERIEF ALL DIMENSIONS AND ADVISE CONSULTANTS OF ANY ERRORS OR OMISSIONS, NO VARATIONS OR MODIFICATIONS TO WORK SHOWN SHALL BE IMPLEMENTED WITHOUT PRIOR WRITTEN APPROVAL ALL PREVIOUS ISSUES OF THIS DRAWING ARE SUPERSEDED BY THE LATEST REVISION. ALL DRAWINGS AND SPECIFICATIONS REMAIN THE PROPERTY OF MORRISON HERSHFIELD CORPORATION, NEITHER MORRISON HERSHFIELD NOR THE ARCHITECT WILL BE PROVIDING CONSTRUCTION REVIEW OF THIS PROJECT.

RRISON HERSHFILLD CORP

ROBERT JERRY LARA REGISTERED ARCHITECT STATE OF FLORIDA AR92824

- 2 0 10/10/12 ISSUED FOR PERMIT
- B 08/09/12 REVISED A 08/02/12 PRELIMINARY
- No. Date

T Mobile

stick together

1300 CONCORD TERRACE SUITE 200 SUNRISE, FL. 33323

MORRISON HERSHFIELD Two South University Drive, Suite 245, Plantation, FL 33324 Tel: 954.577.4655 Fax: 954.577.4656 STATE OF FLORIDA CO# 00008508

В

LAKE SIDE PARK 6FB1173B 5555 REGENCY BLVD COCONUT CREEK, FL 33073

Drawing Title:


ELECTRICAL PLAN AND NOTES

Project No.: 7123053 08/02/12 Checked By: Drawn By: Client Approval CM Issue No.: Drawing No. E-1

ELECTRICAL PLAN

SCALE IS BASE OH 22" X 34" "D" SIZE

24"x36" SCALE: 1/2" = 1'-0" 11"x17" SCALE: 1/4" = 1'-0"

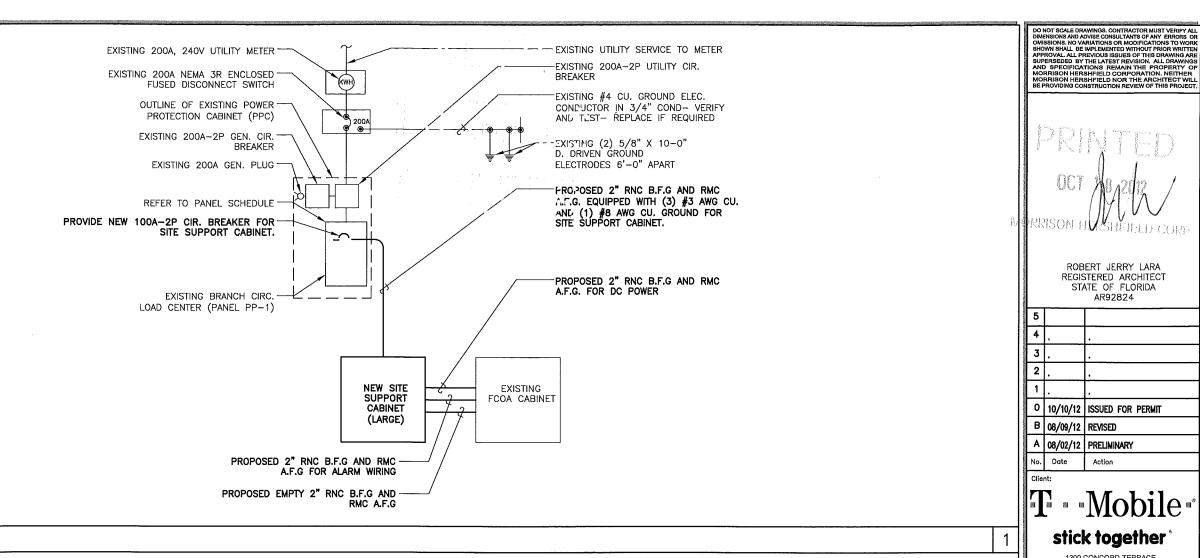

AC ONE-LINE DIAGRAM

BUS VA		LOAD		GND	COND	AMDO		BUS		AMPO	CONID	OND	wor	Loss	BUS VA	
A	В	LOAD		GND	COND	AMPS		A B		AMP5	COND	GND	WRE	LOAD	Α	В
2880		EXISTING 2102 BTS	E	Ε	E	30	1 -	•	- 2	30	E	E	E	EXISTING SURGE SUPPRESSOR	0	
	2880						3 -	+	- 4							0
_		SPARE**	_	_	-	30	5 -	+	- 6	30	-	-	-	SPARE**	_	
	_						7 -	+	- 8							
180		EXISTING GFI RECEPTACLE	E	E	E	20	9 -	+	– 10	20	-	_	-	SPARE**	_	
		SPACE			_		11 -	+	- 12							
_		SPACE					13 -	+	- 14	100	2"	#8	#3	NEW SITE SUPPORT CABINET	4800	
		SPACE			-		1 ``	1 1	- 16							480
		SPACE				_	17 -	I	- 18		_	_		SPACE		
	-	SPACE					1	+-			_		_	SPACE		
		SPACE			-		1	•						SPACE	_	
		SPACE			-	_	23 -		- 24		_	_	_	SPACE		
TOTAL VA			ED VA: 155					IPERES		JS A 6		us в 6		TOTAL 65		
RATED VO		☐ 120/208 ■ 120/240 ☐ 277			3 WIRE				POL	ES	□ 12	□ 18	□ 20	■ 24 □ 30 □ 36 □ 42		
RATED AM	IPS: L	100 200 400	CABIN		SURF			FLUSH								
TULL NEU	TRAL BUS	GROUND BUS	D DOOR		KEYED D	OOR LA	TCH		ENCLO	SURE T	YPE N	EMA-	3R			
BRANCH [DEVICES	☐ FUSED ☐ CIRCUIT BREAKER														
☐ MAIN	LUGS ONL	Y MAIN 200 III BREAKI	R 🗆 FI	JSED SY	MTCH	- 1										

NOTE: E = EXISTING

** = EXISTING CIRCUIT REMOVED CREATING NEW SPARE BREAKER

PANEL SCHEDULE

0 10/10/12 ISSUED FOR PERMIT B 08/09/12 REVISED A 08/02/12 PRELIMINARY No. Date T Mobile stick together 1300 CONCORD TERRACE SUITE 200 SUNRISE, FL. 33323 MORRISON HERSHFIELD Two South University Drive, Suite 245, Plantation, FL 33324 Tel: 954.577.4655 Fax: 954.577.4656 STATE OF FLORIDA CO# 00008508 LAKE SIDE PARK 6FB1173B 5555 REGENCY BLVD COCONUT CREEK, FL 33073 Drawing Title: **ELECTRICAL DETAILS** Project No.: 7123053 08/02/12 Checked By: PM Review: Client Approval Issue No.: Drawing No. E-2

ROBERT JERRY LARA REGISTERED ARCHITECT STATE OF FLORIDA AR92824

6

CM

